ADDENDUM NO. 2

TO THE PLANS AND SPECIFICATIONS FOR:

HCEB Continuing Education Office Remodel Floors 1 & 4

Prepared by

Brigham Young University Planning & Construction Dept. 240 Brewster Physical Plant Provo, Utah 84602 26 February 2024

This Addendum issued 26 February 2024 is for all persons preparing bids and as such shall be made a part of the contract documents. This Addendum consists of this cover sheet and 10 pages. In case of any conflict between the drawings, specifications, and this Addendum, this Addendum shall govern. All changes, corrections, deletions and/or additions to the initial bidding documents shall be included in the Bidder's proposal. Receipt of this Addendum shall be acknowledged on the Bid proposal forms.

Approved by:

Anthony R. Burdette, Director of Construction

atty Blato

26 February 2024 Date

BRIGHAM YOUNG UNIVERSITY CONTINUING EDUCATION OFFICE REMODEL LEVELS 1&4 Work Order No. N1864-N3482

ADDENDUM NO. 1 21 FEB 2024

OWNER/ARCHITECT

Brigham Young University Shelbey King, 255 BRWB, (801) 319-1983

General

- 1. The contractor is not responsible for purchase or installation of furniture as noted on Sheet A0.0 NIC list.
- OIT wiring and access control wires are by owner as noted on Sheet A0.0 NIC list.

CHANGES TO DRAWINGS/ ADDED INFORMATION, See attached Plans

Architectural


- 1. Sheet A2.0 N1864 (Level 1) See added notes for finished ceiling heights.
- 2. Sheet A4.0 N1864 (Level 1) See update sheet for hardware group 1 & 2.
- 3. Sheet A1.0 N3464 (Level 4) See added note for electrical panel location.
- 4. Sheet A1.0 N3482 (Level 4) note 7 refers to any modifications to the electrical and low voltage pathways noted on already issued electrical sheet. Use electrical sheets as the guide.
- 5. Sheet A2.0 N3482 (Level 4) See added notes for finished ceiling heights.
- 6. Sheet A3.0 N3482 (Level 4) Added Keynotes reference.
- 7. Sheet A4.0 N3482 (Level 4) See update sheet for hardware group 2.
- 8. Location of Electrical Panel Room notated on Sheet E1.0
- 9. USG Frost 490 is the only acceptable ceiling tile on this project.
- 10. There are no ACT-1, ACT-2, ACT-3 panels in this project, disregard in specs.

Mechanical


1. All existing sprinkler heads are whips.

Electrical

1. See attached BYU Electrical Bid Breakdown Form applicable to both levels.

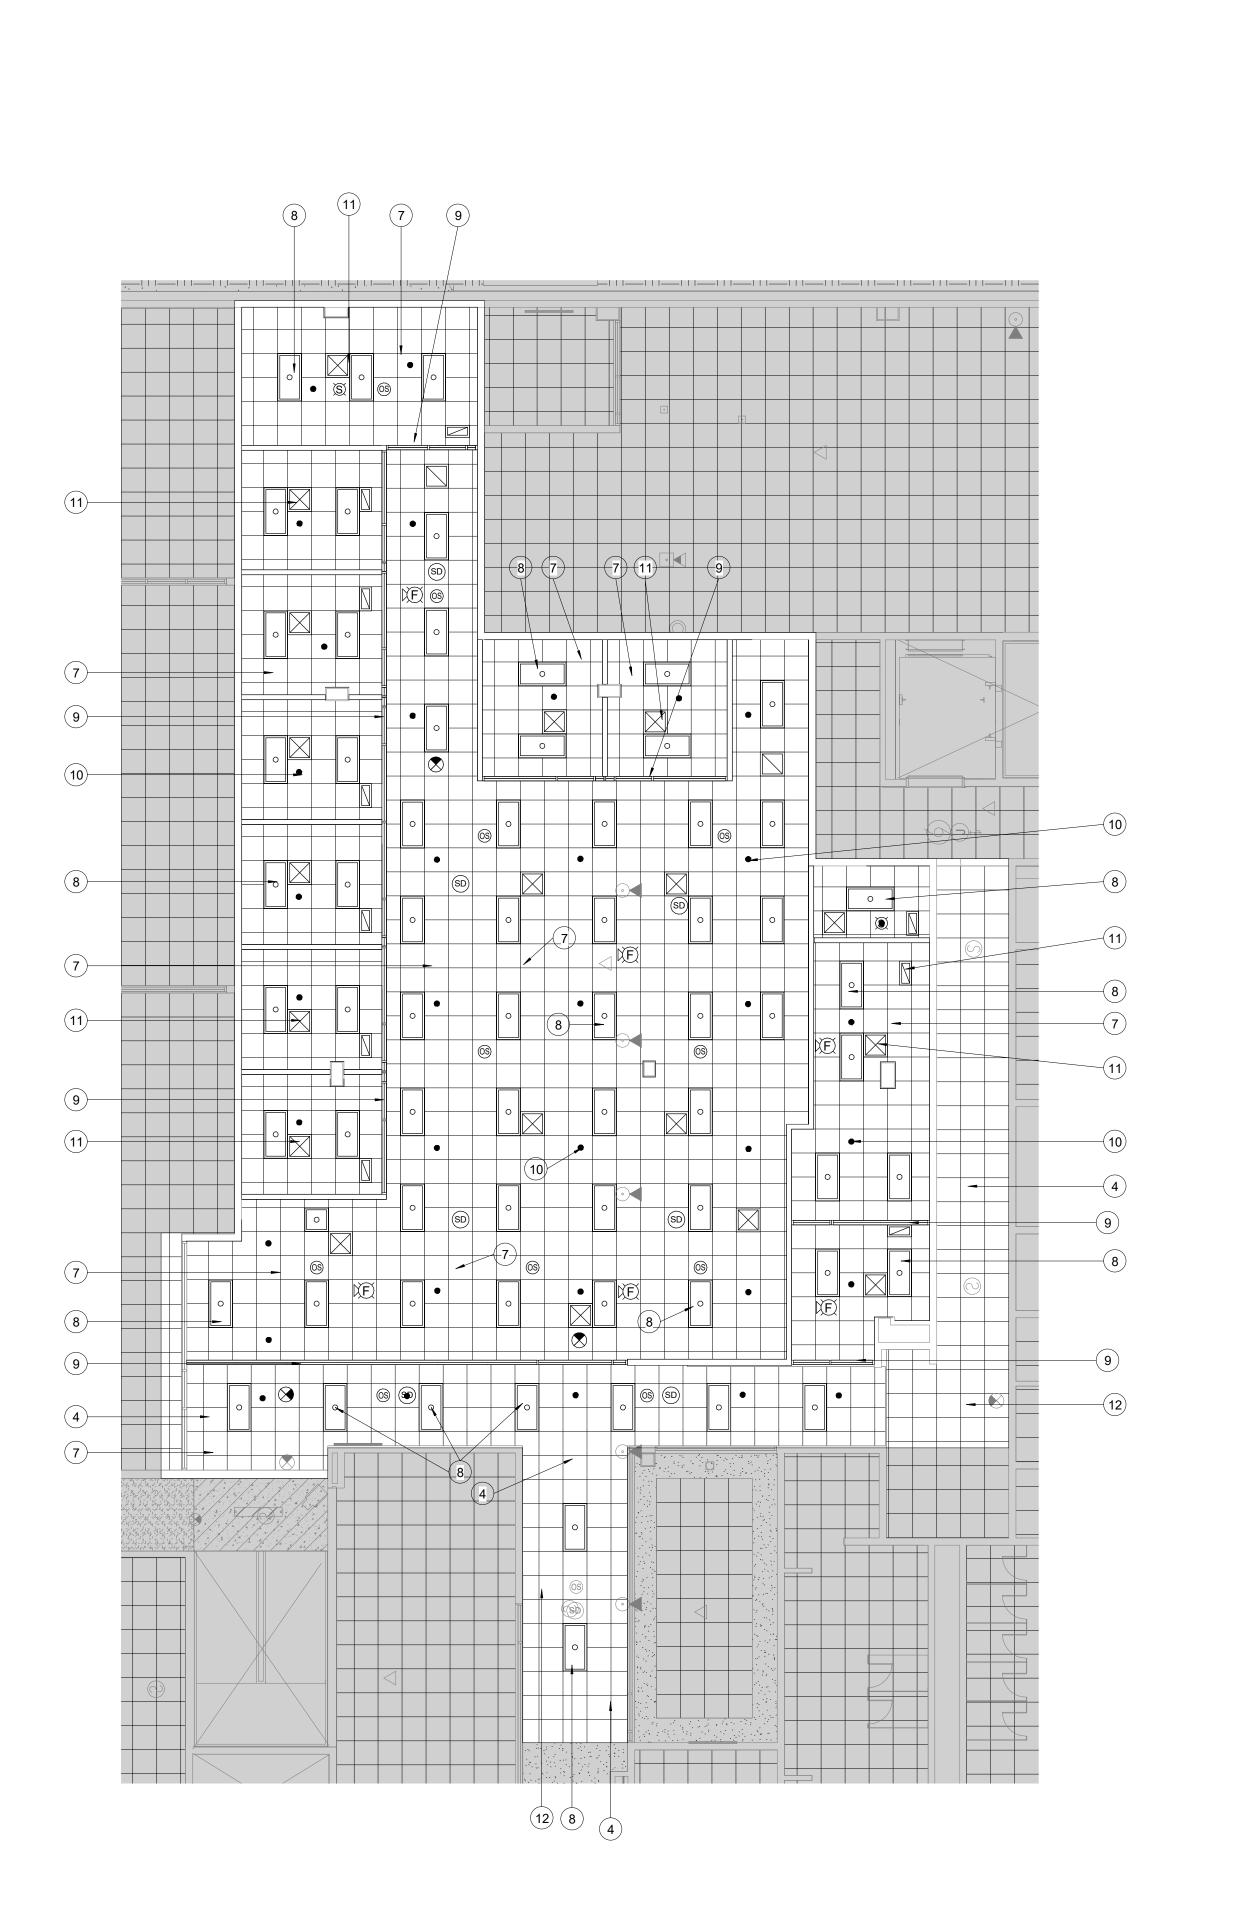

NEW CEILING PLAN
SCALE: 1/8" = 1'-0"

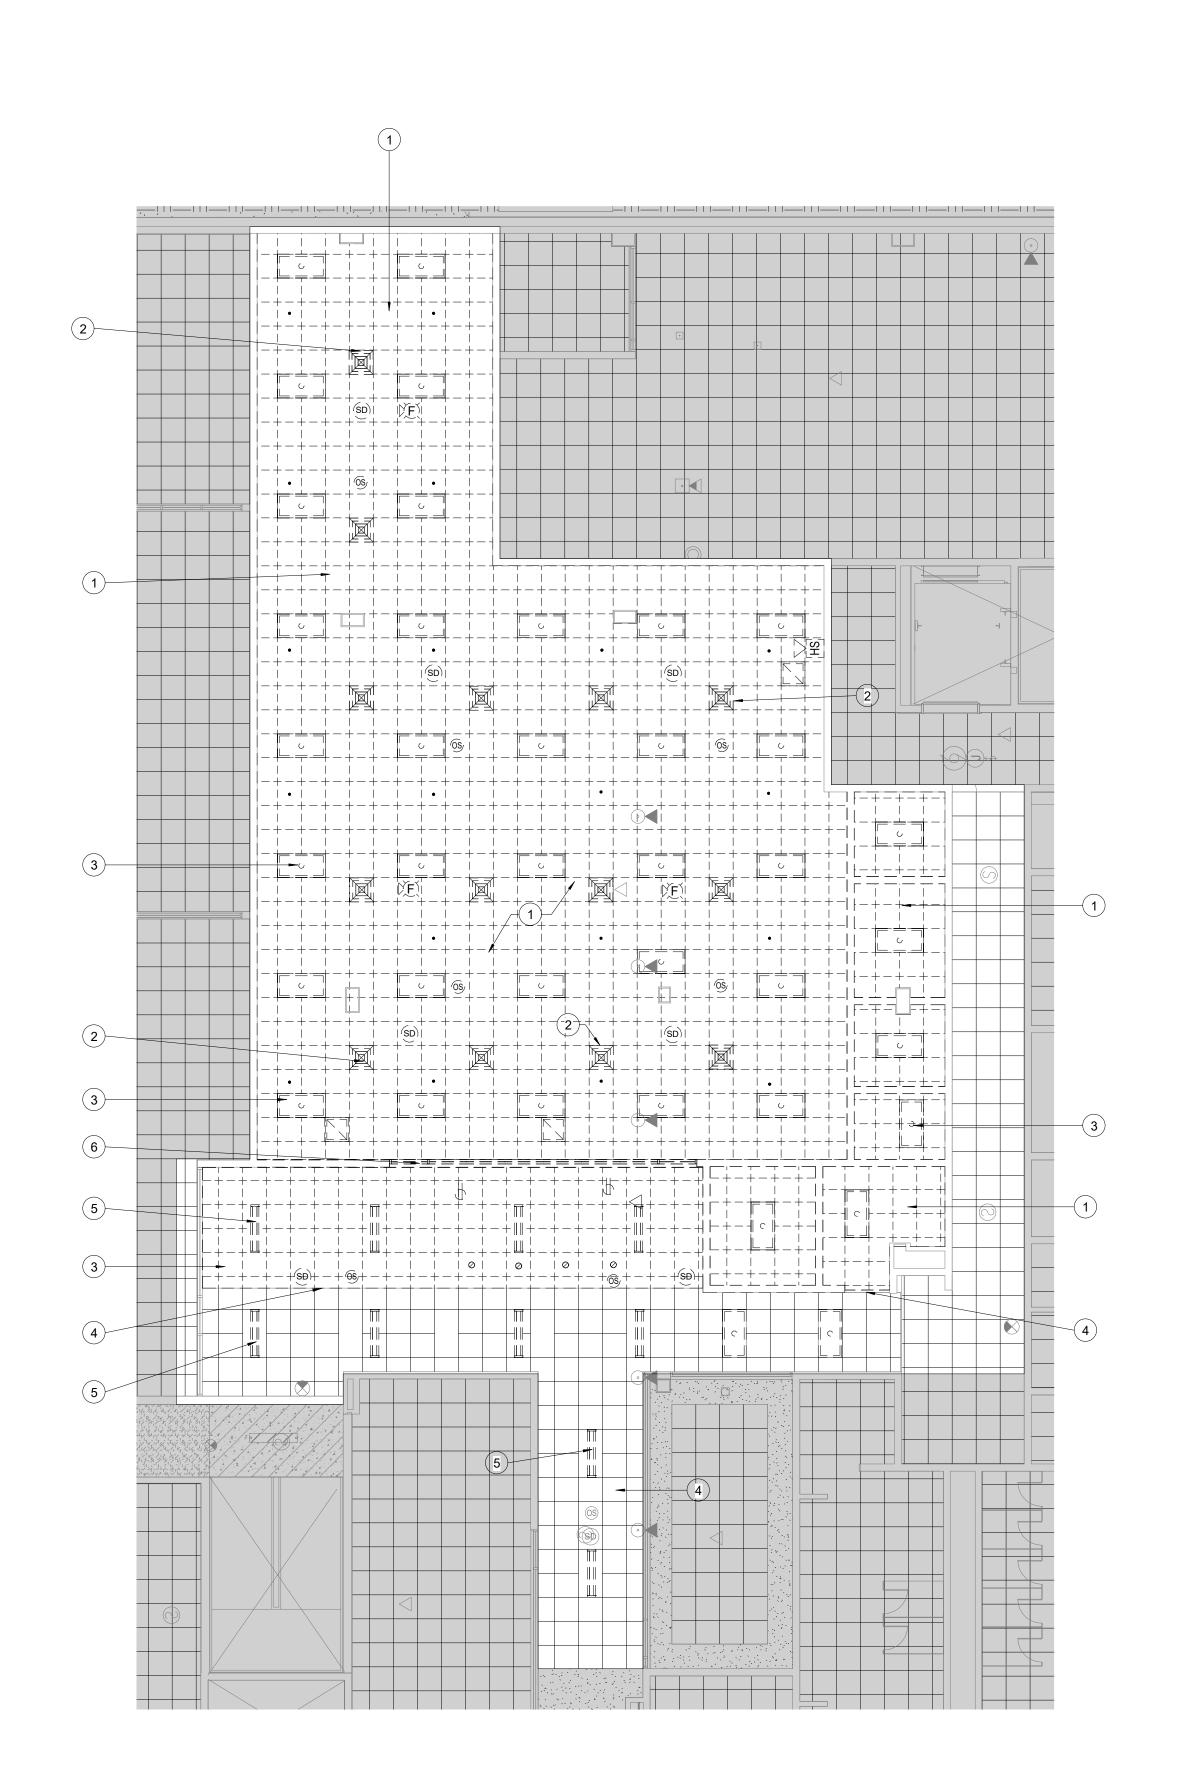

REFERENCE NOTES

- 1 REMOVE AND KEEP A SMALL PORTION OF TILES TO REPLACE DAMAGED TILES IN HALLS WHERE NOTED, DISPOSE OF THE REST OF 2X2 GRID CEILING AND CEILING
- 2 EXISTING SUPPLY AND RETURN SYSTEM TO BE MODIFIED FOR NEW LAYOUT, SEE
- MECHANICAL PLANS 3 REMOVE AND DISPOSE 2X4 LIGHTS, SEE ELECTRICAL PLANS
- 4 EXISTING 2X2 GRID CEILING AND CEILING TILES TO REMAIN AND BUTT TO NEW WALL HEADER, REPLACE DAMAGED TILES WITH ONES FROM DEMOLITION PORTION OF
- **PROJECT** 5 REMOVE AND DISPOSE OF EXISTING
- PENDENT LIGHTS, SEE ELECTRICAL PLANS 6 REMOVE AND DISPOSE OF EXISTING GYP. HEADER ABOVE STORE FRONT DOOR
- 7 PROVIDE AND INSTALL 2X2 CEILING GRID AND TILES TYPICAL THROUGHOUT PROJECT, SEE FINISH SCHEDULE
- 8 PROVIDE AND INSTALL NEW 2X4 LED FLAT PANEL LIGHTS AND ASSOCIATED MOTION SENSORS TO BE INSTALLED TYPICAL THROUGHOUT PROJECT, SEE ELECTRICAL
- 9 NEW 3 5/8" METAL STUD HEADER W/ 5/8" GYP. BD. EACH SIDE W/ SOUND BATT FILLING, PAINTED BOTH SIDES, TO GO 6" ABOVE CEILING GRID, SEE FINISH
- SCHEDULE/ ELEVATIONS 10 MODIFY FIRE SPRINKLER SYSTEM PER MECHANICAL PLANS AND TYPICAL
- THROUGHOUT PROJECT 11 PROVIDE AND INSTALL NEW SUPPLY AND RETURN AIR GRILLS PER MECHANICAL PLANS AND TYPICAL THROUGHOUT PROJECT
- 12 EXISTING SUPPLY AND RETURN SYSTEM TO REMAIN, SEE MECHANICAL PLANS

FINISH SCHEDULE:

WALL PAINT

MAIN COLOR: GREEK VILLA SW 67551L ACCENT COLOR: MAREA BAJA SW 9185

<u>DOOR</u> NATURAL WALNUT

MILLWORK NATURAL WALNUT

SOILID SURFACE Formica Classics - Luna Concrete 781

STORE FRONT SYSTEM
KAWNEER TRIFAB VG 450 4-1/2" DEEP WITH A 1-3/4" SIGHT LINE -CENTER. CLEAR ANODIZED FINISH

GRID/TILE SYSTEM TILE: USG FROST 490 GRID: BYU SPEC - WHITE

CEILING HEIGHT

CEILING GRID - 9'-9" TYPICAL FOR OPEN AREA AND OFFICES BYU

FACILITIES PLANNING 240 BRWB PROVO, UTAH 84602

2/14/24 DESIGNER: SK

PHONE: (801) 422-5504 FAX: (801) 422-0566

DRAWN BY:

ADA CHECK:

CODE CHECK: STRUCTURAL: **UTILITIES DIR:**

CLIENT APPROVAL

PLANNING DIR:

REVISIONS

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DEMOLITION AND NEW CEILING PLAN

WORK ORDER & SHEET NO.

N1864 **A2.0**

20' DEMOLITION CEILING PLAN

DOOR SCHEDIII E		HARDWARE CROUDS # 201/27 DV WEETER D	
DOOR SCHEDULE	ALUM. H1 ALUMINUM STORE FRONT DOOR SYSTEM ALUM. H2 ALUM. H2	HARDWARE GROUPS (LOCKSET CYLINDERS BY OW GROUP H1: STORE FRONT DOOR (6) EA. FULL MORTISE - 5 KNUCKLE HINGE (1) EA. PRECISION KEY REMOVABLE MULLION (1) EA. EO SARGENT 88 SERIES CRASHBAR - (2) EA. LICN 4040XP GROUP H2: HALL DOOR (3) EA. FULH MORTISE - 5 KNUCKLE HINGE (2) EA. FLUSH BOLTS (2) EA. FLUSH BOLTS (3) EA. ELVER POLTS (1) EA. CONCAVE WALL STOP (AS NEEDED) MCKINNE (2) EA. FLUSH BOLTS (3) EA. EVER POLTS (4) EA. CONCAVE WALL STOP (AS NEEDED) MCKINNE (2) EA. CONCAVE WALL STOP (AS NEEDED) MCKINNE (3) EA. EVER POLTS (4) EA. EVER POLTS (5) EA. EVER POLTS (6) EA. EVER POLTS (7) EA. EVER P	REFERENCE TA2714 4 1/2" x 4 1/2" 26D WALL PAINT -
	ALL FRAMES NOT LISTED HERE WILL BE IN REPRESENTED IN STOREFRONT ELEVATIONS F1 ALUMINUM	SEE SCHED. WOOD DOOR SEE SCHED. WOOD WOOD WOOD WOOD - HALF LITE	SEE SCHED. OD OR TYP AND OR TYP SEE SCHED. OD OR TYP AND OR TYP SEE SCHED. OD OR TYP AND OR TY

RENCE NOTES

R: GREEK VILLA SW 67551L

LOR: MAREA BAJA SW 9185

F<u>ACE</u> sics - Luna Concrete 781

NT SYSTEM

FRIFAB VG 450 4-1/2" DEEP WITH

HT LINE
LEAR ANODIZED FINISH

<u>YSTEM</u> ROST 490 SPEC - WHITE

STRUCTURAL: UTILITIES DIR:

DRAWN BY: S.KING

BYU

FACILITIES PLANNING

240 BRWB PROVO, UTAH 84602 PHONE: (801) 422-5504 FAX: (801) 422-0566

2/22/24

DATE

S.KING

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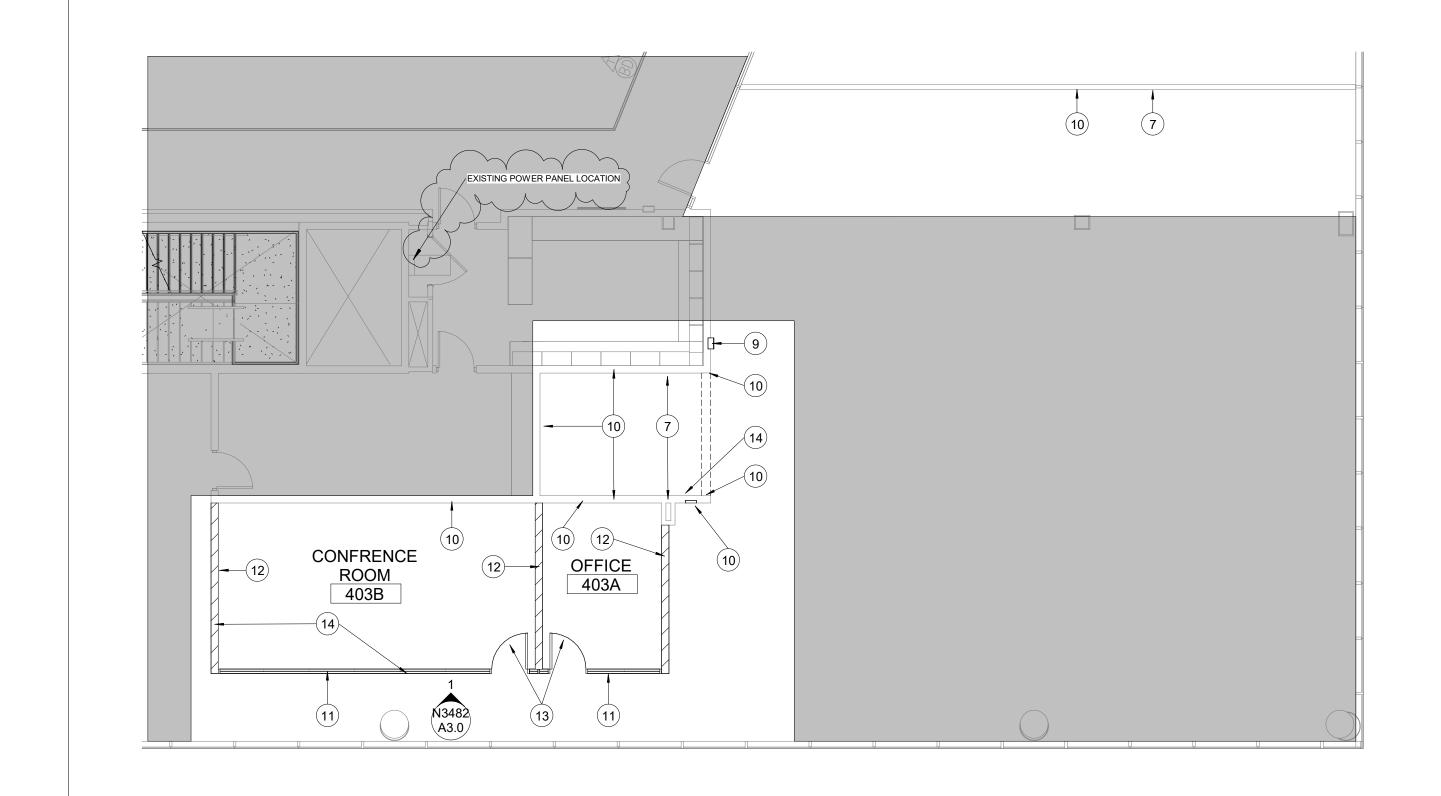
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WORK ORDER & SHEET NO.


N1864 A4.0

FRAMES
SCALE: 1/4" = 1'-0"

DOOR TYP.
SCALE: 1/4" = 1'-0"



NEW FLOOR PLAN 0 1' 2' 5' 10' SCALE: 1/8" = 1'-0"

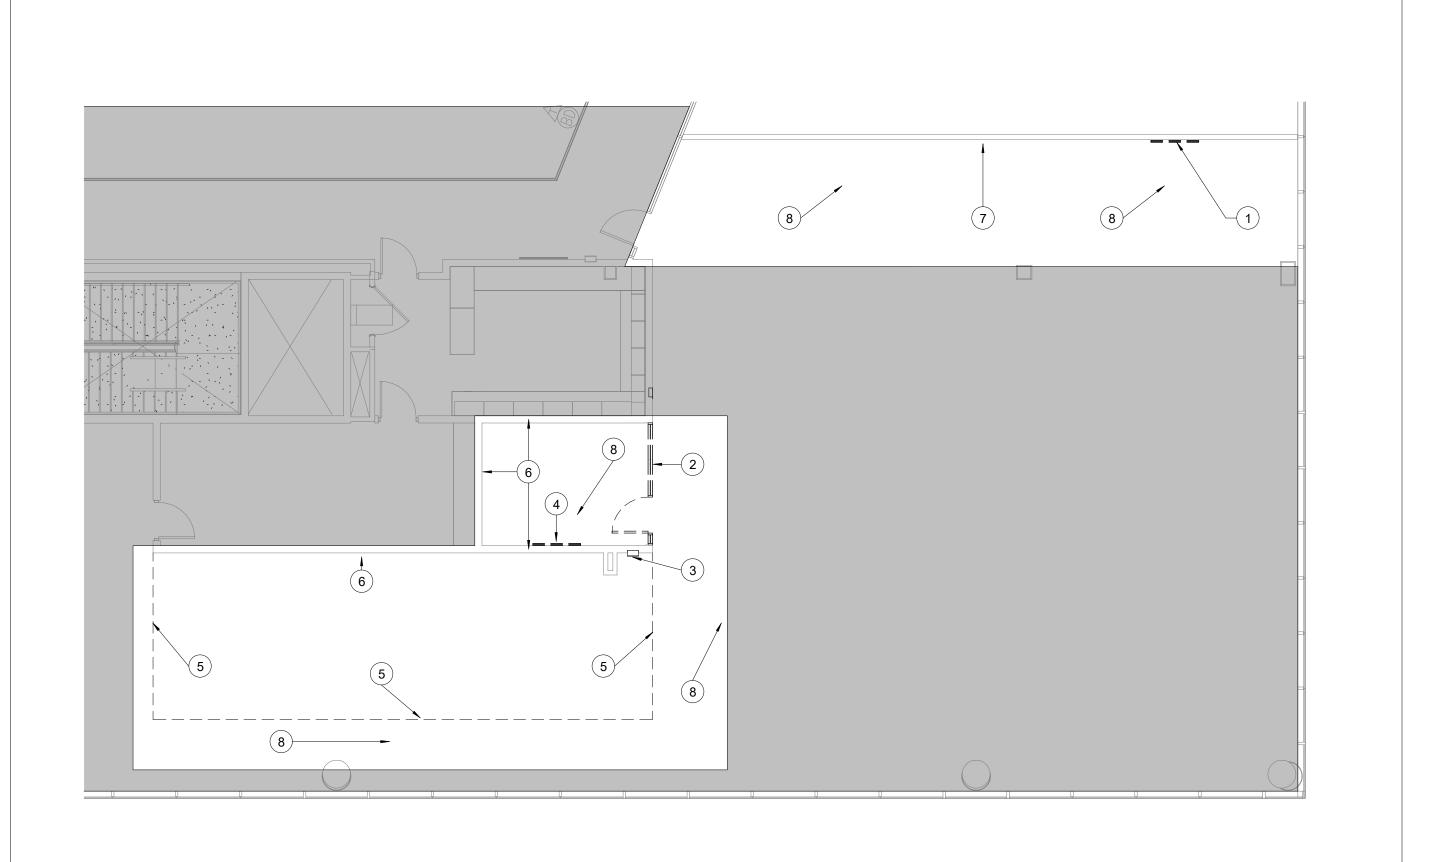

REFERENCE NOTES

- 1 OWNER TO REMOVE AND DISPOSE OF EXISTING SMART BOARD
- 2 REMOVE AND DISPOSE OF EXISTING ALUM. STORE FRONT WINDOWS, AND 3 5/8" METAL STUD GYP. WALL ABOVE AND BELOW STORE
- FRONT GLASS 3 REMOVE AND SAVE EXISTING FIRE EXTINGUISHER, AND BOX FOR REUSE IN PROJECT
- 4 EXISTING FLAT PANEL SCREENS TO BE REMOVED, SEE OIT PLANS, ELECTRICAL PLANS 5 OWNER TO CUT EXISTING CARPET TILES FOR
- **NEW WALLS** 6 EXISTING WALLS TO REMAIN, PROTECT AS
- REQUIRED 7 MODIFY EXISTING POWER AND NETWORKING
- AS NOTED ON ELECTRICAL PLANS 8 EXISTING CARPET TO REMAIN, PROTECT AS
- REQUIRED 9 INSTALL EXISTING FIRE EXTINGUISHER AND WALL MOUNTED BOX, PATCH AND PAINT WALL ADA CHECK: AROUND INSTALLATION AS NEEDED
- 10 PATCH AND PAINT THE ENTIRETY OF THE EXISTING WALL, SEE FINISH SCHEDULE
- 11 PROVIDE AND INSTALL STORE FRONT GLASS SYSTEM - KAWNEER TRIFAB VG 450 4-1/2" DEEP WITH A 1-3/4" SIGHT LINE - CENTER. CLEAR ANODIZED FINISH, SEE ELEVATIONS
- 12 NEW 3 5/8" METAL STUD WALL W/ 5/8" GYP. BD. EACH SIDE W/ SOUND BATT FILLING, PAINTED BOTH SIDES, TO GO 6" ABOVE CEILING GRID, SEE FINISH SCHEDULE
- 13 PROVIDE AND INSTALL NEW 3070 NATURAL WALNUT SLAB DOOR TO MATCH EXISTING BUILDING DOORS IN FIT AND FINISH, SEE
- FINISH SCHEDULE 14 PATCH AND REPAIR EXISTING CARPET **FLOORING**



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DATE:	2/14/24
DESIGNER:	S. KING
DRAWN BY:	MDL


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STRUCTURAL: **UTILITIES DIR:** PLANNING DIR:

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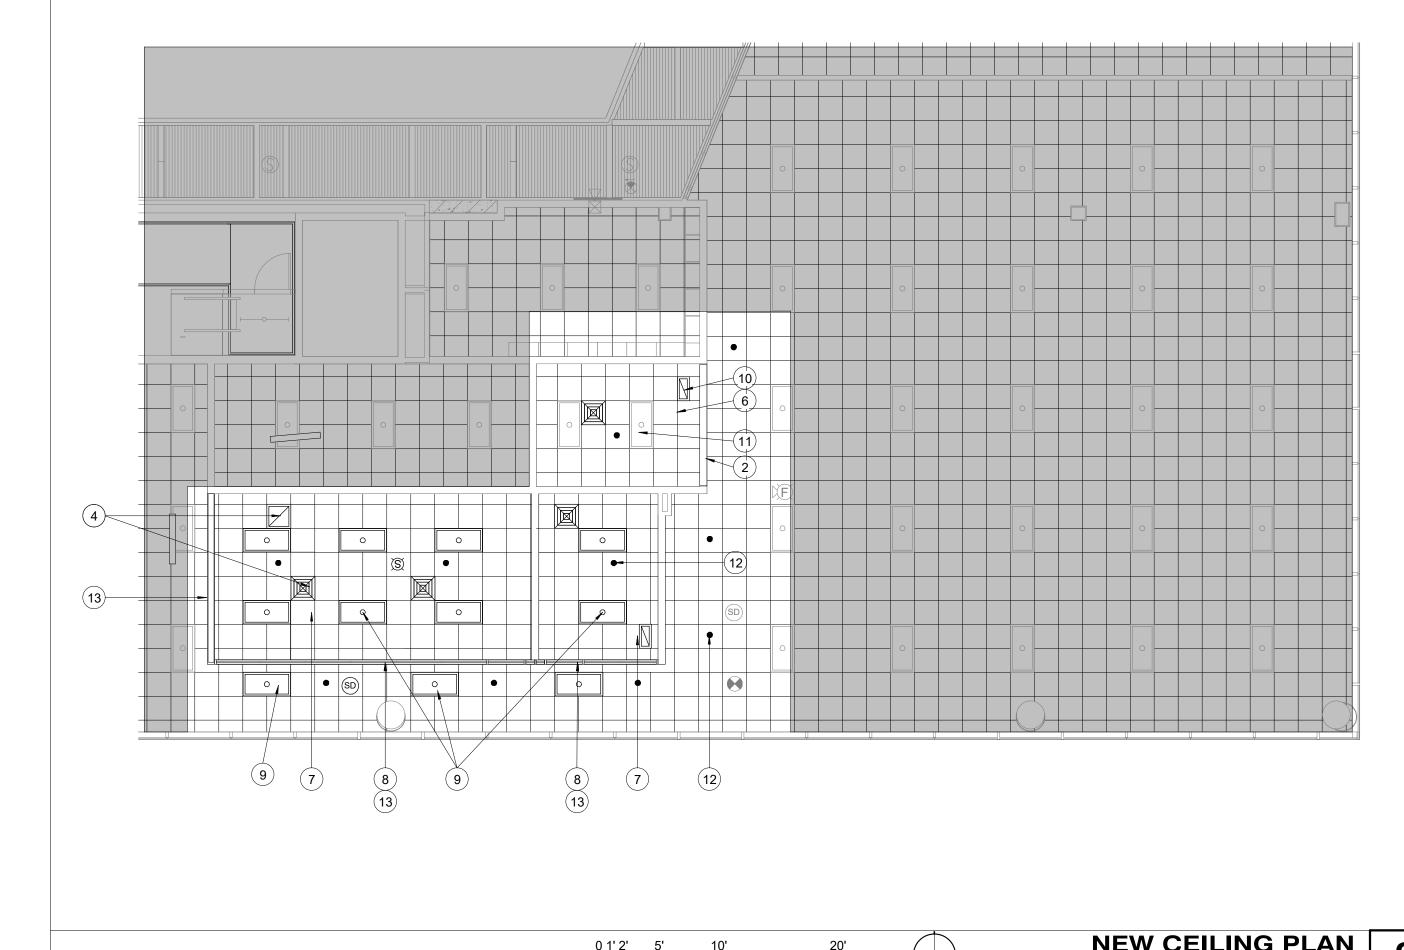


DEMOLITION & NEW FLOOR PLAN


WORK ORDER & SHEET NO.

N3482 A1.0

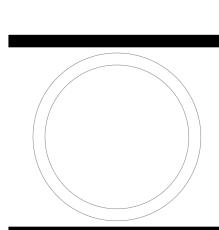DEMOLITION FLOOR PLAN
SCALE: 1/8" = 1'-0"



NEW CEILING PLAN SCALE: 1/8" = 1'-0"

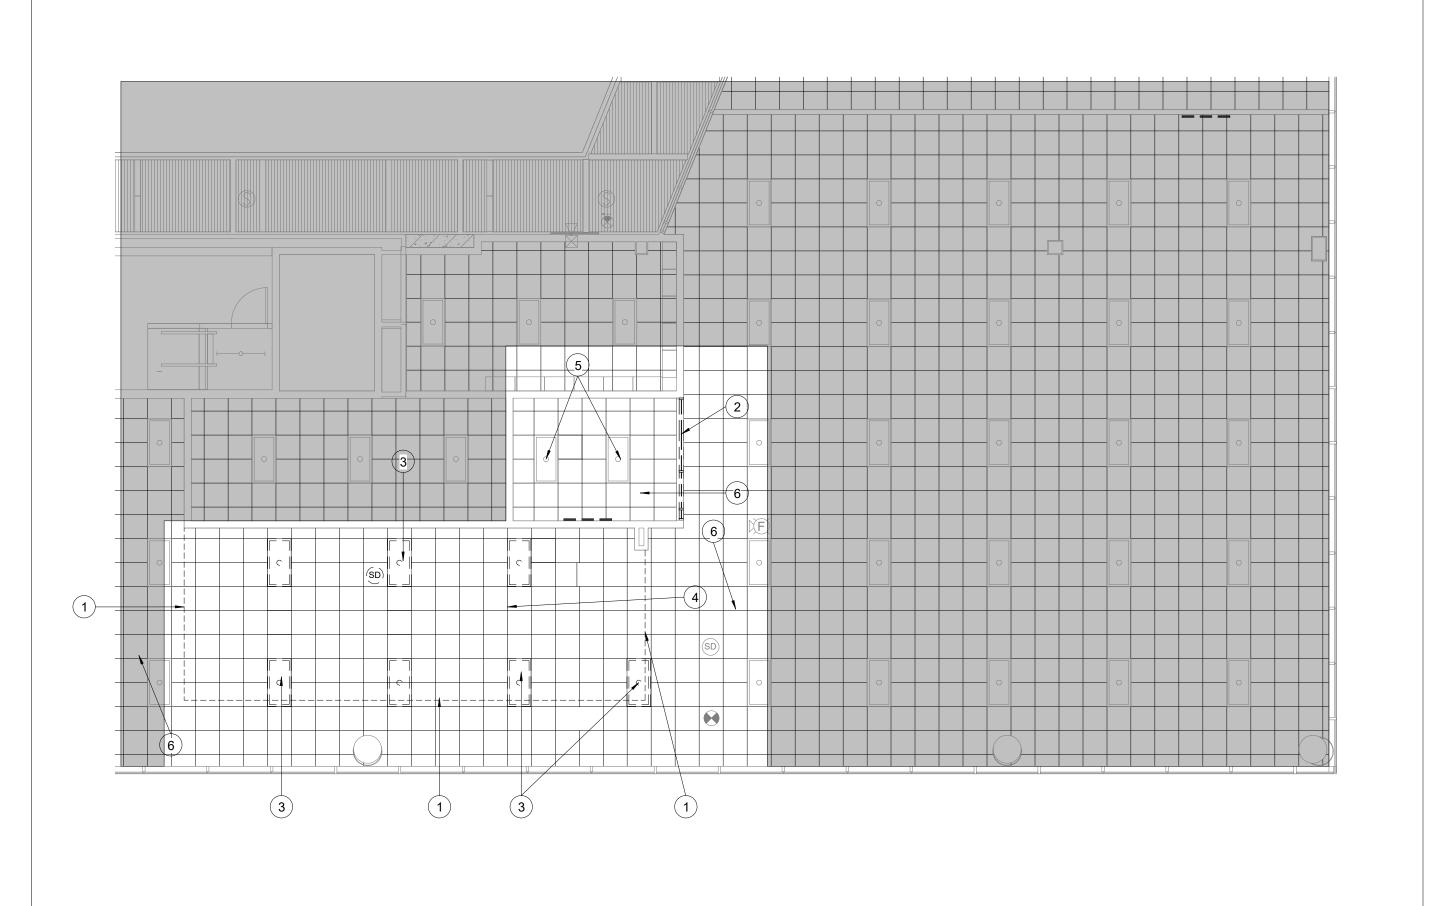

1 REMOVE AND DISPOSE OF EXISTING 2X2 GRID CEILING WITHIN NEW ROOM FOOTPRINTS

- 2 EXISTING GYP. BD. HEADER TO REMAIN,
- PATCH AND PAINT AS NEEDED 3 REMOVE AND DISPOSE 2X4 LIGHTS, SEE ELECTRICAL PLANS
- 4 EXISTING SUPPLY AND RETURN SYSTEM TO BE MODIFIED FOR NEW LAYOUT, SEE MECHANICAL PLANS
- 5 EXISTING 2X4 LIGHTS TO REMAIN, PROTECT
- AS REQUIRED 6 EXISTING 2X2 GRID CEILING TO REMAIN,
- PROTECT AS REQUIRED 7 PROVIDE AND INSTALL 2X2 CEILING GRID AND TILES TYPICAL THROUGHOUT PROJECT, SEE

FINISH SCHEDULE

- 8 NEW 3 5/8" METAL STUD HEADER W/ 5/8" GYP. BD. EACH SIDE W/ SOUND BATT FILLING, PAINTED BOTH SIDES, TO GO 6" ABOVE CEILING GRID, SEE FINISH SCHEDULE/ **ELEVATIONS**
- PANEL LIGHTS AND ASSOCIATED MOTION SENSORS TO BE INSTALLED TYPICAL THROUGHOUT PROJECT, SEE ELECTRICAL PLANS

9 PROVIDE AND INSTALL NEW 2X4 LED FLAT

- 10 EXISTING SUPPLY AND RETURN SYSTEM TO REMAIN, SEE MECHANICAL PLANS 11 EXISTING 2X4 LIGHTING TO REMAIN, SEE
- ELECTRICAL PLANS 12 MODIFY FIRE SPRINKLER SYSTEM PER
- MECHANICAL PLANS AND TYPICAL THROUGHOUT PROJECT 13 EXISTING 2X2 GRID CEILING AND CEILING
- TILES TO REMAIN AND BUTT TO NEW WALL/HEADER, PATCH AND REPAIR AS NEEDED

CEILING HEIGHT

CEILING GRID - 10'-1"

TYPICAL FOR CONFRENCE ROOM AND OFFICE

REFERENCE NOTES



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DEMOLITION & NEW CEILING PLAN

WORK ORDER & SHEET NO.

N3482 **A2.0**

DEMOLITION CEILING PLAN

REFERENCE NOTES

- 1 NEW 3 5/8" METAL STUD HEADER W/ 5/8" GYP. BD. EACH SIDE W/ SOUND BATT FILLING, PAINTED BOTH SIDES, TO GO 6" ABOVE CEILING GRID, SEE FINISH SCHEDULE/ ELEVATIONS
- 2 PROVIDE AND INSTALL NEW 3070 NATURAL WALNUT SLAB DOOR TO MATCH EXISTING BUILDING DOORS IN FIT AND FINISH, SEE FINISH SCHEDULE
- 3 PROVIDE AND INSTALL STORE FRONT GLASS SYSTEM - KAWNEER TRIFAB VG 450 4-1/2" DEEP WITH A 1-3/4" SIGHT LINE -CENTER. CLEAR ANODIZED FINISH, SEE **ELEVATIONS**
- 4 NEW 3 5/8" METAL STUD WALL W/ 5/8" GYP. BD. EACH SIDE W/ SOUND BATT FILLING, PAINTED BOTH SIDES, TO GO 6" ABOVE CEILING GRID, SEE FINISH SCHEDULE



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DATE:	2/26/24	
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DATE:	2/20/24
DESIGNER:	S.KING
DRAWN BY:	S.KING

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CODE CHECK:

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ELEVATIONS

WORK ORDER & SHEET NO.

N3482 A3.0

N3482 A4.0

3' - 1 1/2" 3' - 1 1/2"

3 N3482 A4.0

3' - 1 3/4" 10 1/4" 3' - 1 3/4"

N3482 A4.0

N3482 A4.0

N3482 A4.0

<u>36' - 11 3/4"</u> <u>3' - 9 1/2"</u>

3' - 9 1/2"

3' - 9 1/2"

3' - 9 1/2"

1 N3482 A4.0

N3482 A4.0

3' - 9 1/2"

N3482 A4.0

<u>(4)</u>—·

DOOF	R SCHEDULE									RE GROUPS (LOCKSET CYLIN			REI
MARK 7	DR FRM TYPE LOCATION	DOOR SIZE	DOOR MAT'L	FRAME MAT'L	H/ GI	(00)	EMARKS		Υ	ORE FRONT DOOR FULL MORTISE - 5 KNUCKLE HINGE	MCKINNEY	TA2714 4 1/2" x 4 1/2" 26D	
	D1 - OFFICE 403A D1 - CONFRENCE ROOM 403B	3'-0" x 7'-0" x 1 3/4" 3'-0" x 7'-0" x 1 3/4"	WOOD	ALUM.		H2 H2			(1) EA. (1) EA.	LEVER PULL CONCAVE WALL STOP (AS NEEDED)	SCHLAGE ROCKWOOD	ND92LD RHO 626 409 26D	
									GROUP H2: OF (3) EA. (2) EA. (1) EA.	FULL MORTISE - 5 KNUCKLE HINGE FLUSH BOLTS LEVER PULL	MCKINNEY ROCKWOOD SCHLAGE	TA2714 4 1/2" x 4 1/2" 26D 555 26D ND92LD RHO 626	
									(1) EA.	CONCAVE WALL STOP (AS NEEDED)	ROCKWOOD	409 26D	
												լSEE SCHED. լ	
												WOOD DOOR	
												SEE SCI 	
												D1 wood	
												DOOR TYPES	6
												SCALE: 1/4" = 1'-0"	
								WALL TYPE PER PLAN ACOUSTICAL BATT INSULATION BRAKE METAL WALL CAP			STOREFRONT SYST BACKER ROD & — SEALANT (BOTH SIDES) SHIM SPACE—— FINISHED FLOOR AS SCHEDULED		
								WALL TO MULLIC	ON DETA		TERIOR STO	DREFRONT SILL DETAIL SCALE: 3" = 1'-0"	
								ALIGN	FRAMING, AS PER WALL TY MUDDED ME MOLDING, TY SEALANT, EACH SIDE SCHEDULED STOREFRON SHIM SPACE MUDDED ME	TAL J- /P.		METAL STUD WALL PER WALL TYPE CEILING AS SCHEDULED BRAKE METAL SEALANT, EACH SIDE SCHEDULED STOREFRONT DOOR AS SCHEDULED WHERE OCCURS	
								JAMB DETAI				HEAD DETAIL	

REFERENCE NOTES



FACILITIES PLANNING
240 BRWB PROVO, UTAH 84602
PHONE: (801) 422-5504
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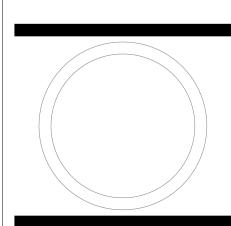
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U N I V E R S I T Y

NUING EDUCATION OFFICE REMODEL LEVELS 1&4



DOOR SCHEDULE, STORE FRONT DETAILS

WORK ORDER & SHEET NO.

N3482 A4.0

BYU ELECTRICAL BID BREAKDOWN FORM

The General Contract bid will be tabulated using the Column "Base Bid" total along with all other electrical work. (All other electrical items, not specifically listed on this form, are to be bid as specified, as listed on the Drawings, or as approved in the Addendum to the contract documents.) Prices shall be as quoted to the Contractor by the vendor, exclude sales tax.

The selected General Contractor, will provide this form <u>complete</u>, to the Owner within twenty-four (24) hours after the General Contractor selection. At that time, the Electrical Contractor's bid must include all items in all columns listed on this form. Prices shall be verified by a copy of the quotation on request.

Vendors not specifically pre-listed under alternate Columns "A", "B", "C", "D" or "E" on this form may be submitted as a substitute by the Contractor for consideration by the Owner following procedures noted in the specification. If a column does not have a vendor pre-listed and a substitute has been pre-approved, the Electrical Contractor may indicate the vendor providing the price in the "other" column. Electrical items not specifically listed on this form, in the Specification, on the Drawings or as approved in the Addendum to the contract documents, cannot be listed on the Electrical Bid Breakdown.

The Owner is not obligated to use items in Column "Base Bid". The Owner reserves the right to pick and choose from among alternative offerings in Columns "A", "B", "C", "D" and "E". The contract shall be adjusted without markup for any price differential between the price listed in Column "Base Bid" and that listed in any selected alternative column. The Owner reserves the right to accept or reject any of the Equipment or System items anytime within ninety (90) days after signing a contract.

In the event that the supplier in Column "Base Bid" does not provide a price at bid time, the contractor shall include the most expensive option listed (A, B, C, etc), in their bid.

Item	Specification Section	Base Bid	А	В	С	D	Е
	262725 Wiring Devices	Hubbell \$	Leviton \$	Pass & Seymour \$			
	260923 Lighting Control Devices	Hubbell \$	Sensor Switch \$	Wattstopper \$			
	260936 Modular Lighting Controls	Wattstopper \$	Nextlight \$				

BYU ELECTRICAL BID BREAKDOWN FORM

						For Lighting only, provide cost per fixture in this column.
265100 Interior Lighting N1864 F1	Lithonia \$	SLG \$	BLG \$	Sylvania \$	Cooper \$	\$
265100 Interior Lighting N1864 F2	Lithonia \$	Philips \$	Metalux \$	SLG \$		\$
265100 Interior Lighting (Exit Signs) N1864 EX	Dual-Lite \$	BYU \$				\$
265100 Interior Lighting N3482 F1	Lithonia \$	SLG \$	BLG \$	Sylvania \$	Cooper \$	
284050, 284600 Fire Alarm System	Notifier \$	BYU \$				

BRIGHAM YOUNG UNIVERSITY

ADDENDUM RECEIPT

DATE:	February 26, 2024				
PROJECT:	HCEB Continuing Education Office Remodel Floors 1 & 4				
PROJ. #:	N1864 & N3482				
We acknowledge receipt of Addendum Number 2.					
COMPANY:					
BY:					
TITLE:					

PLEASE EMAIL SIGNED RECEIPT TO construction@byu.edu