BRIGHAM YOUNG UNIVERSITY

2024 CNA OFFICE REMODEL SUITE 1041 AND SUITE 1053 COLLEGE OF HUMANITIES

ABBREVIATIONS



FIN. FLR. FLUOR. Finish Floor Fluorescent FURN GA GYP Furnish, Furnished Guage Ó Gypsum HDWD Hardwood HDWR Hardware HORIZ Horizontal Height HVAC Heating Ventilating & A/C INSUL. Insulation Length Material MATL. MAX. Maximum MECH Mechanical MANUF Manufacturer MIR. Mirror MISC. Miscellaneous MTL Metal, Material N.I.C. Not In Contract NO. N.T.S. Number Not To Scale O.C On Center(s Opening OPN'G OPP O T S Opposite Open To Structure P-LAM Plastic Laminate PLBG. Plumbing PLYWD. Plywood PREFAB Prefabricate PREFIN. Prefinished P.S.F. Pounds per Square Foot P.S.I. Pounds per Square Inch QTY. Quantity RAD. Radius REQ'D RESIL SPECS Required Resilient Specifications SQ. S.S. STD. Square Stainless Steel Standard STL. TYP. Stee Typical T.O. Top of VAT VCT VERT Vinyl Asbestos Tile Vinyl Composition Tile Vertical W/O SCHED SIM Without Schedule

Similar

NOTE: SEE OTHER CONSULTANT DRAWINGS FOR ADDITIONAL ABBREVIATION INFORMATION

APPROVALS

Ole M. Smith, Assistant Administrative Vice Pres. – Physical Facilities


David Decker, Managing Director -- Physical Facilities Planning Department

SYMBOLS LEGEND	
DRAWING TITLE	SCALE: 1/4" =
DETAIL REFERENCE SHEET REFERENCE	A
ELEVATION MARKER	T.O. MASONRY
REFERENCE NOTE TAG	3
ROOM TITLE ROOM NUMBER ROOM FINISHES	OFFICE 100 F1 B1 W1
ROOM TITLE ROOM NUMBER CEILING HT. & FINISH	OFFICE 100 10'-0" C1
BREAK LINE	()
NORTH SYMBOL	\bigoplus
CODE COMPLIANCE	(NO CHANGE IN US

THIS PROJECT SHALL BE INSTALLED ACCORDING TO THE LATEST EDITION OF THE FOLLOWING STANDARDS AND AMENDMENTS TO THEM AS ADOPTED BY THE AUTHORITY HAVING JURISDICTION.

2021 IEBC (International Existin 2021 IBC (International Building 2021 IFC (International Fire Cod 2020 NEC (National Electrical C 2021 IECC (International Energy 2021 IFGC (International Fuel G NEMA (National Electrical Manu Assoc.) 2021 IMC (International Mechan 2021 IPC (International Mechan 2021 IPC (International Plumbin 1997 Uniform Code for Buildign NFPA (National Fire Protection / UL (Underwriters Laboratories, I State and Local Building Authori 2009 - Accessible and Usable B - IOC A117.1	Code) e) ode) / Conservation Code) as Code) facturer ' s ical Code) g Code) Conservation Association) nc.) ty and Codes
DCCUPANCY CLASS: Section 305	Exist. Group: B New Group: B
USE:	UNCHANGED
CONSTRUCTION TYPE: Section 601	Exist. Type: IIA New Type: IIA
EBC ALTERNATION LEVEL:	2
OCCUPANT LOAD (Work Level):	UNCHANGED
BUILDING ROOF SQ. FT.	317,552 SQ. FT.
LEVEL AREA SQ. FT.	94,165 SQ. FT.
PROJECT WORK AREA SQ. FT.	5,620 SQ. FT.
FIRE PROTECTION: Section 903	Fully Sprinkled
EGRESS:	UNCHANGED
REQUIRED PLBG FIXTURES:	UNCHANGED

JOSEPH F. SMITH BUILDING (JFSB) WORK ORDER - K8101 WORK ORDER - N4027

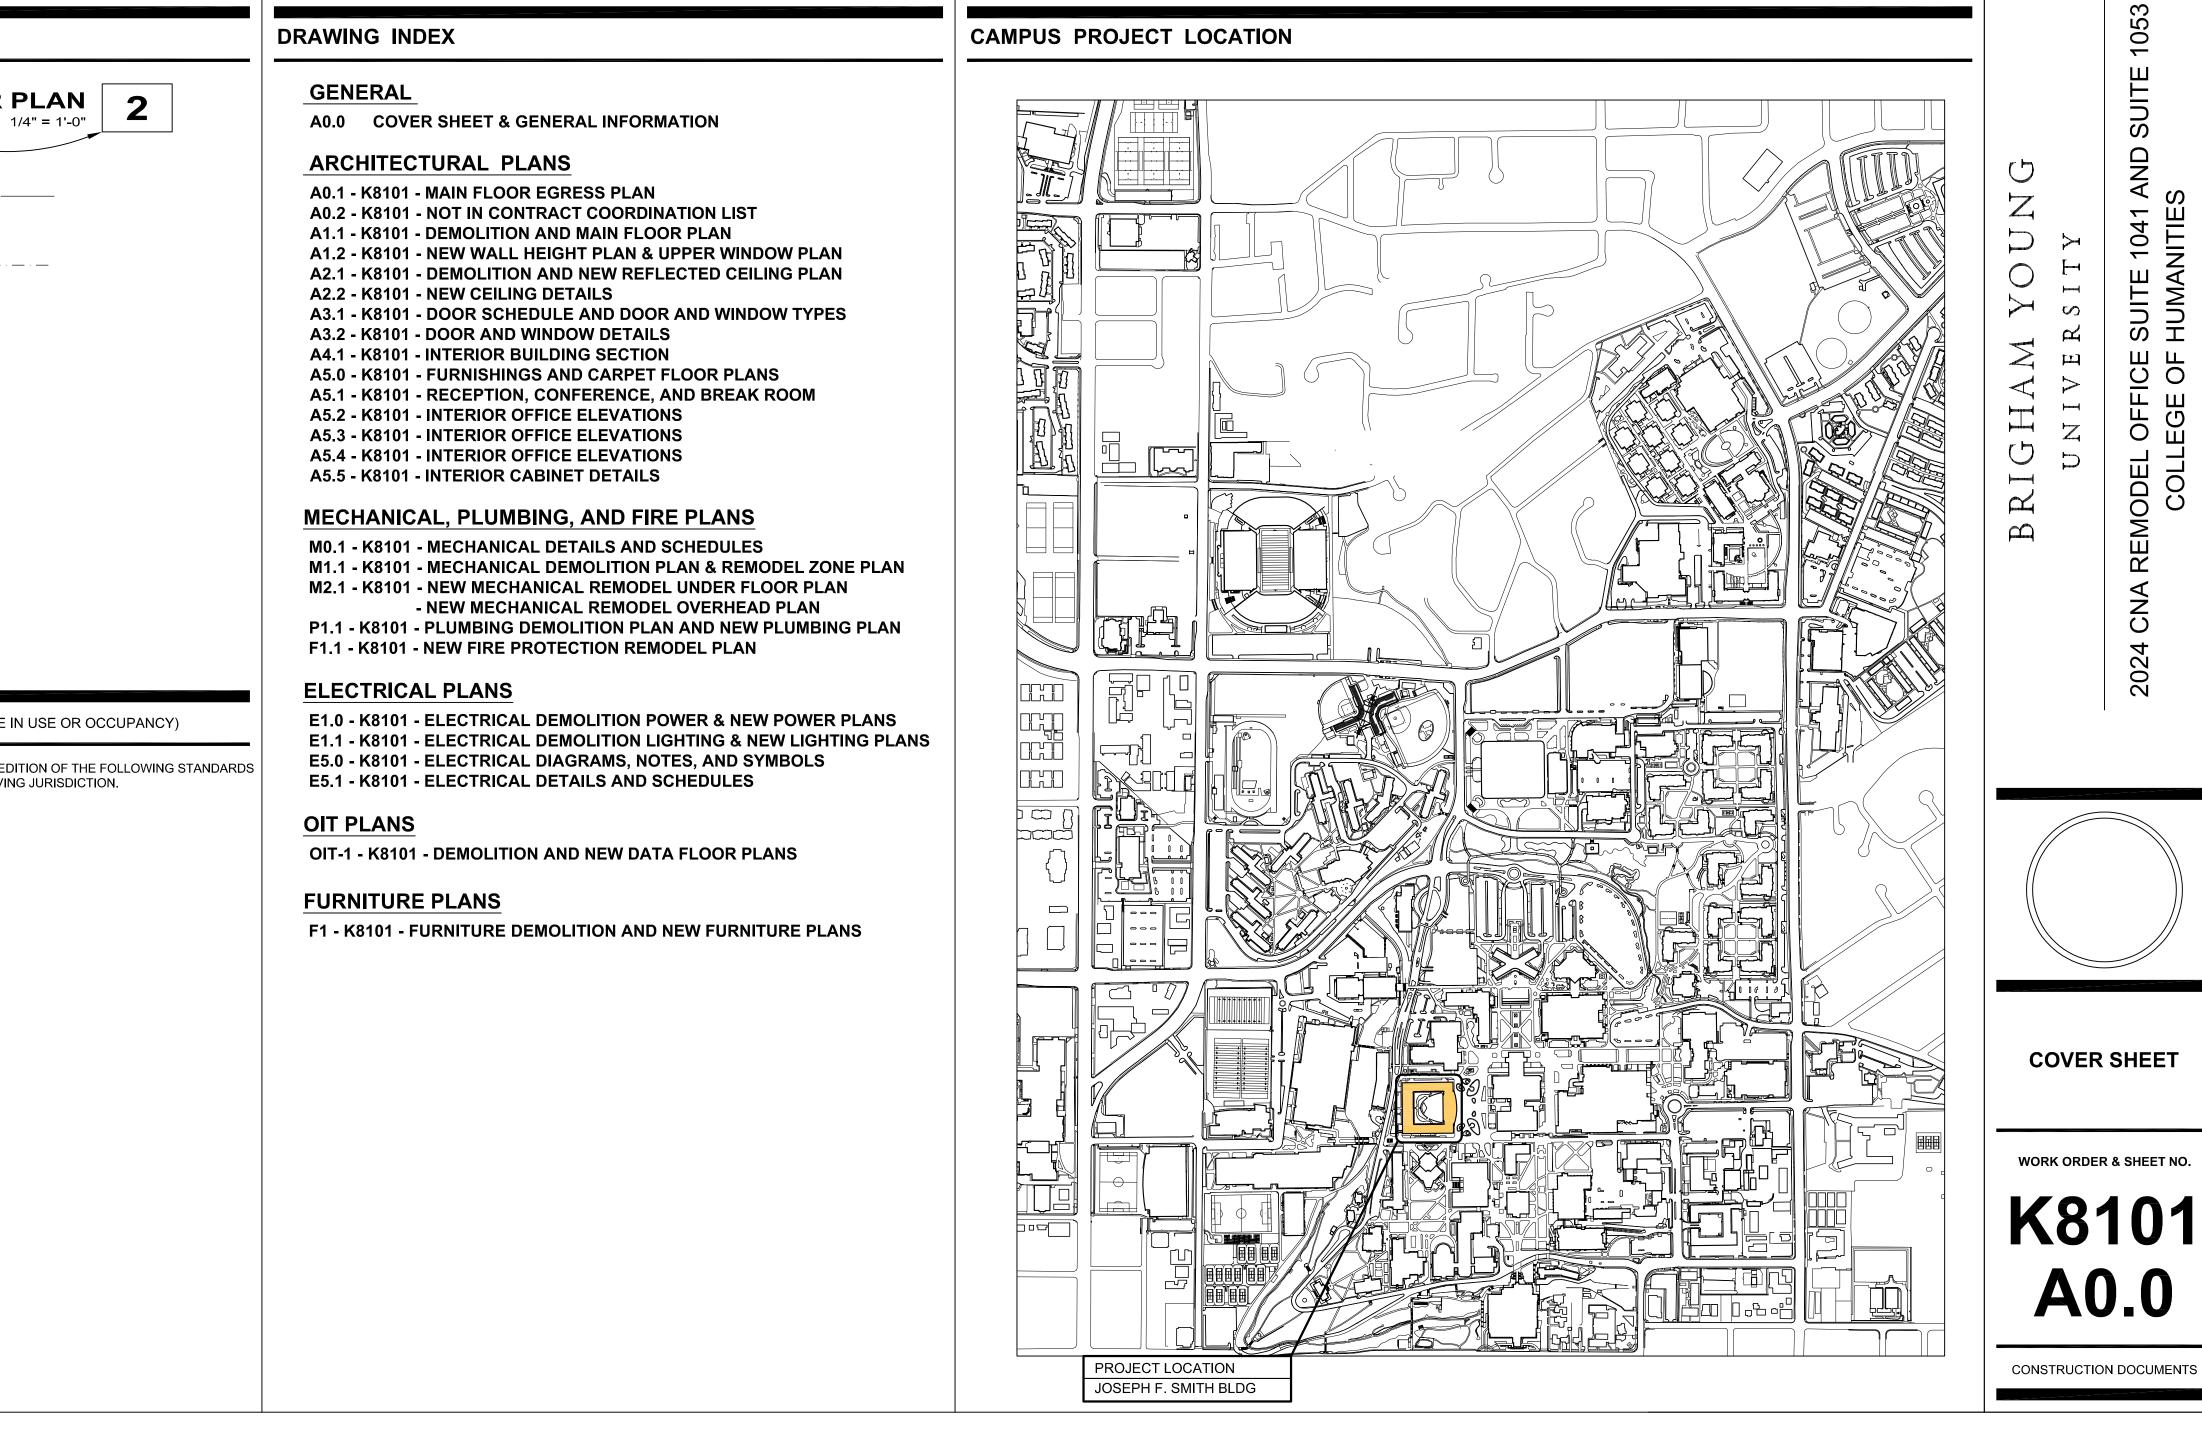

GENERAL NOTES

GENERAL CONTRACTOR SHALL TAKE NECESSARY ACTIONS TO PROTECT EXIST. WALLS, DOORS, WINDOWS, FLOORS, SIGNAGE BELLS, ALARMS, FIRE EXTINGUISHER CABS., DRINKING FOUNTAINS, WALL-MOUNTED HEATERS, & ANY OTHER PERMANENT COMPONENTS OF THE EXIST. BUILDING TO REMAIN. CONTRACTOR SHALL BE RESPONSIBL TO FIX, PATCH, REPAIR AND/OR REPLACE ANY & ALL EXISTING ITEMS WHICH ARE DAMAGED DURING CONSTRUCTION

FOUNDED

BYU

1875

FACILITIES PLANNING

240 BRWB PROVO, UTAH 84602

PHONE: (801) 422-5504 FAX: (801) 422-0565

SM

herami Jara Feb. 26, 202 Sam Prestwich Feb. 26, 202

CODE CHECK:

FEB, 29, 2024

S. McCLELLAN

DATE

DATE:

DESIGNER:

DRAWN BY:

ADA CHECK:

UTILITIES DIR: STRUCTURAL:

PLANNING DIR:


REVISIONS

CLIENT APPROVAL

- GENERAL CONTRACTOR SHALL TAKE NECESSARY ACTIONS TO PROTECT ALL EXIST. FIRE SPRINKLER PIPING! <u>DO NOT</u> PLACE OR POSITION ANYTHING OF ANY KIND OR ANYONE ON, AGAINST OR HANGING FROM EXIST. PIPING!
- IMMEDIATELY FOLLOWING DEMOLITION OF EXIS WALLS, FLOORS & CEILINGS CONTRACTOR SHALL EVALUATE EXIST. CONDITIONS TO IDENTIFY ANY AND ALL CONFLICTS W/ NEW LAYOUTS/PLANS. CONTRACTOR SHALL NOTIF OWNER IMMEDIATELY IF CONFLICTS ARE DISCOVERED
- . CONTRACTOR SHALL BE AWARE THAT OWNER WILL OCCUPY PORTIONS OF BUILDING DURING CONSTRUCTION
- . CONTRACTOR SHALL PROVIDE TEMP. LIGHTING AS NECESSARY DURING CONSTRUCTION

WORK BY OTHERS (NIC)

OWNER SHALL REMOVE/STORE EXIST. FURNITURE, FLAT-PANEL DISPLAYS, SPEAKERS, SECURITY CAMERAS & ASSOC CABLING, EQUIPMENT & WALL-HUNG ITEMS PRIOR TO DEMOLITION. OWNER SHALL REINSTALL THESE ITEMS FOLLOWING CONSTRUCTION.

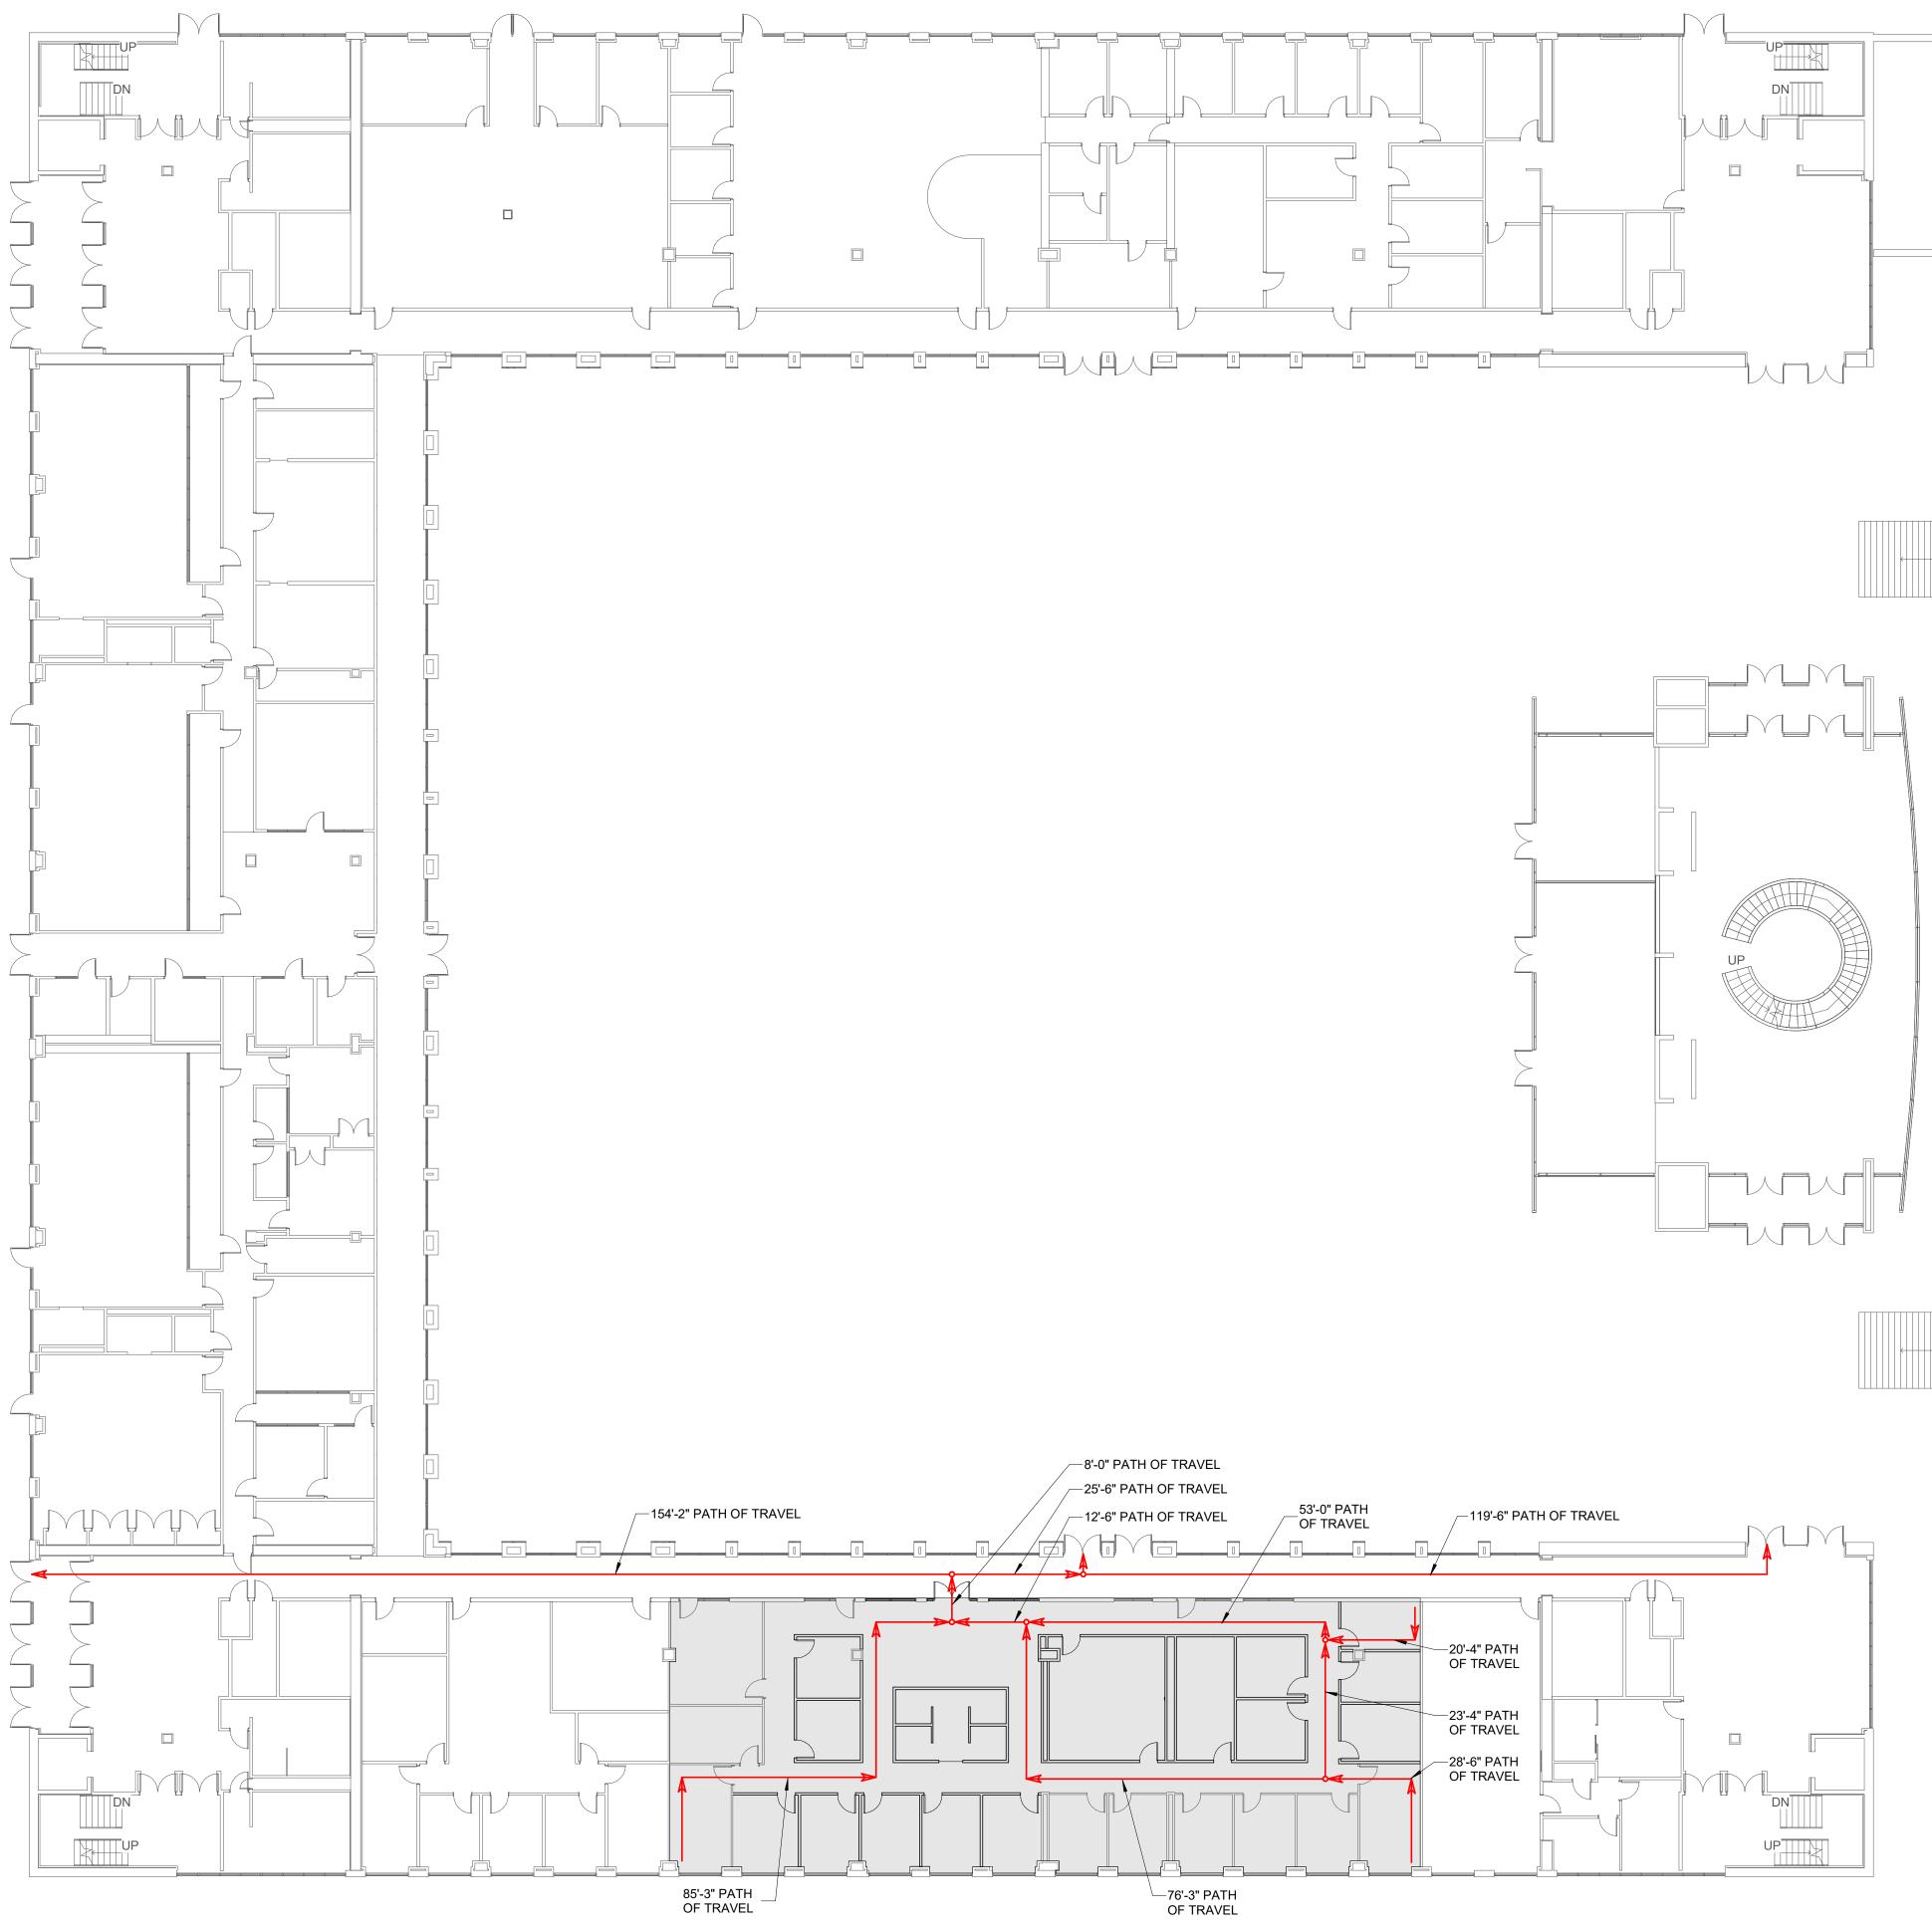


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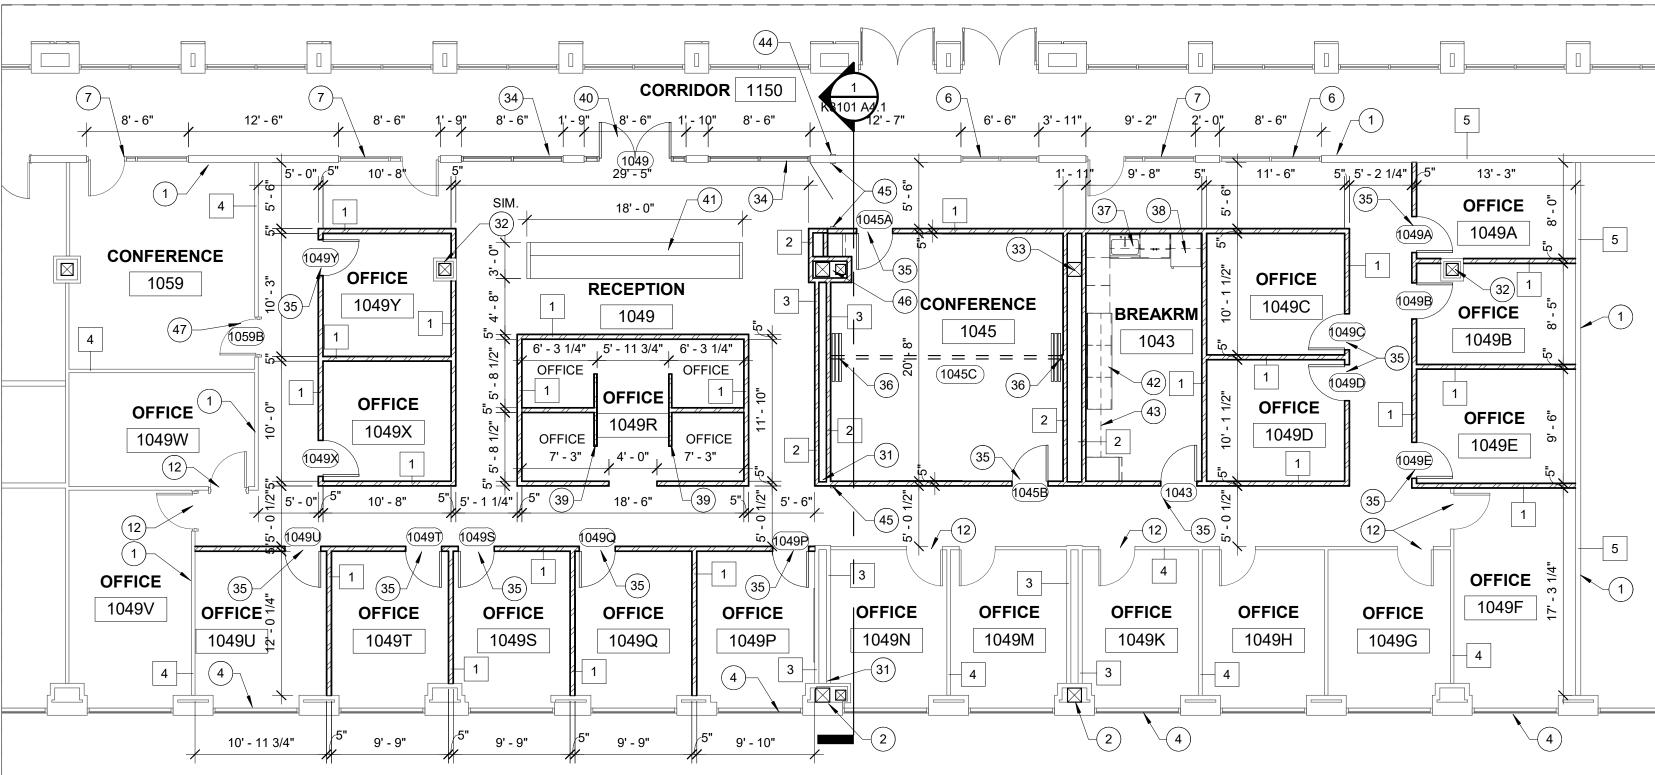
	240 BRWB PRO PHONE: (80	PLANNING PLANNING VO, UTAH 84602 01) 422-5504 01) 422-0566 FEB. 29, 2024 S. McCLELLAN MDL
	BRIGHAM YOUNG UNIVERSITY	REMODEL OFFICE SUITE 1041 AND SUITE 1053 COLLEGE OF HUMANITIES JOSEPH F. SMITH BUILDING (JFSB) - LEVEL 1
AIN FLOOR EGRESS PLAN SCALE: 1/16" = 1'-0"	K8' A(PLAN R & SHEET NO. 101


Not-In-Contract (NIC) Coordination List	Furnished by BYU	Installed by BYU / BYU Vendor	Installed by General Contractor	Furnis by Ge Contra
All Design Fees	x	Venuor	contractor	contre
All Printing Costs (Use established BYU printing contract)	x	1		
Plan Check, Demolition Permit, Grading Permit, Building Permit, Sign Permit, Engineering Permit, Connection, and Impact Fees	x			
Street and Sidewalk Closure Permit, Haul Route Permit, etc.				;
Payment, Performance, and Materials Bonds)
Asbestos and Hazardous Materials Abatement	x			
Testing and Special Inspection Fees	x			
Testing and Special Inspection Scheduling				3
Site Surveys (ALTA, topographical, etc.)	x			
Construction Surveys (building staking, site improvement and utility layout, etc.)				3
Geotechnical Reports	x			
Site Work			n	
Pavement Markings	x	x	×	
Site Furnishings	x	x		
Dumpsters and Recycle Bins	x	x	-	
General		a second		
Signage - interior and exterior	x	x	2	-
Door Hardware		e en la	x	, ,
Removeable Core Cylinders and Keying	x	x	-	-
Wireless Card Readers	×	x	2	
Fixed Dock Equipment (dock leveler, bumpers, etc.)			x	,
Portable Dock Equipment (manlifts, dolleys, etc.)	x	x		
Equipment Hoist Beams			x	,
Hoists or Trolleys (power and rough electrical In Contract) Vending Machines, Microwaves	x	x		-
	X	x		
Fire Extinguisher Cabinets and Extinguishers	7 	Br Par	x	,
AED (Defibrillator) Unit wiring and connection to police dispatch notification system	X	x		
OIT				
Podiums, Equipment Cabinets, with mounting hardware, etc. (power and rough electrical In Contract)	X	x		
Audio / Sound Reinforcement with mounting hardware, etc. (power and rough electrical In Contract)	x	x		
Projectors (power and rough electrical for controls In Contract)	X	x		
Projection Screens (power and rough electrical for controls In Contract)	x		x	-
Projection Screen Boxes, ceiling-recessed			x)
Flat Panel Displays and Digital Signage with mounting hardware (backing, power and rough electrical In Contract)	x	x		
CCTV Cameras with mounting hardware (power and rough electrical In Contract)	x	x		
Smart Boards and Interactive Marker Boards with mounting hardware (power and rough electrical In Contract)	x	x		
Building Directory (power, data, and rough electrical In Contract)	x	x	4	-
All AV systems (power and rough electrical In Contract)	x	x	-	-
All Data Pathways, Termination Boxes, Cabling, Terminations to Wall Plates and Patch Panels, Warranty			x	
All Data Racks			x	1
All Cable Tray			x	
Cable Pass Systems complete, Terminations, Wall Racks, Cable Hangers, Wall Plugs, Intumescent bags (1 per cable pass penetration)		1993	х	. 0
Wireless Access Points (Power and Data in Contract)	X	x		-
Time Clocks - Student Employee Type (power, data, and rough electrical In Contract)	X	x	-	<u> </u>
Time Clocks - Battery Powered Type			×)
			0	-
Time Clocks - Hard-wired to Bell System Type			x	3
800MhZ Radio Reinforcement	x	x		
Building Care				
Cleaning Agent Dispenser (In Contract: 1/2" cold water supply, pressure reducing valve, spill-proof vacuum breaker, ball valve, testing report, and electrical outlet)	x	x		
Rest Room Mirrors	ADD-D		x	;
Sanitary Napkin Disposals (Include in all single use restrooms.)	x		x	<u> </u>
Toilet Paper Dispensers	x		x	l
Paper Towel Dispensers	x		x	<u> </u>
Liquid Soap Dispensers	x		x	ļ
Diaper Changing Stations	X		x	
Shower Curtains (Shower rods In Contract)	x		x	ļ
Mop Racks and Hangers	x		x	-
Interiors				
KV type adjustable shelving			x	3
Marker boards / Tack boards			x	2
Window Treatments - Blinds & Shades (including power and rough electrical for motorized blinds)			x	2
Systems Furniture in Offices, etc.	x	x	-	-
Movable Furniture and Seating	x	x	-	-
Fixed Seating in Auditorium and Meeting Rooms	x	x	¢	-
Carpet and Carpet Base, LVT, Rubber Base	x	x	2	-
Display Cases (directory type, wall blocking In Contract)	x	x		
Acoustical Curtains, Banners, Tracks, Motors, Wiring, Controls, etc.			x	- '
Appliances	x	x		
Systems Machapical Controls Hardware (both system and terminal units) by Atkingen or Johnson Controls				-
Mechanical Controls Hardware (both system and terminal units) by Atkinson or Johnson Controls	X		x	
Mechanical Controls Raceway Machanical Controls Braggemming (Software, both system and terminal units) by Atkinson or Johnson Controls			x	· ,
Mechanical Controls Programming (Software - both system and terminal units) by Atkinson or Johnson Controls	X	X		
High Temperature Hot Water Control Valves	x		x	
High Temperature Controls (panels and sensors)	x	×	2.0	-
BTU Meters (unless Questar service)	x	1000	x	
BTU Metering (panels and sensors)	X	x	18-16 	
BTU Metering (wetted taps)	X		x	50
Emergency Generator			×	,
Dust Collection Systems and Dust Collection Ductwork and Fittings		ļ	x	
Air Compressors and plumbing of air lines / terminations / couplings / hose reels			x	,
Project Specific			7	
Moving Existing Equipment	x			<u> </u>
		5<	9 C	
Revision Date: 4-22-22				


Revision Date: 4-22-22

			REFERENCE	NOTES	FACILITIE 240 BRWB PRO PHONE: (1)	UNG UHH YU 1875 0, UTAH S PLANNING 0VO, UTAH 84602 801) 422-5504 801) 422-0566
nished General tractor	Notes				DATE: DESIGNER:	FEB. 29, 2024 S. McCLELLAN
x x x					DRAWN BY: ADA CHECK: CODE CHECK: STRUCTURAL: UTILITIES DIR:	
x					CLIENT APPRO	
x					REVISIONS	
x x						
X	Connections made by Access Services					
x						TE 1053
x x x x					D U N G T Y	E 1041 AND SUITE HUMANITIES DING (JFSB) - LEVEL 1
x x	These should be in the BYU standard specification. Primex brand. These should be in the BYU standard specification.				AM YO Versit	SUITE 1041 E OF HUMA
x	Dispenser and power outlet to be +60" above mop sink. SPV model: Wilkins 460 XL by Zurn. Engineer of record to provide installation detail.				L G H U N I	OFFICE SUITE 1041 AND COLLEGE OF HUMANITIE JOSEPH F. SMITH BUILDING (JFSB) - LEVEL 1
					B R]	REMODEL OFFICE COLLEG
X X X						REM
x						
x						
x x						
x					NOT IN C	ONTRACT
					K 8	ER & SHEET NO. 101 0.2
. I.C) COORDINATION	LIST 1			CONSTRUCT	ON DOCUMENTS
		I	1		1	




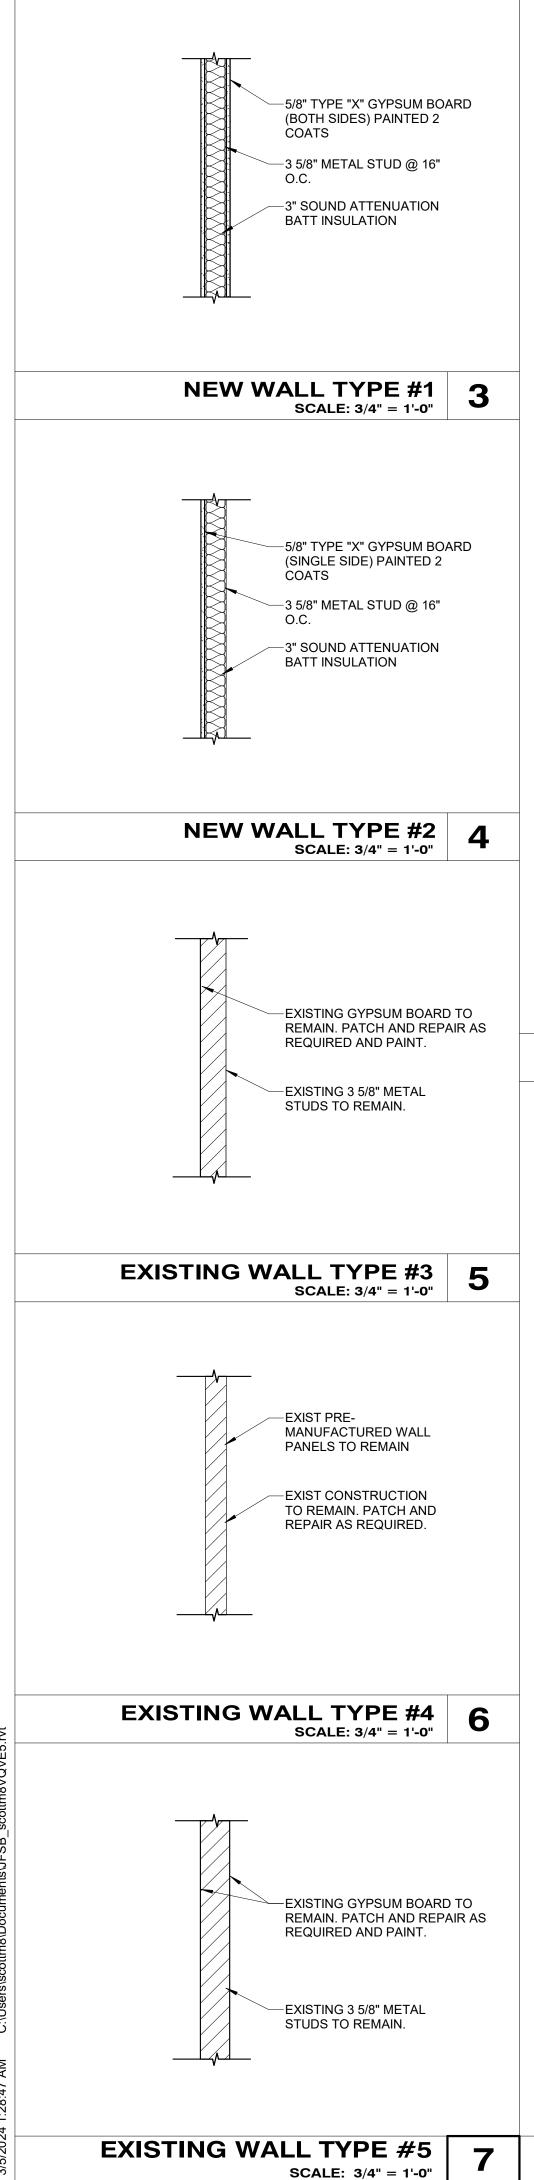

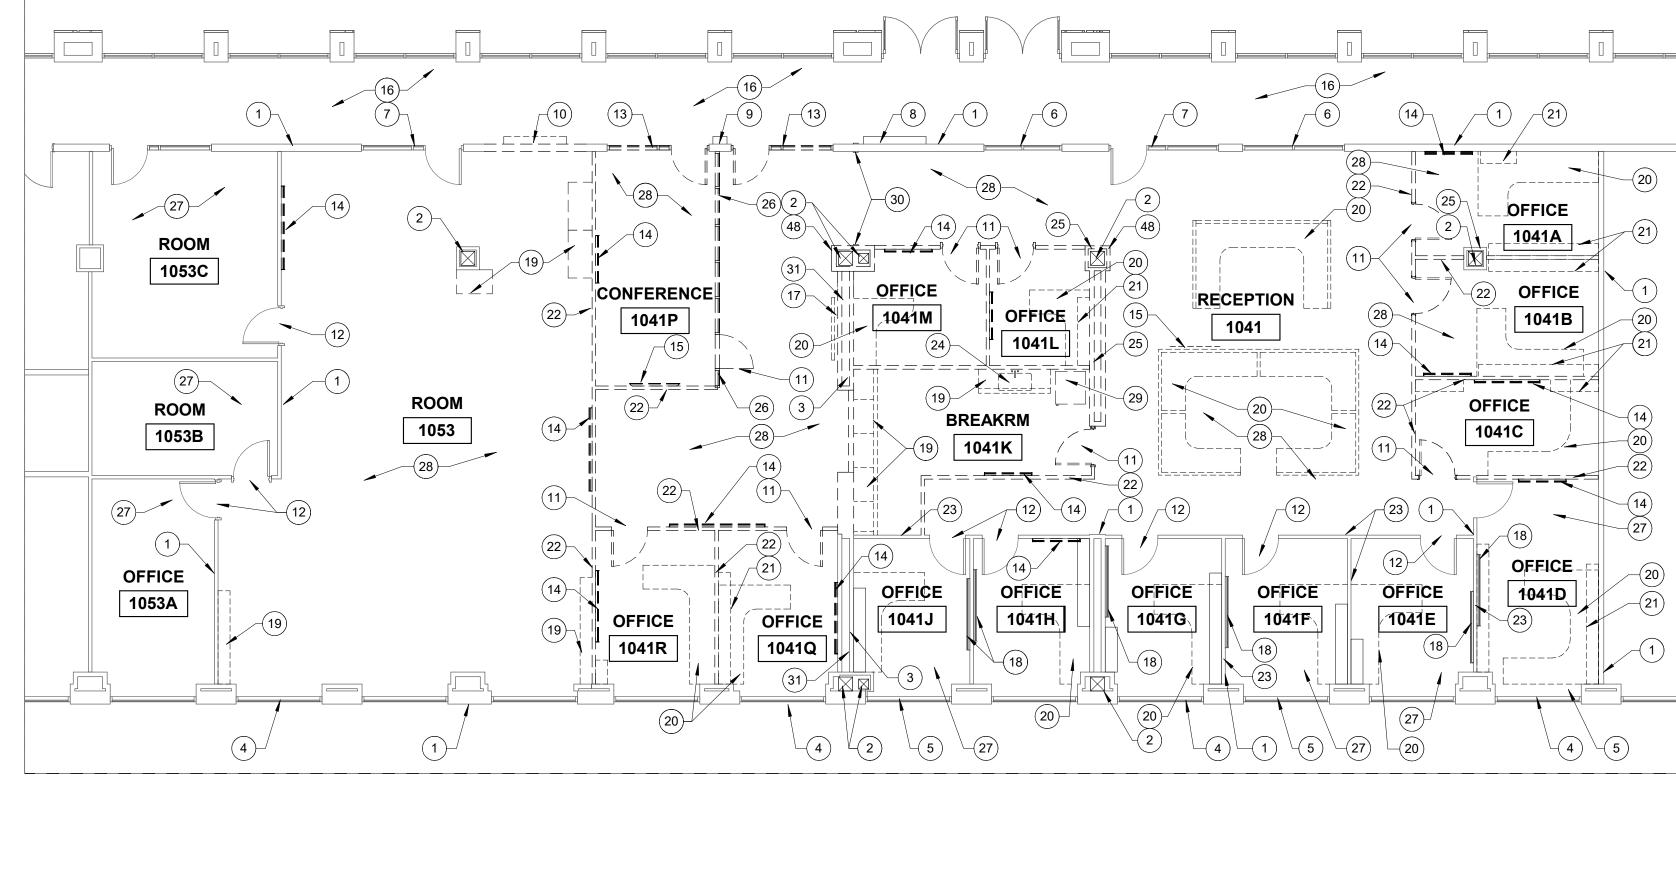

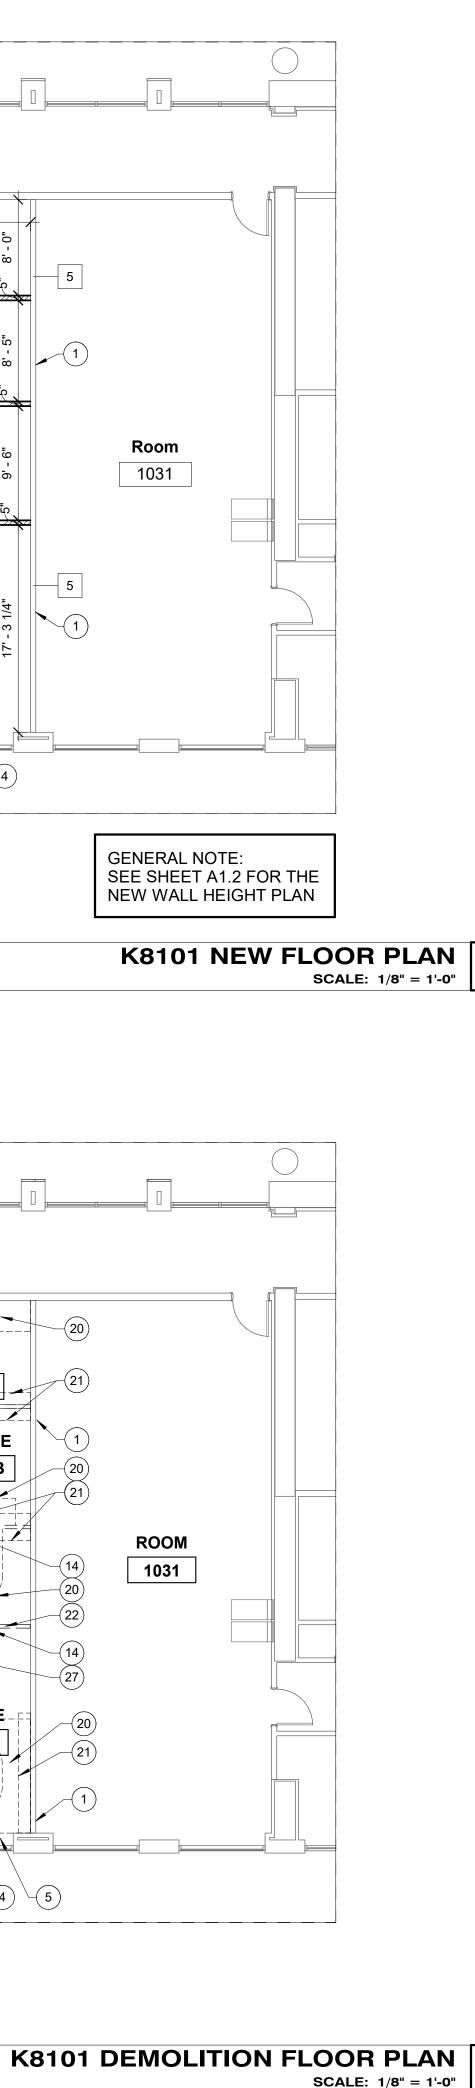

2

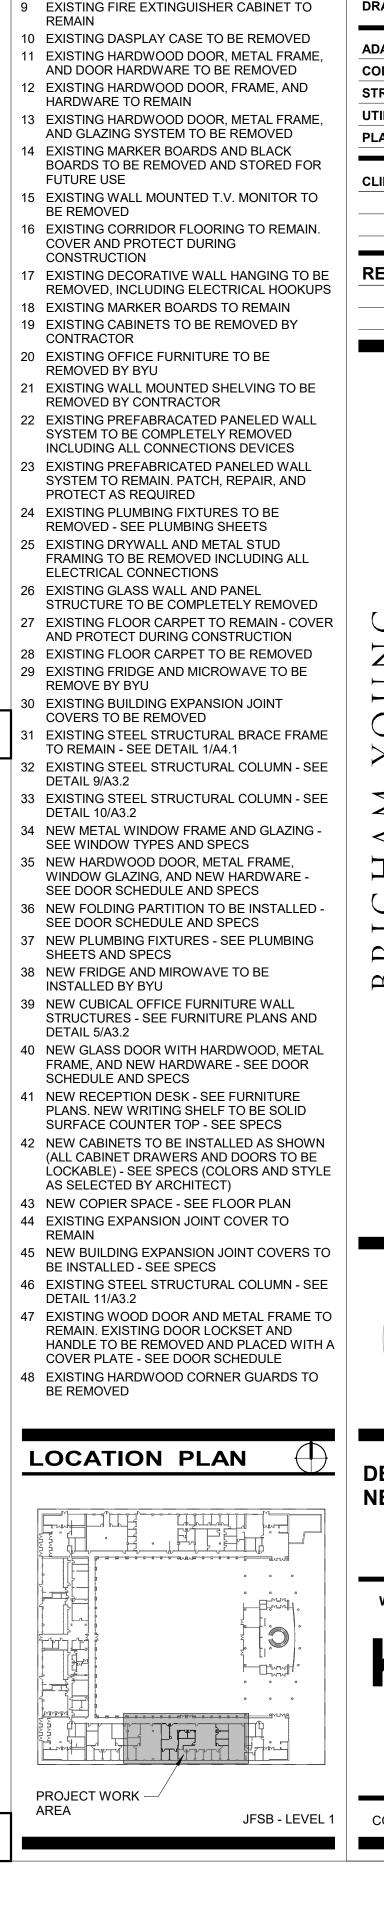

REFERENCE NOTES

AND REPAIR AS REQUIRED DUE TO DEMOLITION AND NEW CONSTRUCTION

REMAIN - SEE BUILDING SECTION

BLINDS TO REMAIN

PROTECT AS REQUIRED

8 EXISTING DISPLAY CASE TO REMAIN

EXISTING CONSTRUCTION TO REMAIN. PATCH

2 EXISTING STRUCTURAL COLUMNS TO REMAIN

3 EXISTING STRUCTURAL MOMENT FRAME TO

4 EXISTING EXTERIOR ALUM WINDOWS AND


EXISTING INTERIOR WINDOW SYSTEM TO

EXISTING SOLID SURFACE WINNDOW SILLS TO

REMAIN. COVER AND PROTECT AS REQUIRED

REMAIN. COVER AND PROTECT AS REQUIRED

EXISTING HARDWOOD DOOR. METAL FRAME AND GLAZING TO REMAIN. COVER AND

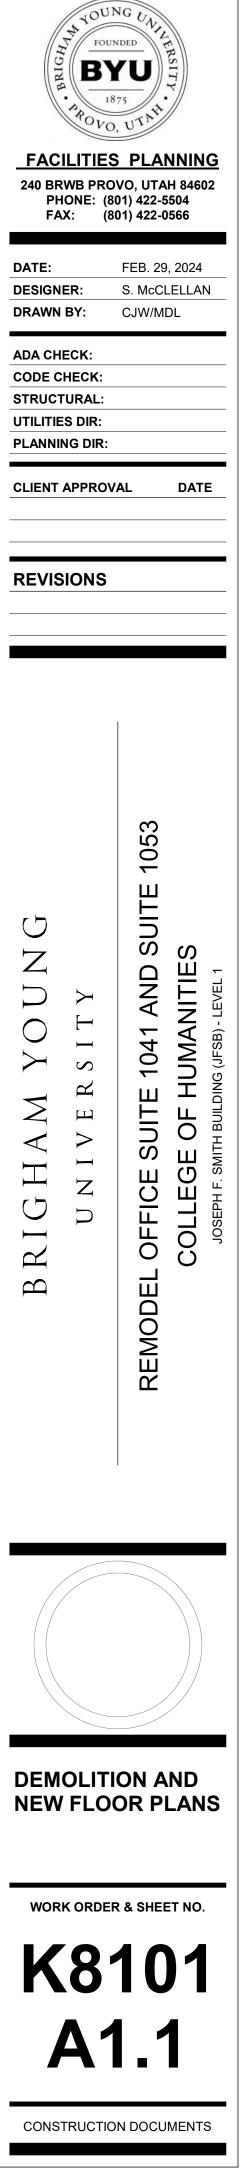





240 BRWB PRO PHONE: (80	PLANNING VO, UTAH 84602 01) 422-5504 01) 422-0566 FEB. 29, 2024 S. McCLELLAN MDL
BRIGHAM YOUNG UNIVERSITY	REMODEL OFFICE SUITE 1041 AND SUITE 1053 COLLEGE OF HUMANITIES
WINDOW I WALL HEI FLOOR PL	-


CONSTRUCTION DOCUMENTS




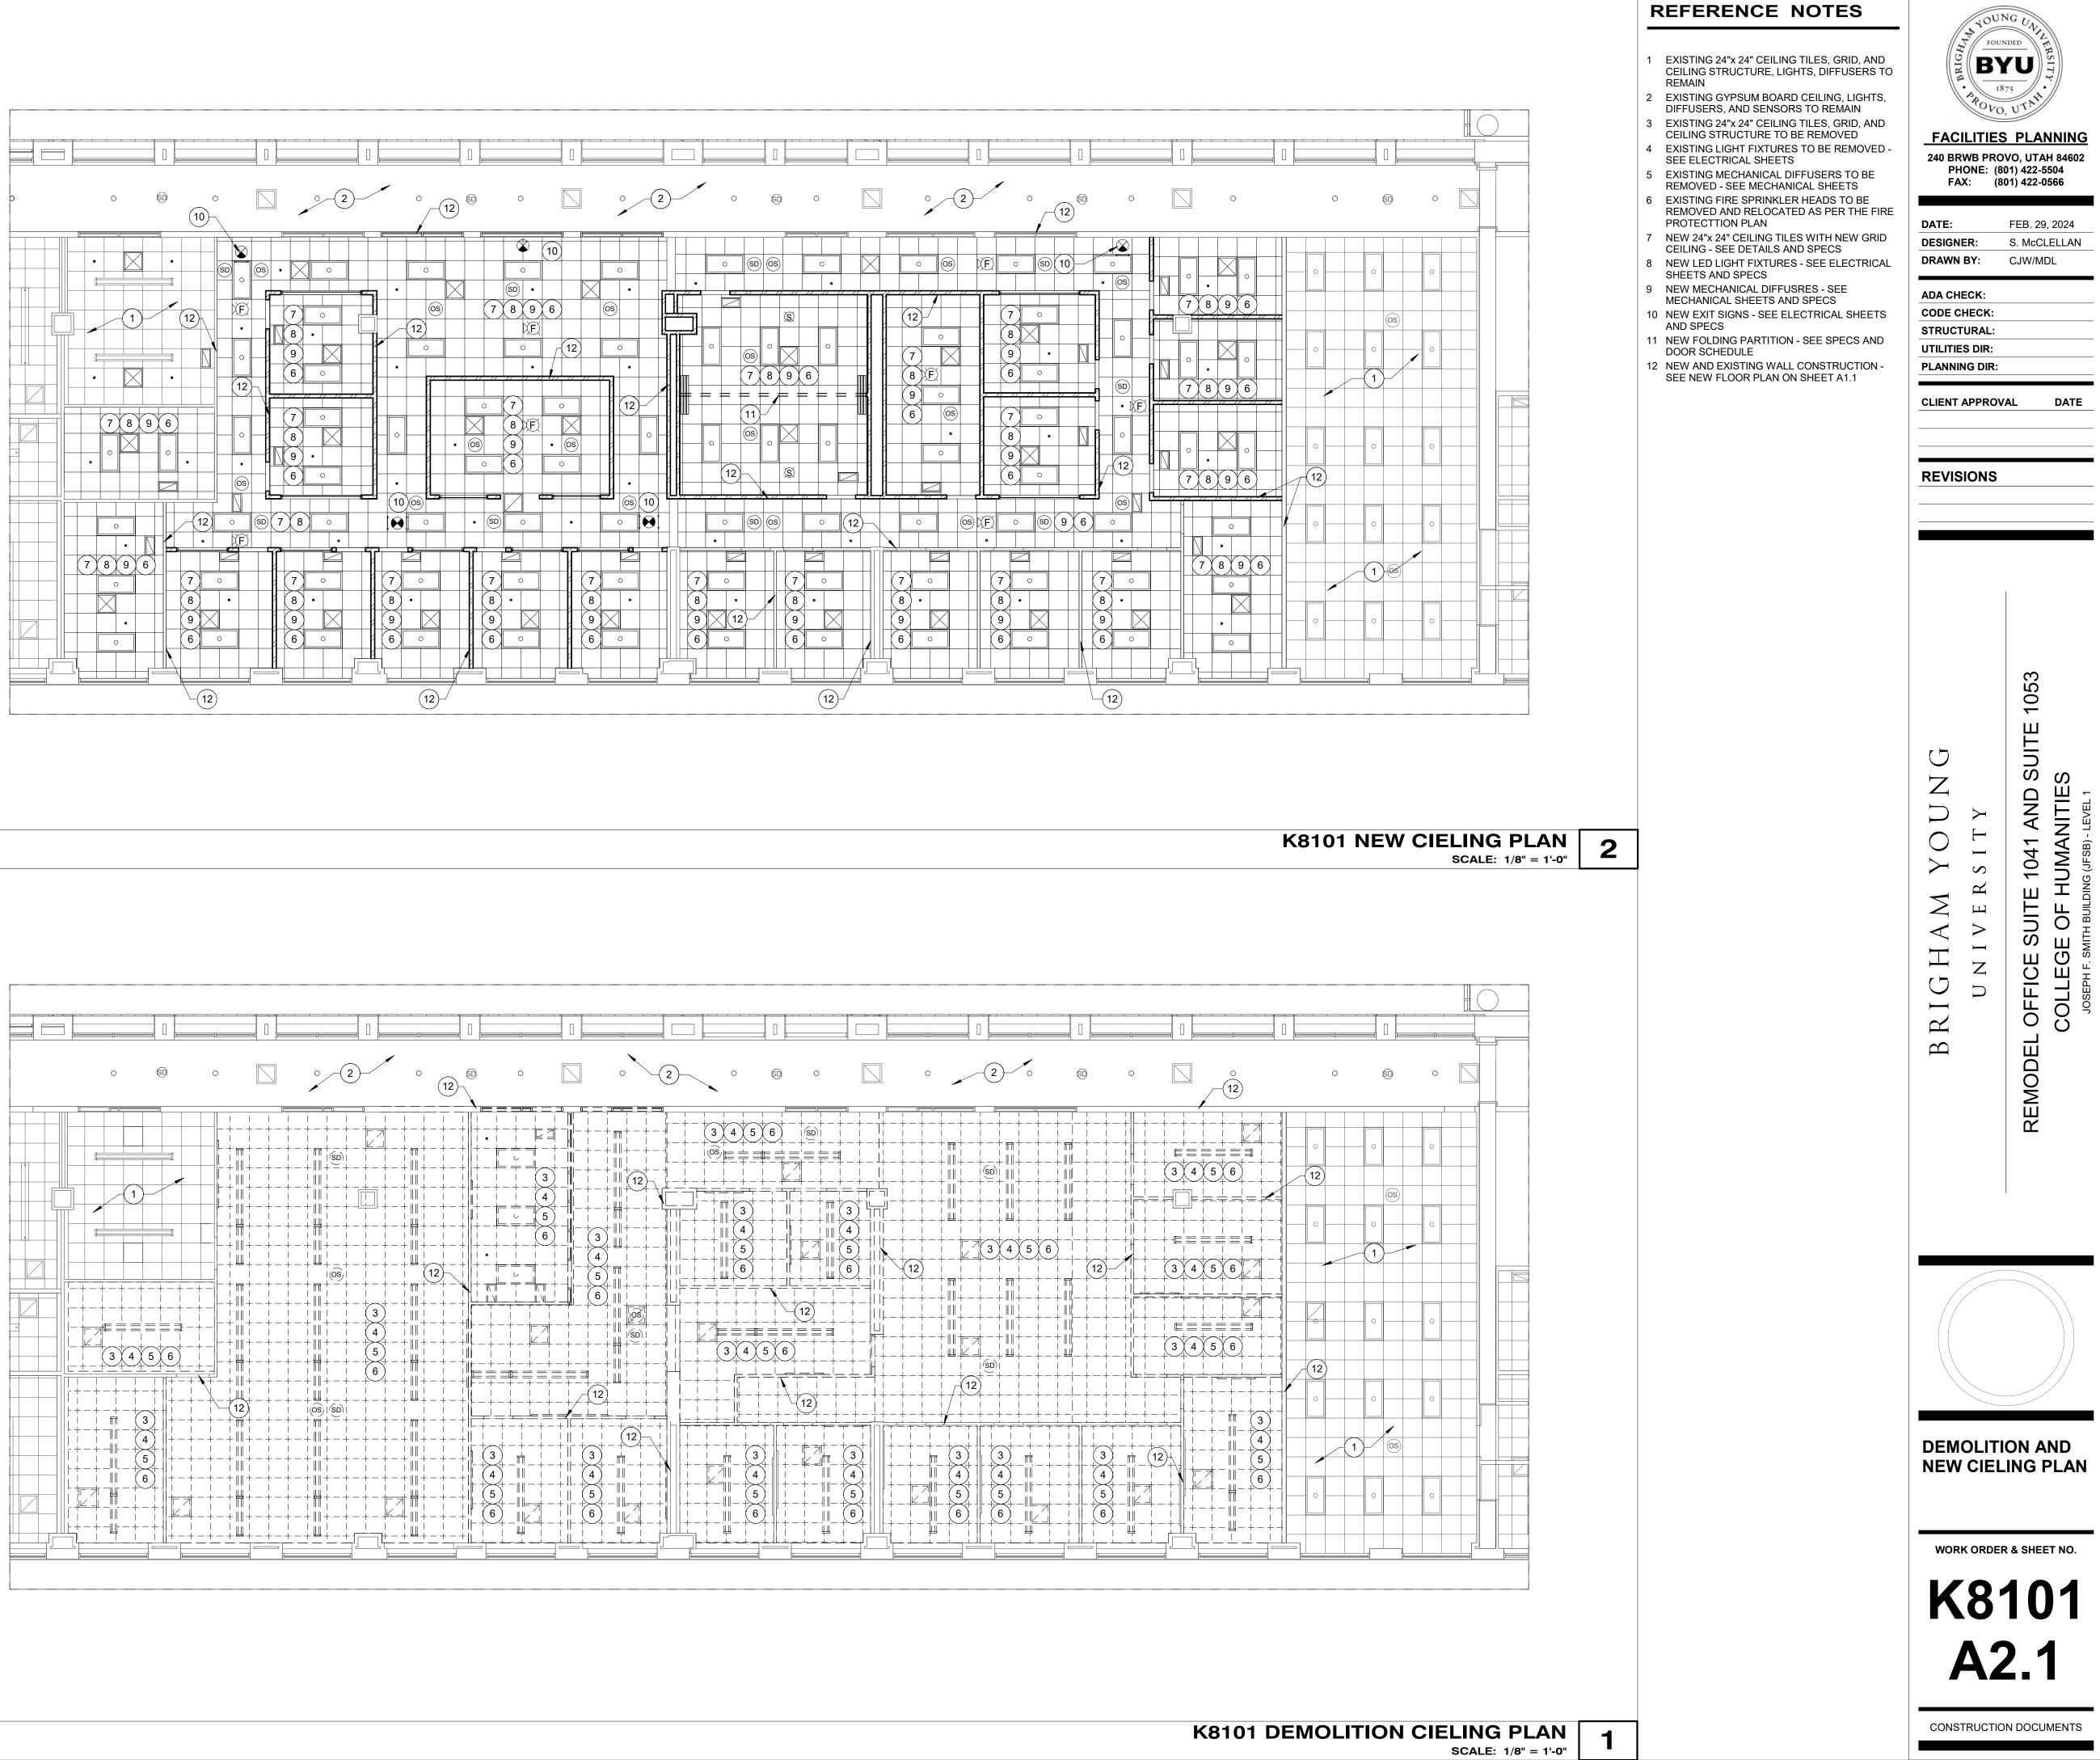


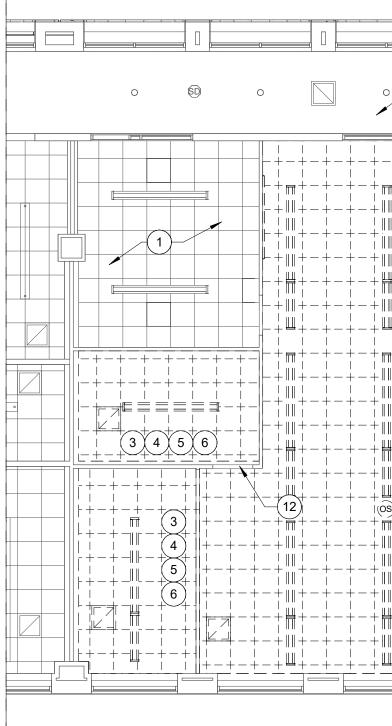



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R	EFERENCE NOTES	LYOI	UNG UN
1	EXISTING FLOOR CARPET TO REMAIN - COVER AND PROTECT DURING	BRIGHAN PO	UNG UNIVERSITY
2	CONSTRUCTION EXISTING CORRIDOR FLOORING TO REMAIN. COVER AND PROTECT DURING	1.	0, UTAN
3	CONSTRUCTION NEW FLOOR CARPET TO BE INSTALLED BY		
4	BYU SHOPS - BUILDING STANDARDS NEW LVT TILE FLOORING TO BE INSTALLED		S PLANNING
	BY BYU SHOPS - COLOR TO BE 8705, "ENGLISH OAK BIEGE"	PHONE:	OVO, UTAH 84602 (801) 422-5504 (801) 422-0566
5	EXISTING KV SHELVING TO REMAIN, PATCH AND REPAIR AS REQUIRED		
6	NEW KV SHELVES TO BE INSTALLED AS SHOWN - SEE SPECS	DATE:	FEB. 29, 2024
7	EXISTING MARKER BOARDS TO REMAIN NEW 4'x 6' MARKER BOARD - SEE SPECS	DESIGNER:	S. McCLELLAN
9 10	NEW 4'x 4' MARKER BOARD - SEE SPECS NEW 4'x 4' TACK BOARD - SEE SPECS	DRAWN BY:	MDL
11	NEW HARDWOOD CORNER GUARDS TO MATCH EXISTING COLOR, STYLE, AND SHAPE - GUARDS TO BE 2"x 2"x 48" HIGH	ADA CHECK: CODE CHECK:	
12	EXISTING EXTERIOR ALUM WINDOWS AND	STRUCTURAL:	
13	BLINDS TO REMAIN EXISTING SOLID SURFACE WINNDOW SILLS	UTILITIES DIR:	
	TO REMAIN. COVER AND PROTECT AS REQUIRED	PLANNING DIR	
14	EXISTING HARDWOOD DOOR, FRAME, AND HARDWARE TO REMAIN		VAL DATE
15	EXISTING WOOD DOOR AND METAL FRAME TO REMAIN. EXISTING DOOR LOCKSET AND HANDLE TO BE REMOVED AND PLACED WITH A COVER PLATE - SEE DOOR SCHEDULE		
16	NEW HARDWOOD DOOR, METAL FRAME, WINDOW GLAZING, AND NEW HARDWARE - SEE DOOR SCHEDULE AND SPECS	REVISIONS	6
17	EXISTING CONSTRUCTION TO REMAIN. PATCH AND REPAIR AS REQUIRED DUE TO		
18	DEMOLITION AND NEW CONSTRUCTION SEE SHEET F1 FOR THE NEW FURNITURE LAYOUT		
19	NEW RECEPTION DESK - SEE FURNITURE PLANS. NEW WRITING SHELF TO BE SOLID		
20	SURFACE COUNTER TOP - SEE SPECS NEW SOLID SURFACE WRITING SHELF (SIZE: 14'-9"x 15" AND 3'-4"x 15") COLOR IS STARON		
21	FW145 "WHIPPOORWILL" - SEE SPECS NEW 3'x 5' MARKER BOARD - SEE SPECS		
22	NEW WALL MOUNTED T.V. MONITOR - SEE ELECTRICAL AND OIT SHEETS		
23	NEW FOLDING PARTITION - SEE SPECS AND DOOR SCHEDULE		1053
24	NEW COPIER SPACE - SEE FLOOR PLAN		10
25	NEW CABINETS TO BE INSTALLED AS SHOWN (ALL CABINET DRAWERS AND DOORS TO BE		
	LOCKABLE) - SEE SPECS (COLORS AND STYLE AS SELECTED BY ARCHITECT)	U	SUI ⁻
26	NEW PLUMBING FIXTURES - SEE PLUMBING SHEETS AND SPECS	Z	
27	NEW FRIDGE AND MIROWAVE TO BE INSTALLED BY BYU	Λ I	
28	NEW A/V CABINET WITH (5) ADJUSTABLE SHELVES - COLORS AS SELECTED BY THE	D U	E 1041 AND HUMANITIE DING (JFSB) - LEVEL 1
29	ARCHITECT - SEE SPECS EXISTING INTERIOR WINDOW SYSTEM TO	Y C s I	
30	REMAIN. COVER AND PROTECT AS REQUIRED EXISTING PREFABRICATED PANELED WALL	~	
	SYSTEM TO REMAIN. PATCH, REPAIR, AND PROTECT AS REQUIRED	E Z	
31	EXISTING HARDWOOD DOOR, METAL FRAME AND GLAZING TO REMAIN. COVER AND	I V E I	E SUITE 1041 AND SE OF HUMANITIE SMITH BUILDING (JFSB) - LEVEL 1
32	PROTECT AS REQUIRED NEW METAL WINDOW FRAME AND GLAZING -	H	
33	SEE WINDOW TYPES AND SPECS NEW GLASS DOOR WITH HARDWOOD, METAL FRAME, AND NEW HARDWARE - SEE DOOR	U D	
34	SCHEDULE AND SPECS EXISTING FIRE EXTINGUISHER CABINET TO	RI	I O O S
35	REMAIN EXISTING DISPLAY CASE TO REMAIN	P	
36	EXISTING EXPANSION JOINT COVER TO REMAIN		REMODE
37	NEW BUILDING EXPANSION JOINT COVERS TO BE INSTALLED - SEE SPECS		Σ.
38 39	NEW ROOM SIGNAGE BY THE BYU SIGN SHOP NEW CHAIR MATS TO BE INSTALLED		
	FINISH SCHEDULE		
	<u>DORS:</u> 1 - EXISTING FLOOR TILES TO REMAIN. COVER AND PROTECT DURING CONSTRUCTION.		
F	2 - EXISTING FLOOR CARPET TO REMAIN. COVER AND PROTECT DURING		
F	COVER AND PROTECT DURING CONSTRUCTION AND CLEAN. 3 - NEW FLOOR CARPET TO BE INSTALLED BY		
	BYU SHOPS - (BUILDING STANDARD) 4 - NEW LVT TILE FLOORING INSTALLED BY		
"	BYU SHOPS -		

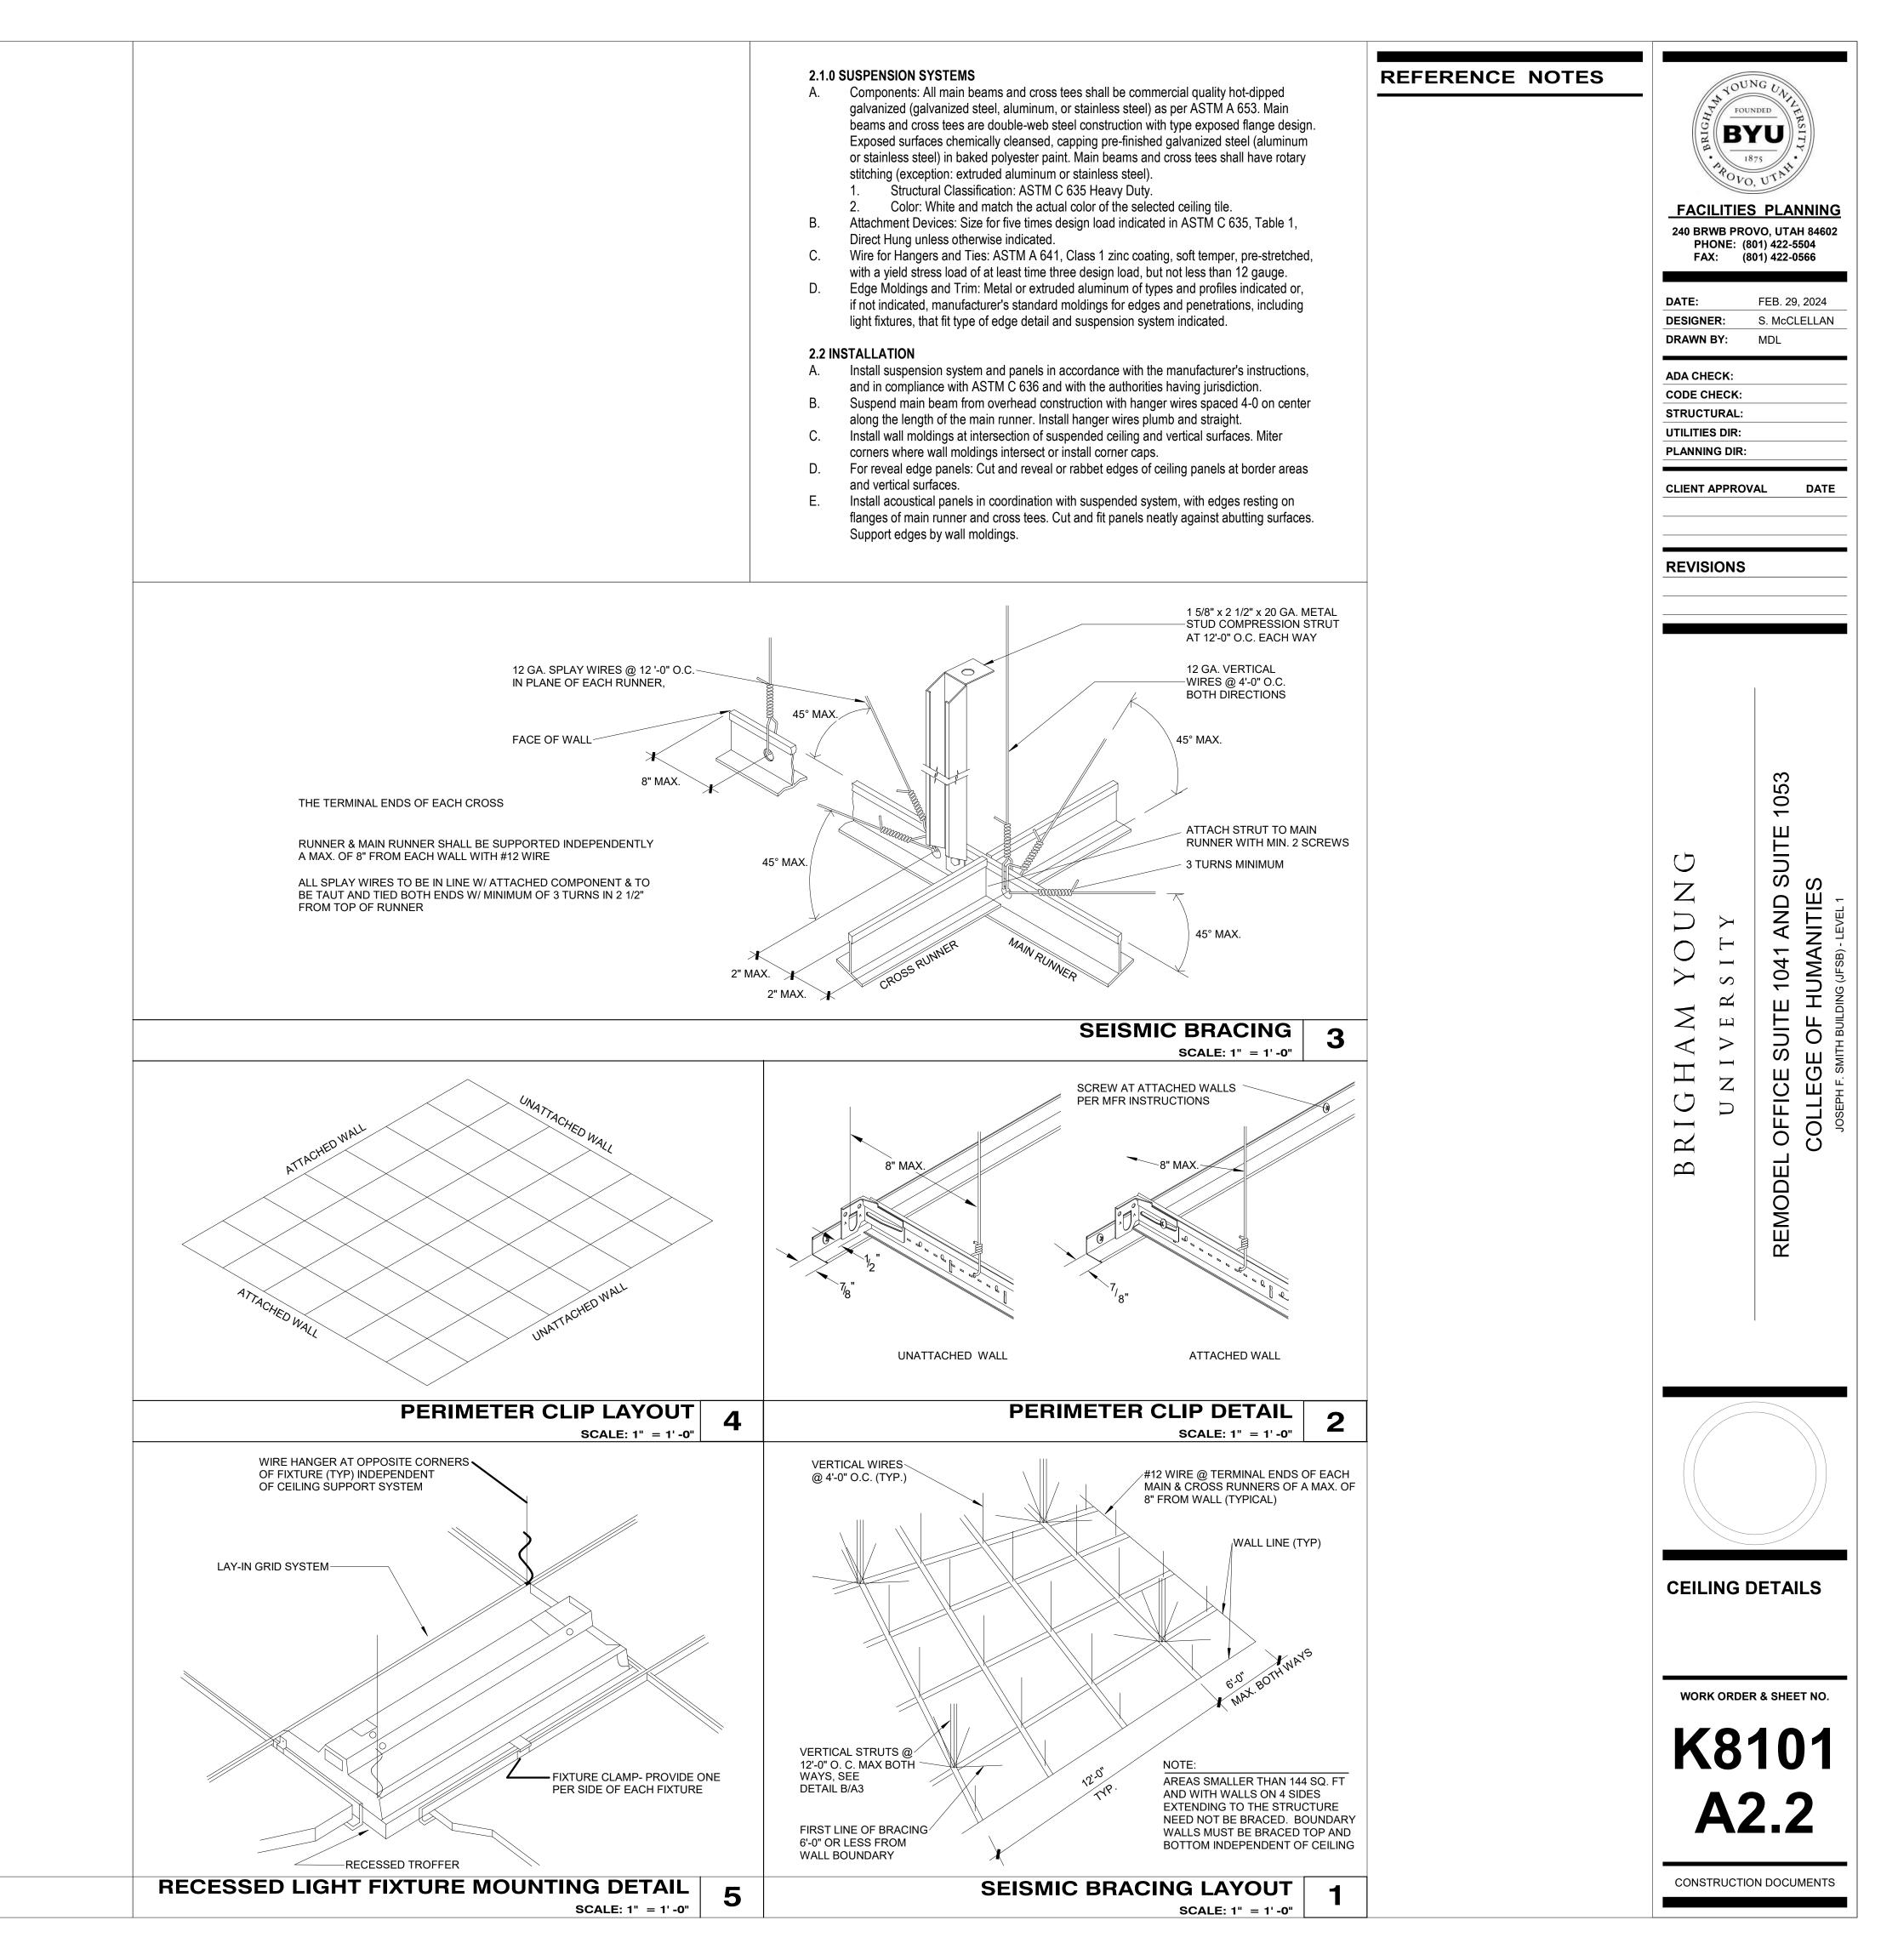SCALE: 3/16" = 1'-0"

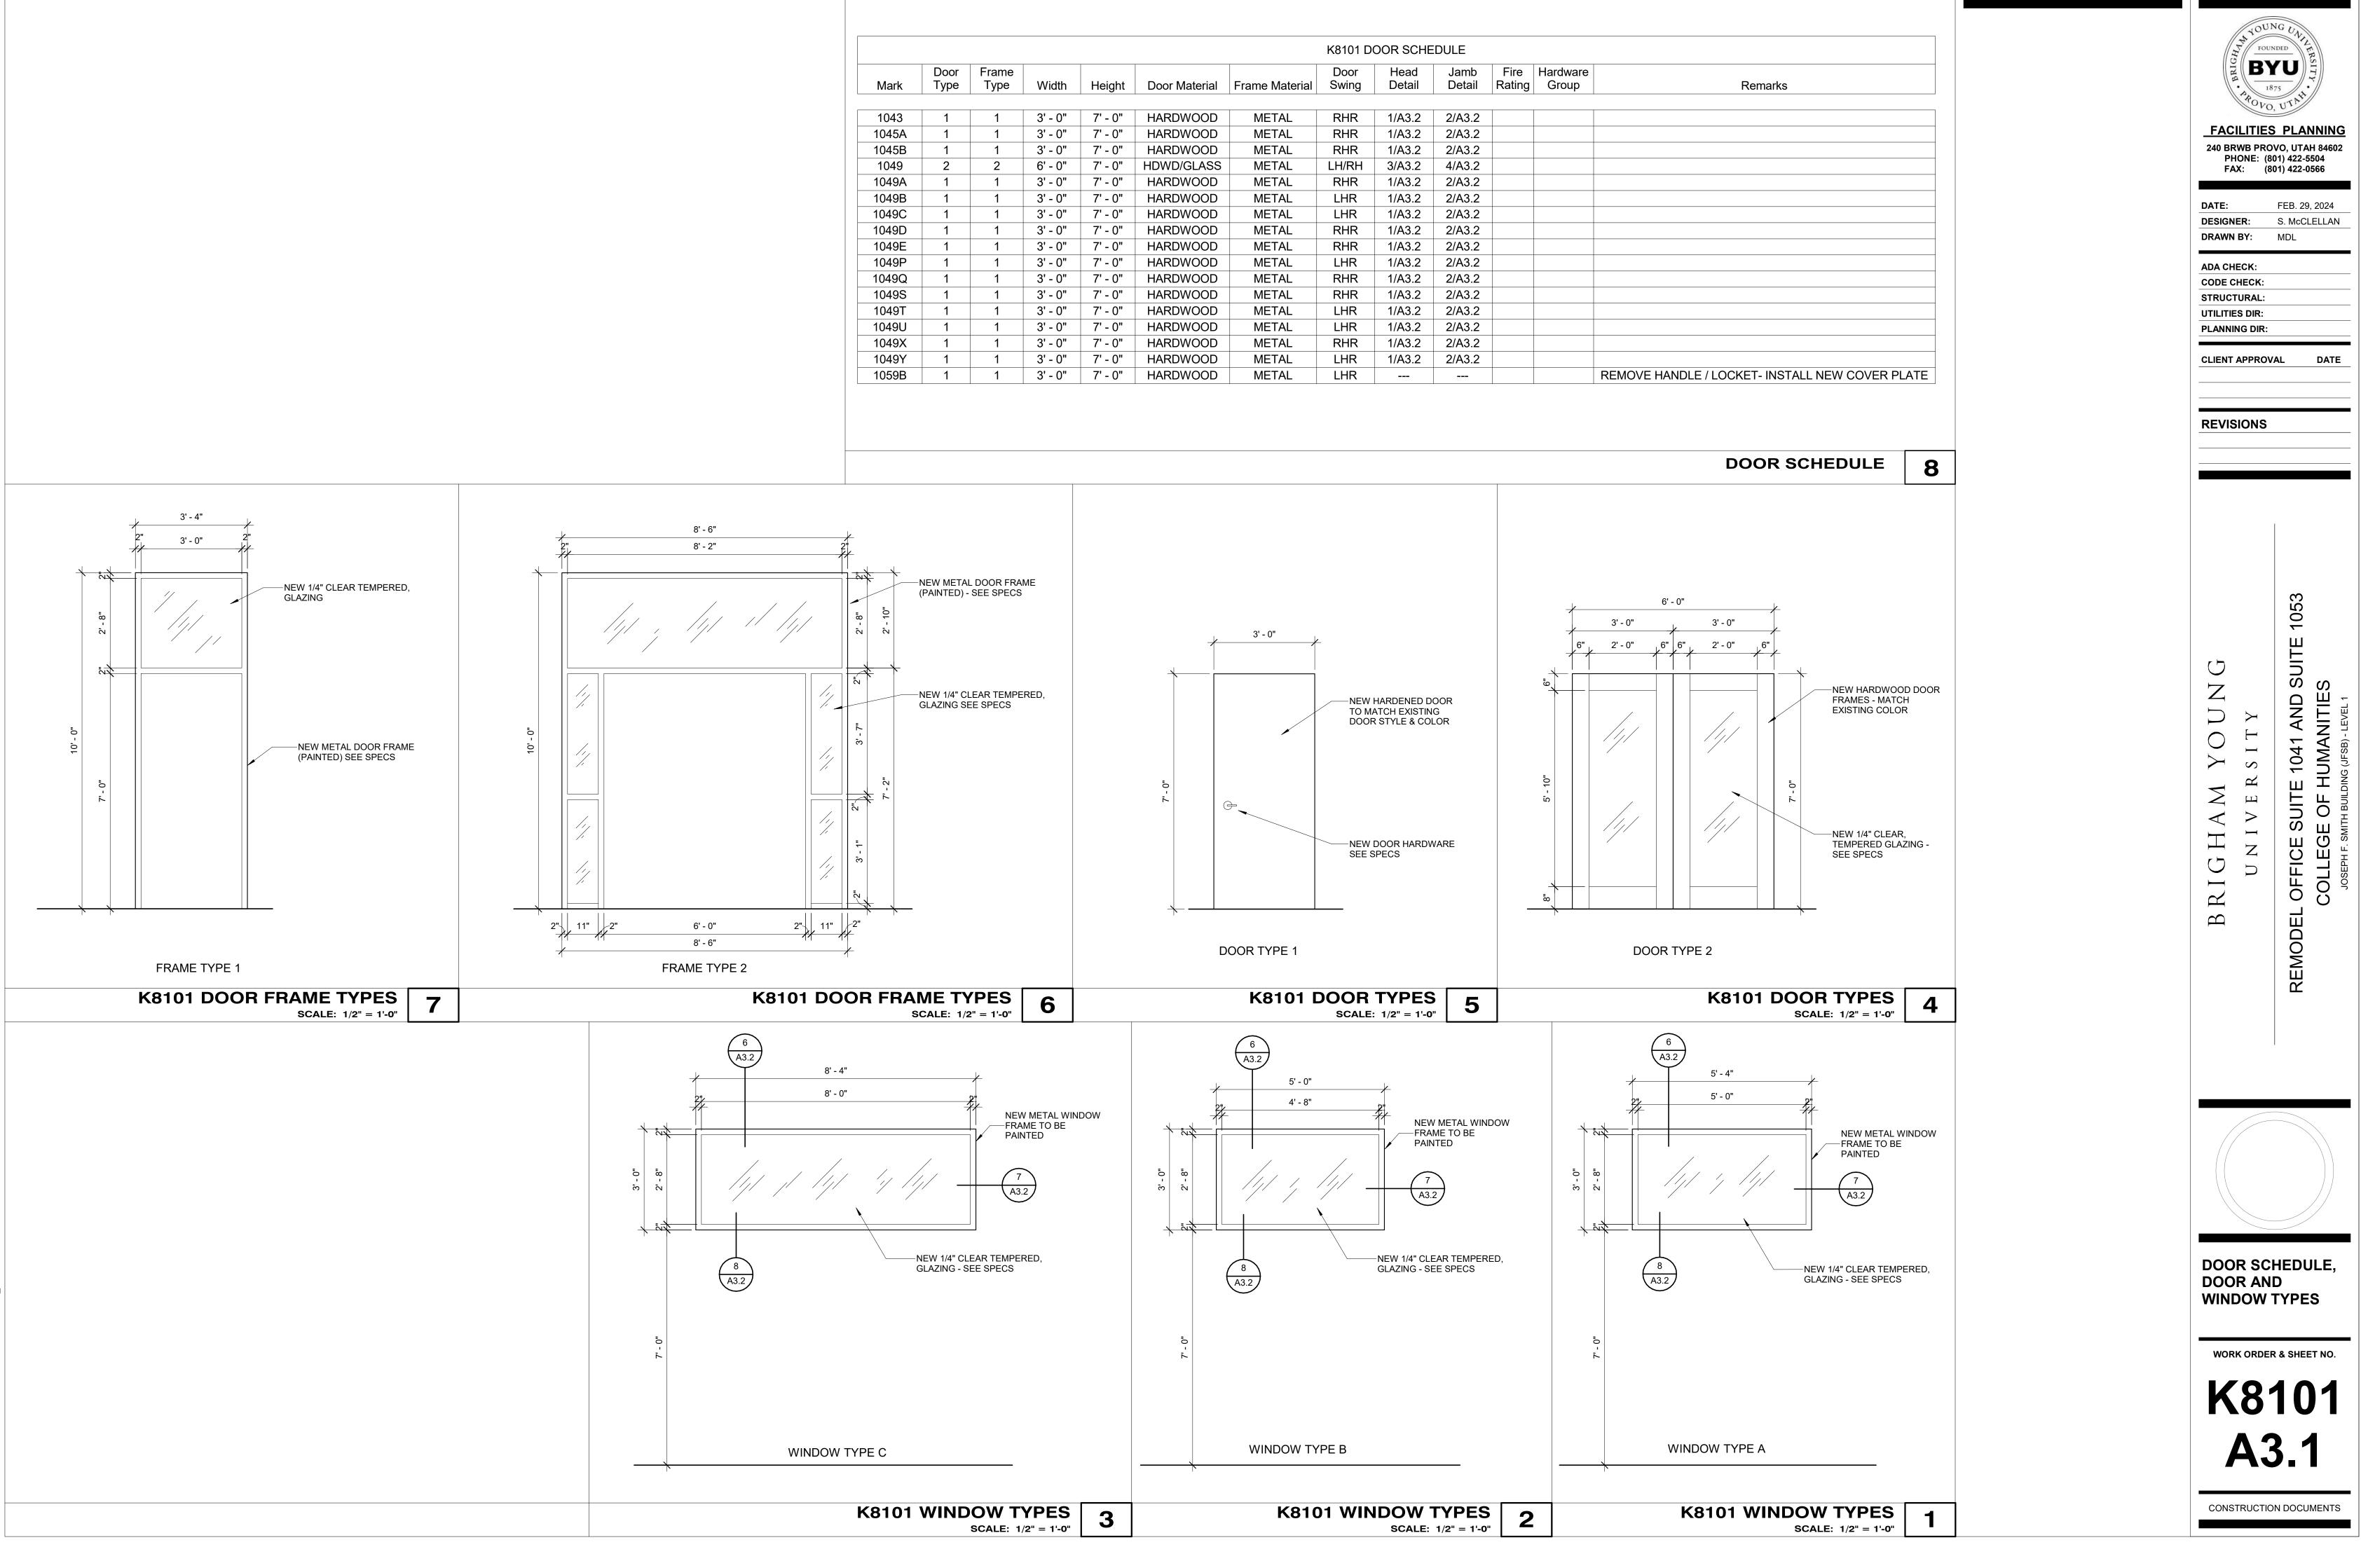- BASE: B1 EXISTING WOOD BASE TO REMAIN. PATCH AND REPAIR AS REQUIRED
- B2 EXISTING CARPET BASE TO REMAIN.
- B3 EXISTING METAL BASE RAIL TO REMAIN.
- **B4 NEW WOOD BASE MATCH EXISTING** COLOR, STYLE, AND PROFILE
- B5 NEW CARPET BASE INSTALLED BY BYU
- SHOPS BUILDING STANDARD B6 - NEW RUBBER BASE - MATCH EXISTING
- BUILDING STANDARD

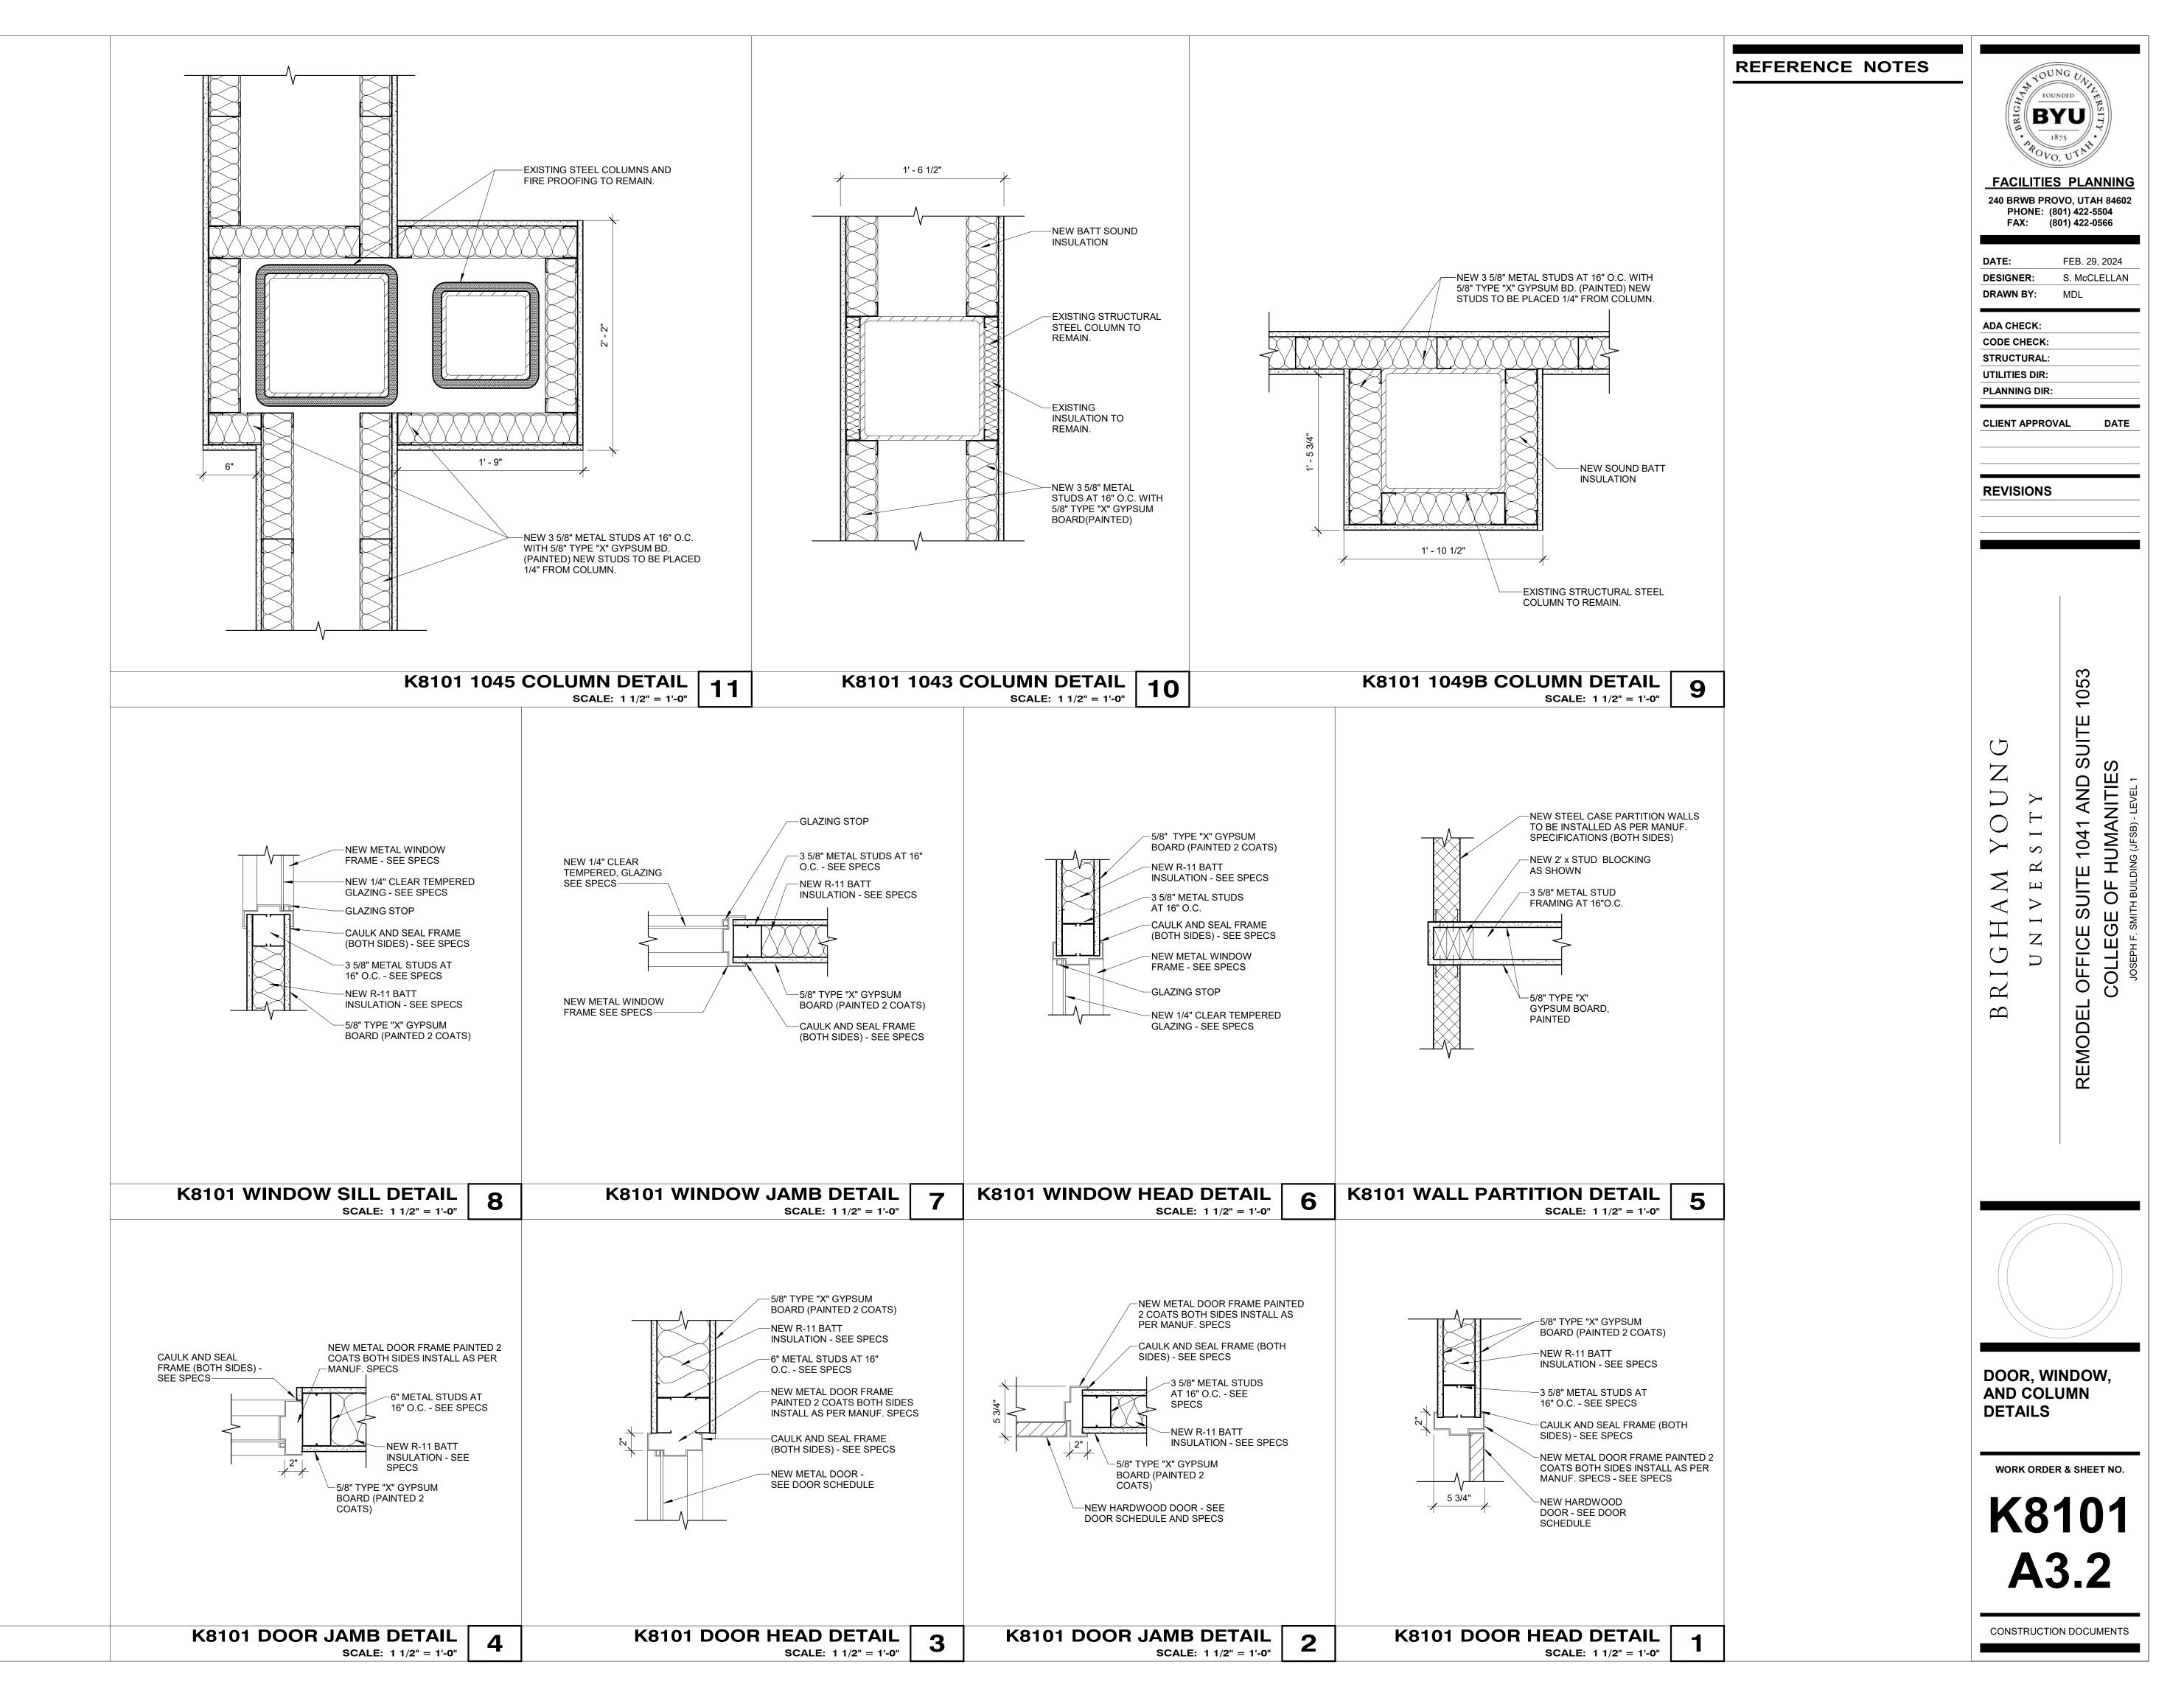WALLS: W1 - EXISTING GYPSUM BOARD TO REMAIN.

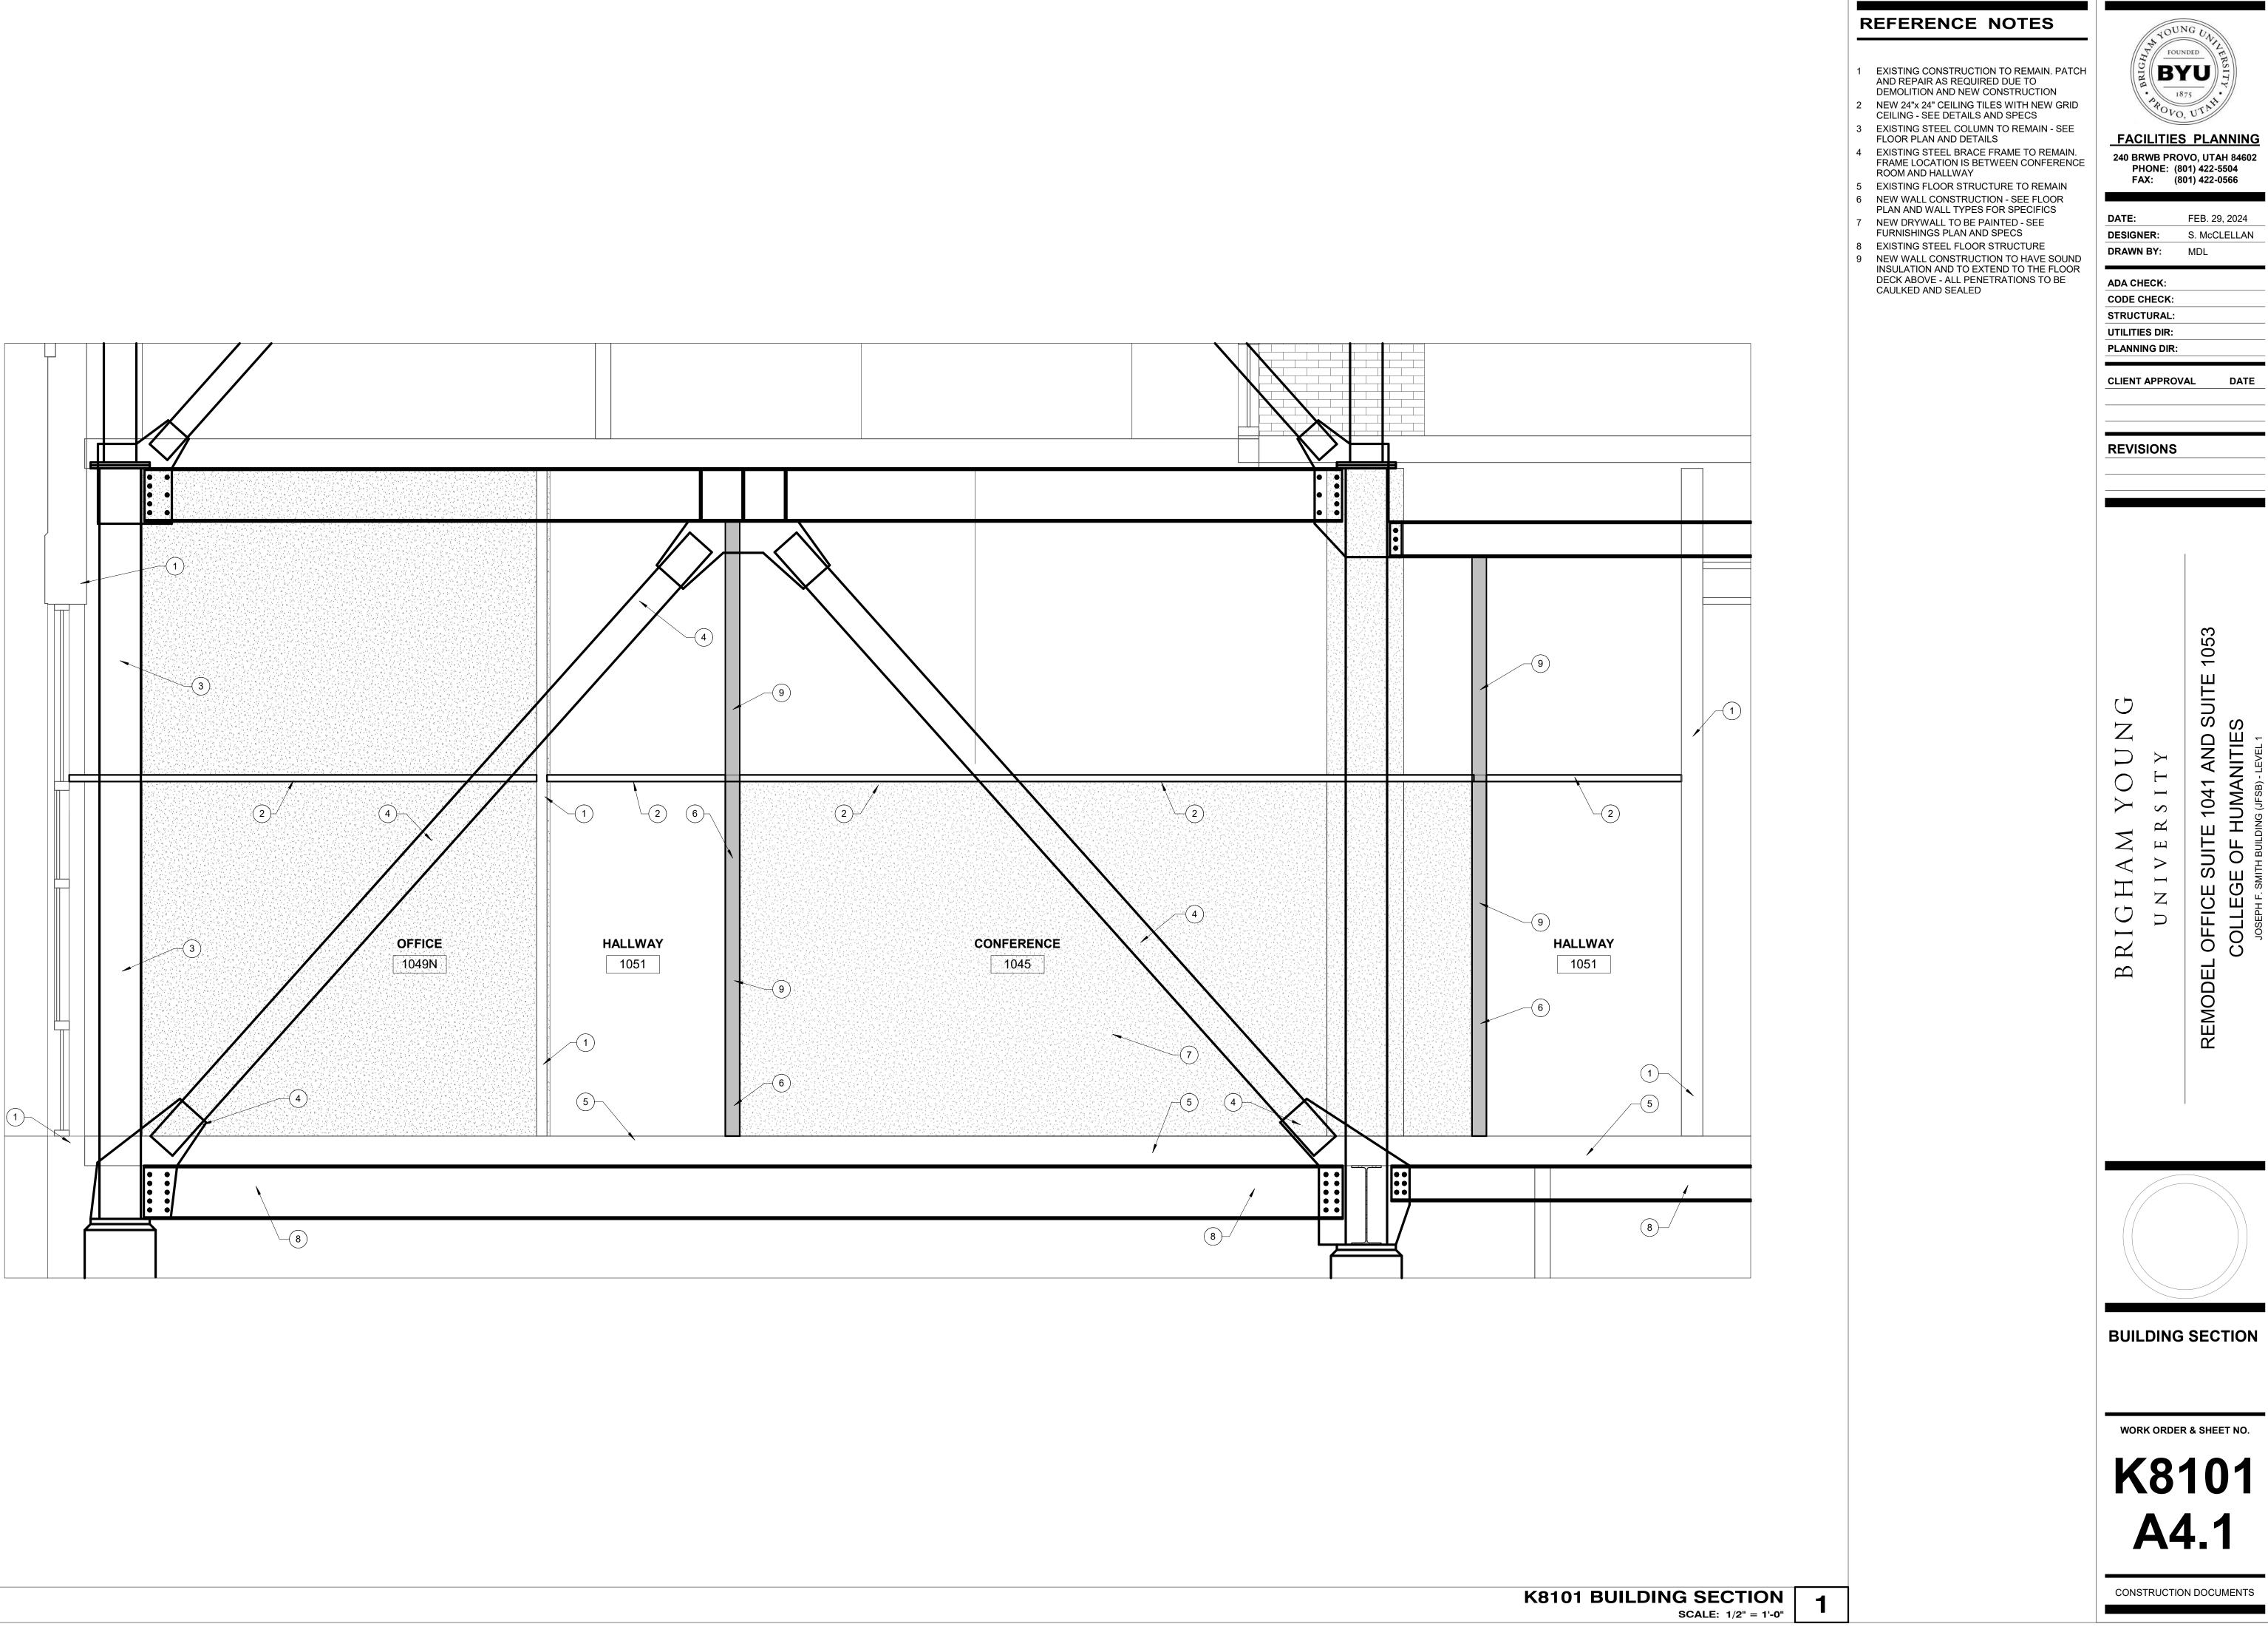- PATCH, REPAIR, AND CLEAN W2 - EXISTING PRE-FABRICATED WALL PANELS
- TO REMAIN CLEAN AS REQUIRED W3 - NEW GYPSUM BOARD TO BE PAINTED (2) COATS - BUILDING STANDARD COLORS
- W4 EXISTING GYPSUM BOARD TO BE PAINTED
- (2) COATS MATCH EXISTING W5 NEW GYPSUM BOARD TO BE PAINTED (2) ACCENT COLOR
- CEILING: C1 EXISTING GYPSUM BOARD CEILING TO REMAIN. CLEAN AS REQUIRED
- C2 EXISTING 24"x 24" GRID CEILING C3 - NEW 2'x 2' LAY-IN ACOUSTICAL SYSTEM GRID: USG DOWN DX/DXL 26 HEAVY DUTY DUTY FLAT WHITE, TILE: USG FROST 484, 2x2x7/8" SHADOWLINE BEVEL, WHITE.

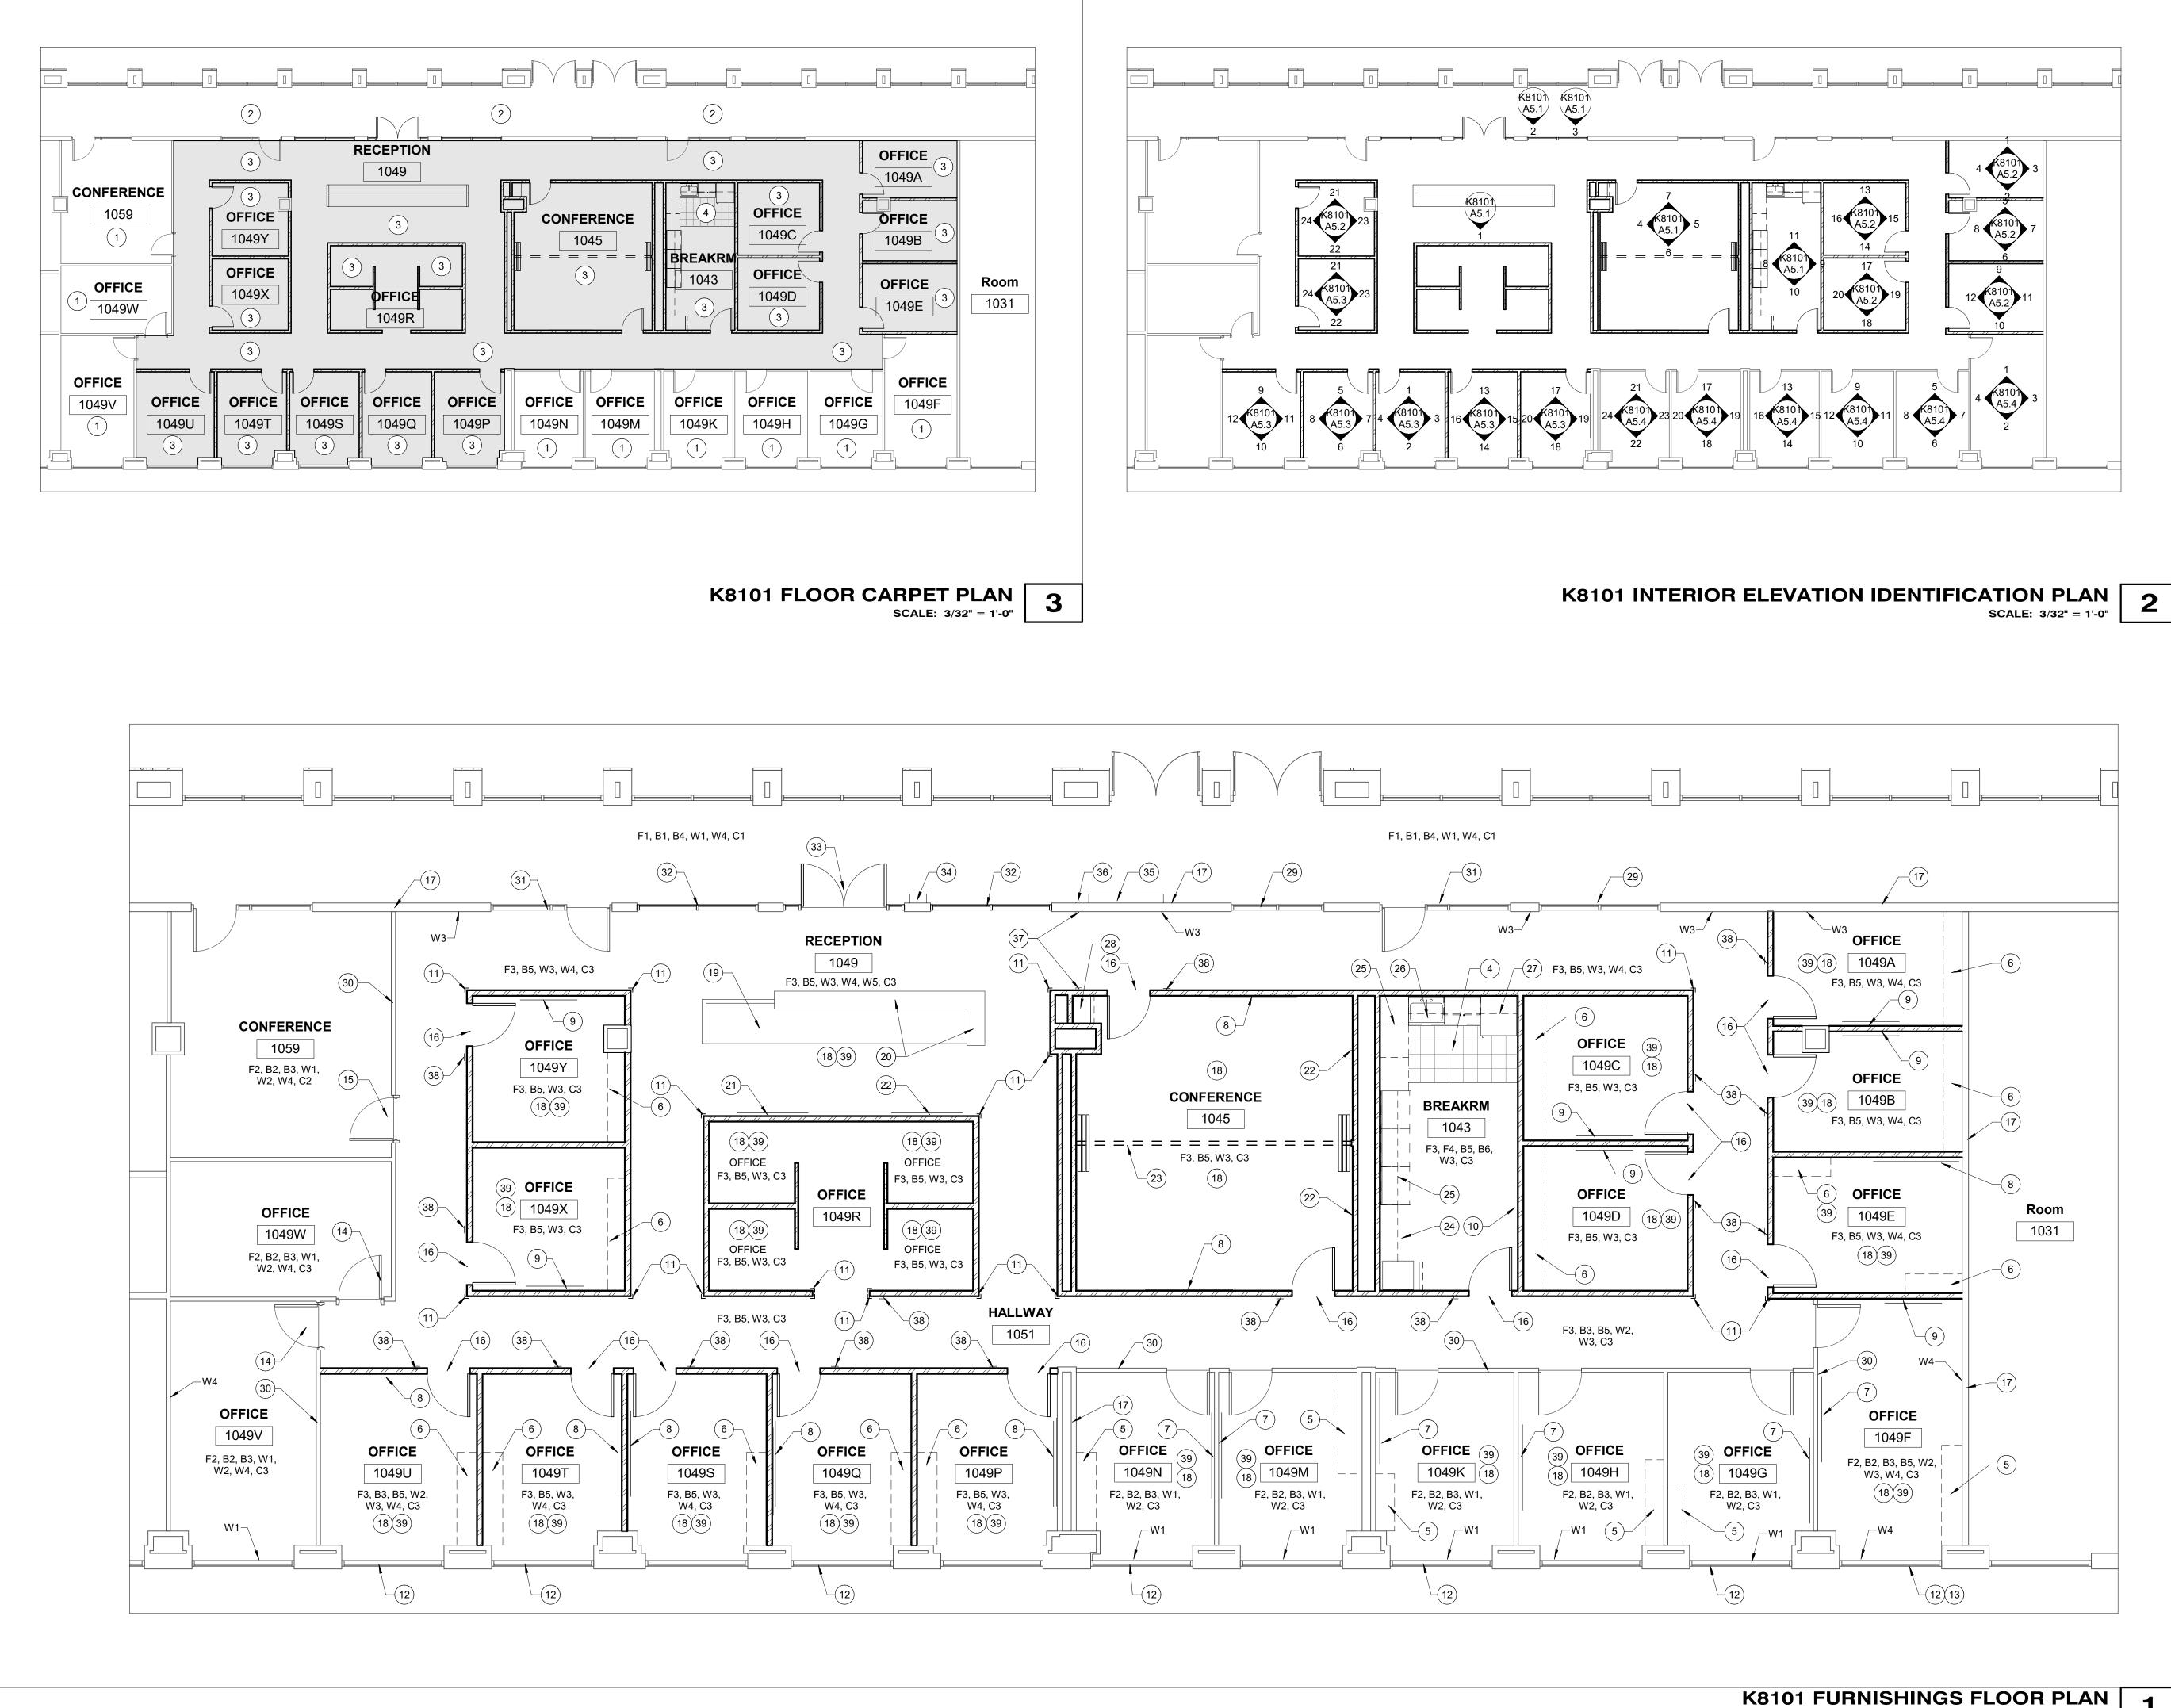CONSTRUCTION DOCUMENTS

INTERIOR FINISHES


WORK ORDER & SHEET NO.

K8101

A5.0


AND CARPET

FLOOR PLAN

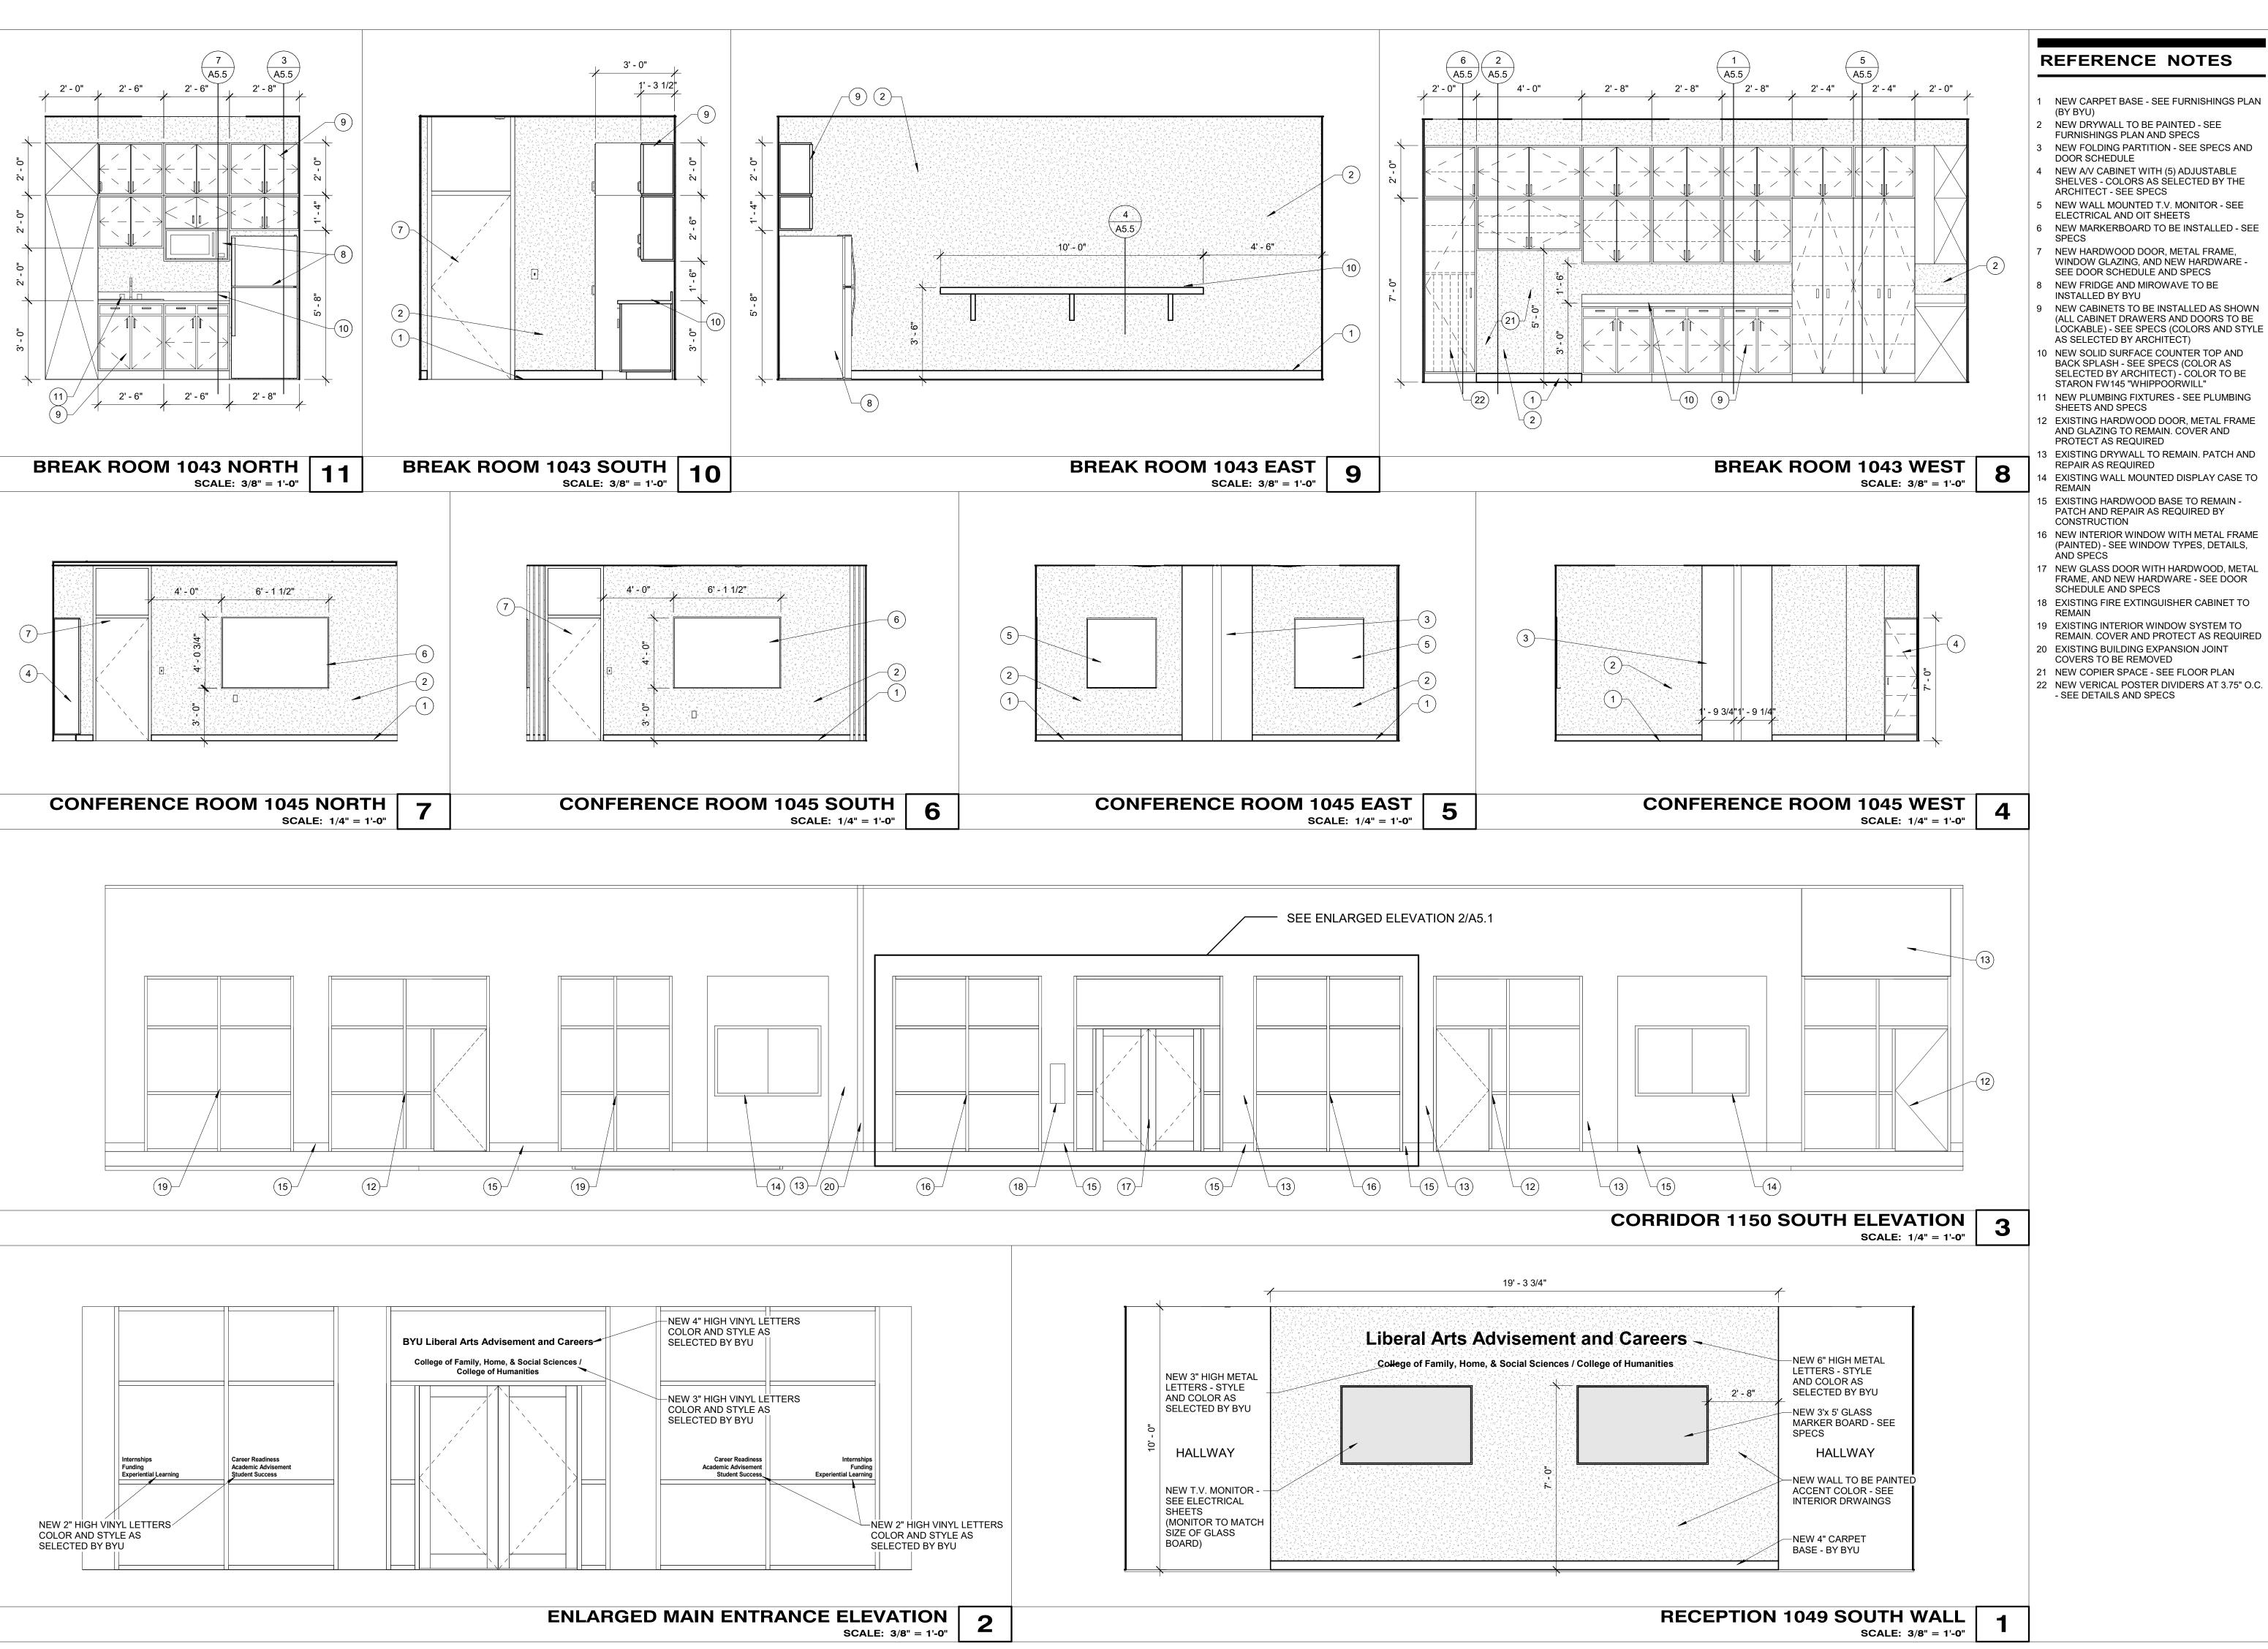


JOUNG FOUNDED BYU 1875 FACILITIES PLANNING 240 BRWB PROVO, UTAH 84602 PHONE: (801) 422-5504 FAX: (801) 422-0566 DATE: FEB. 29, 2024 DESIGNER: S. McCLELLAN DRAWN BY: MDL ADA CHECK: CODE CHECK: STRUCTURAL: UTILITIES DIR: PLANNING DIR: CLIENT APPROVAL DATE REVISIONS 1053 SUITE Ζ E 1041 AND HUMANITIE \supset >H \bigcirc Π $\boldsymbol{\mathcal{S}}$ \mathbf{R} Ш $\overline{}$ - OFFICE SUIT COLLEGE OF ΙVΕ $\boldsymbol{\triangleleft}$ \triangleleft Т Ζ \mathcal{O} \supset \simeq REMODEL Β **CONFERENCE & BREAK ROOM ELEVATIONS** WORK ORDER & SHEET NO. **K8101** A5.1


CONSTRUCTION DOCUMENTS

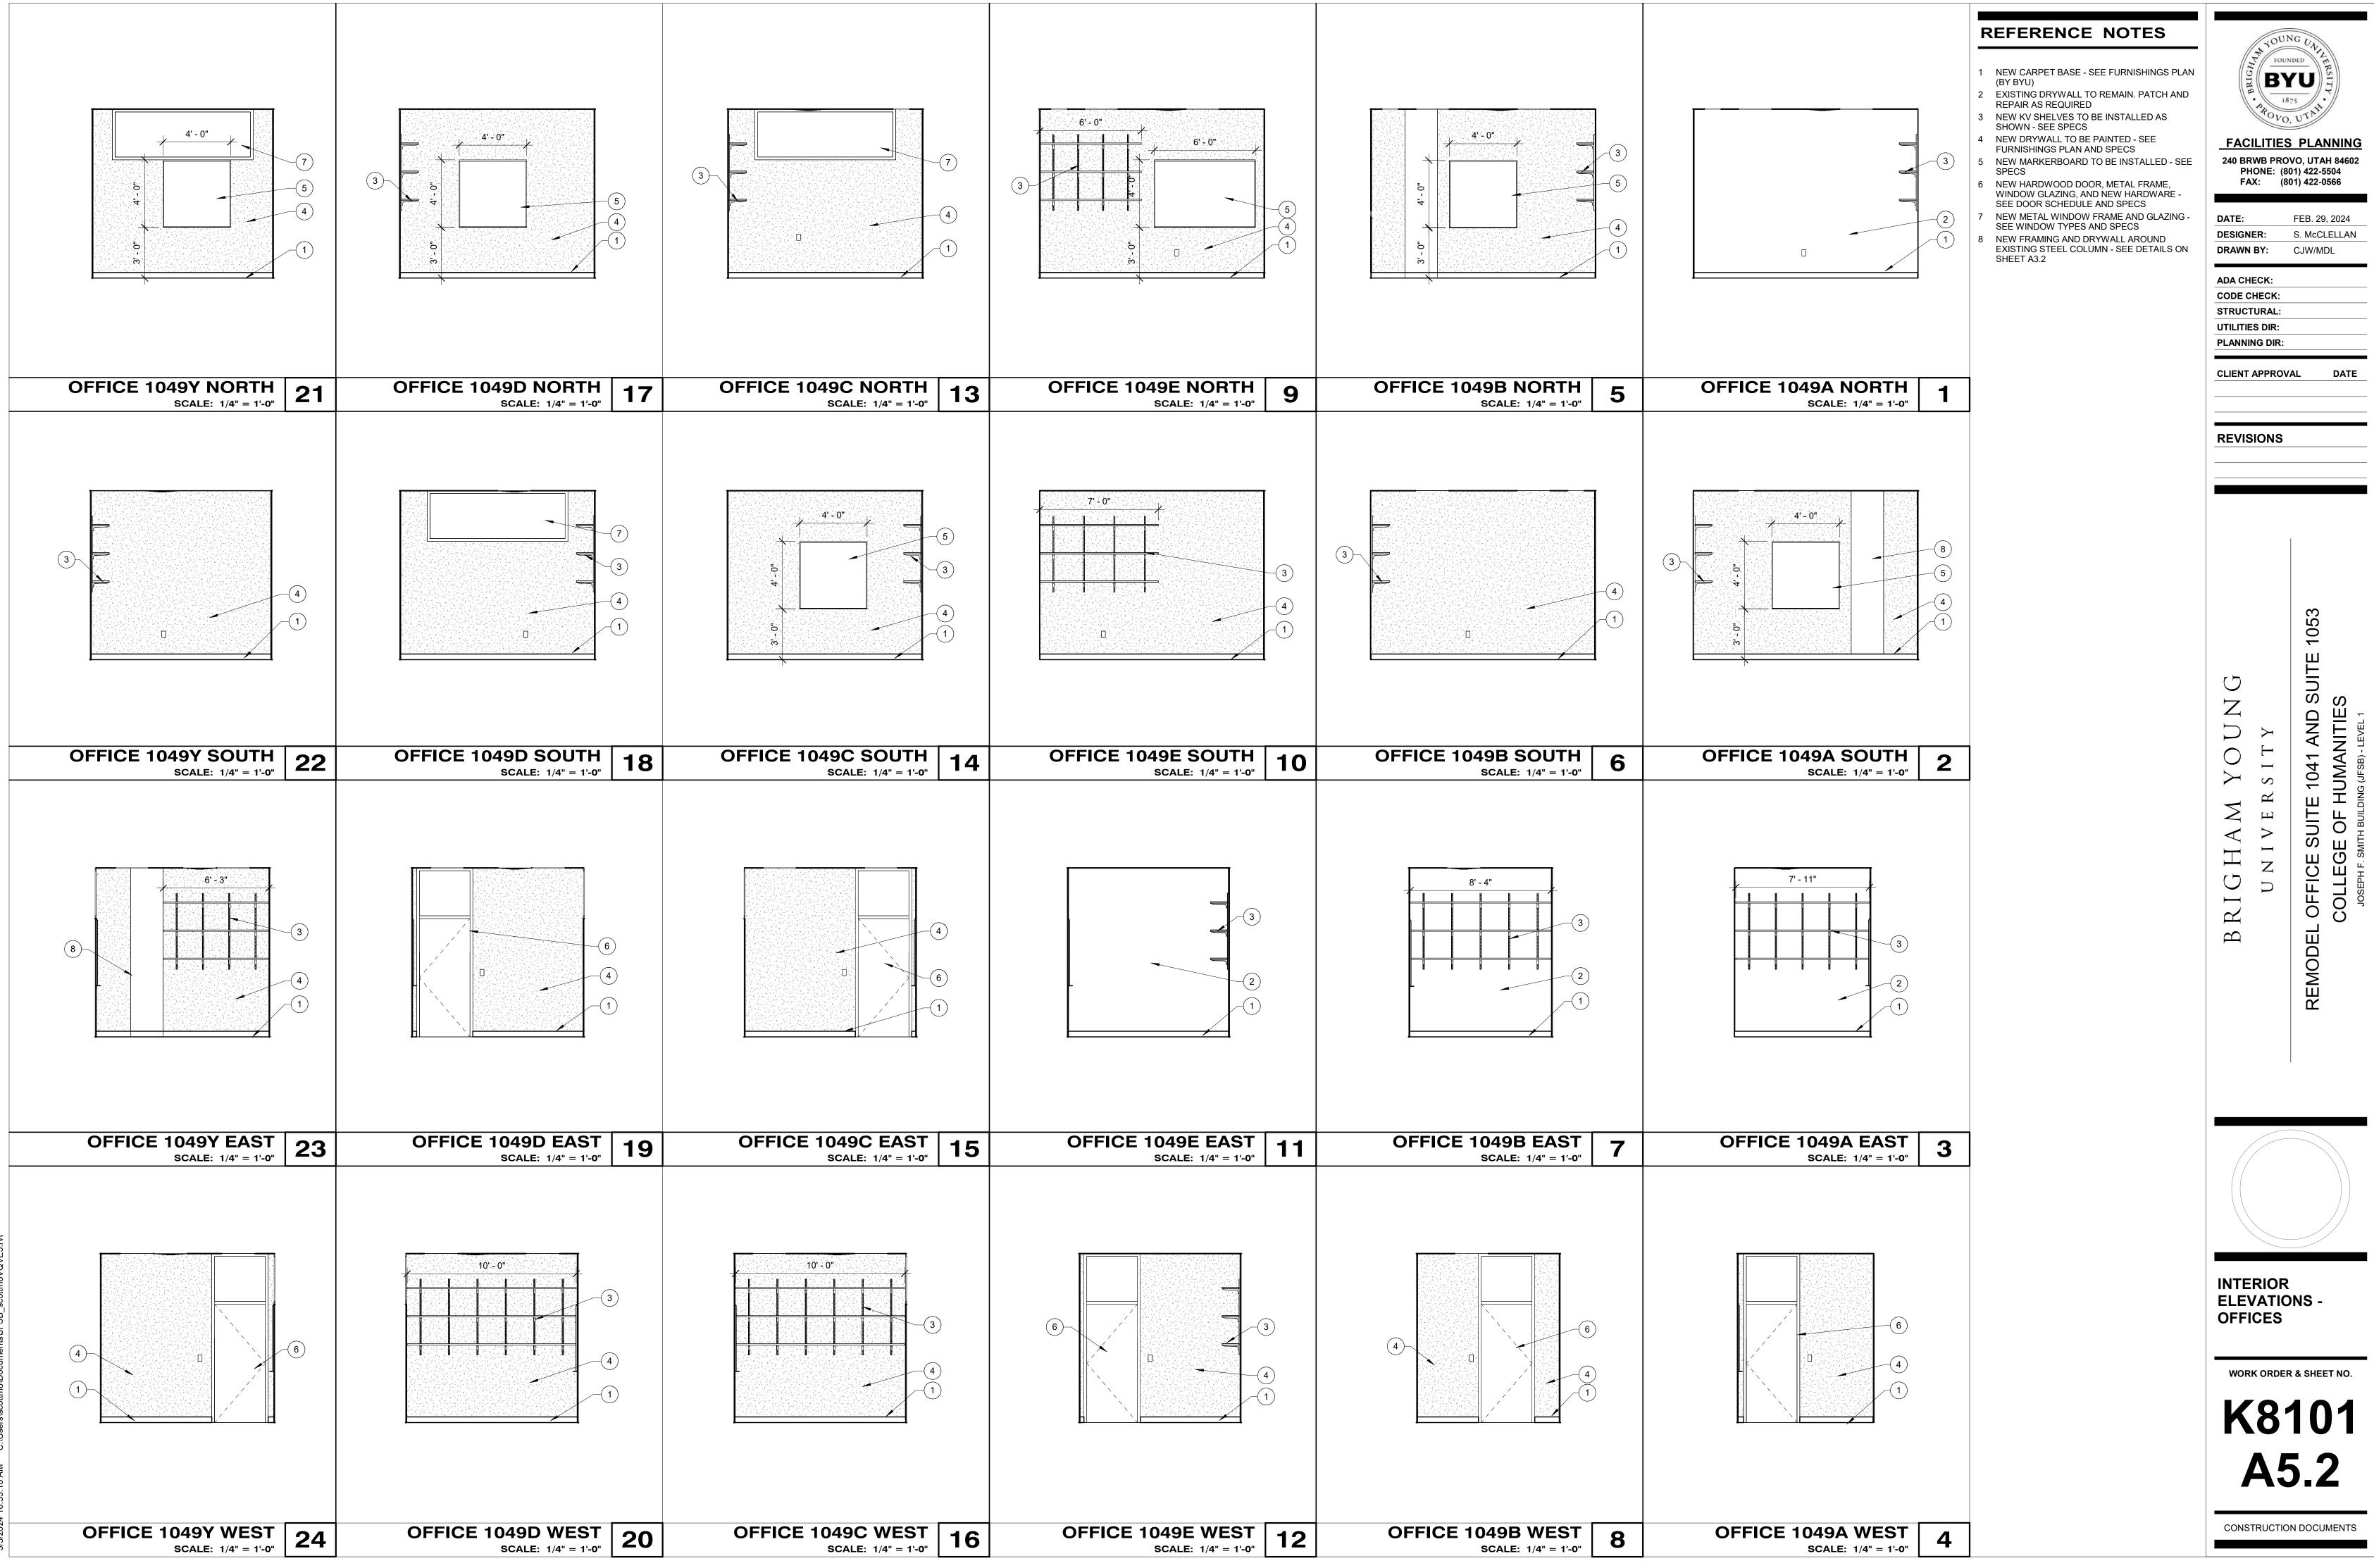


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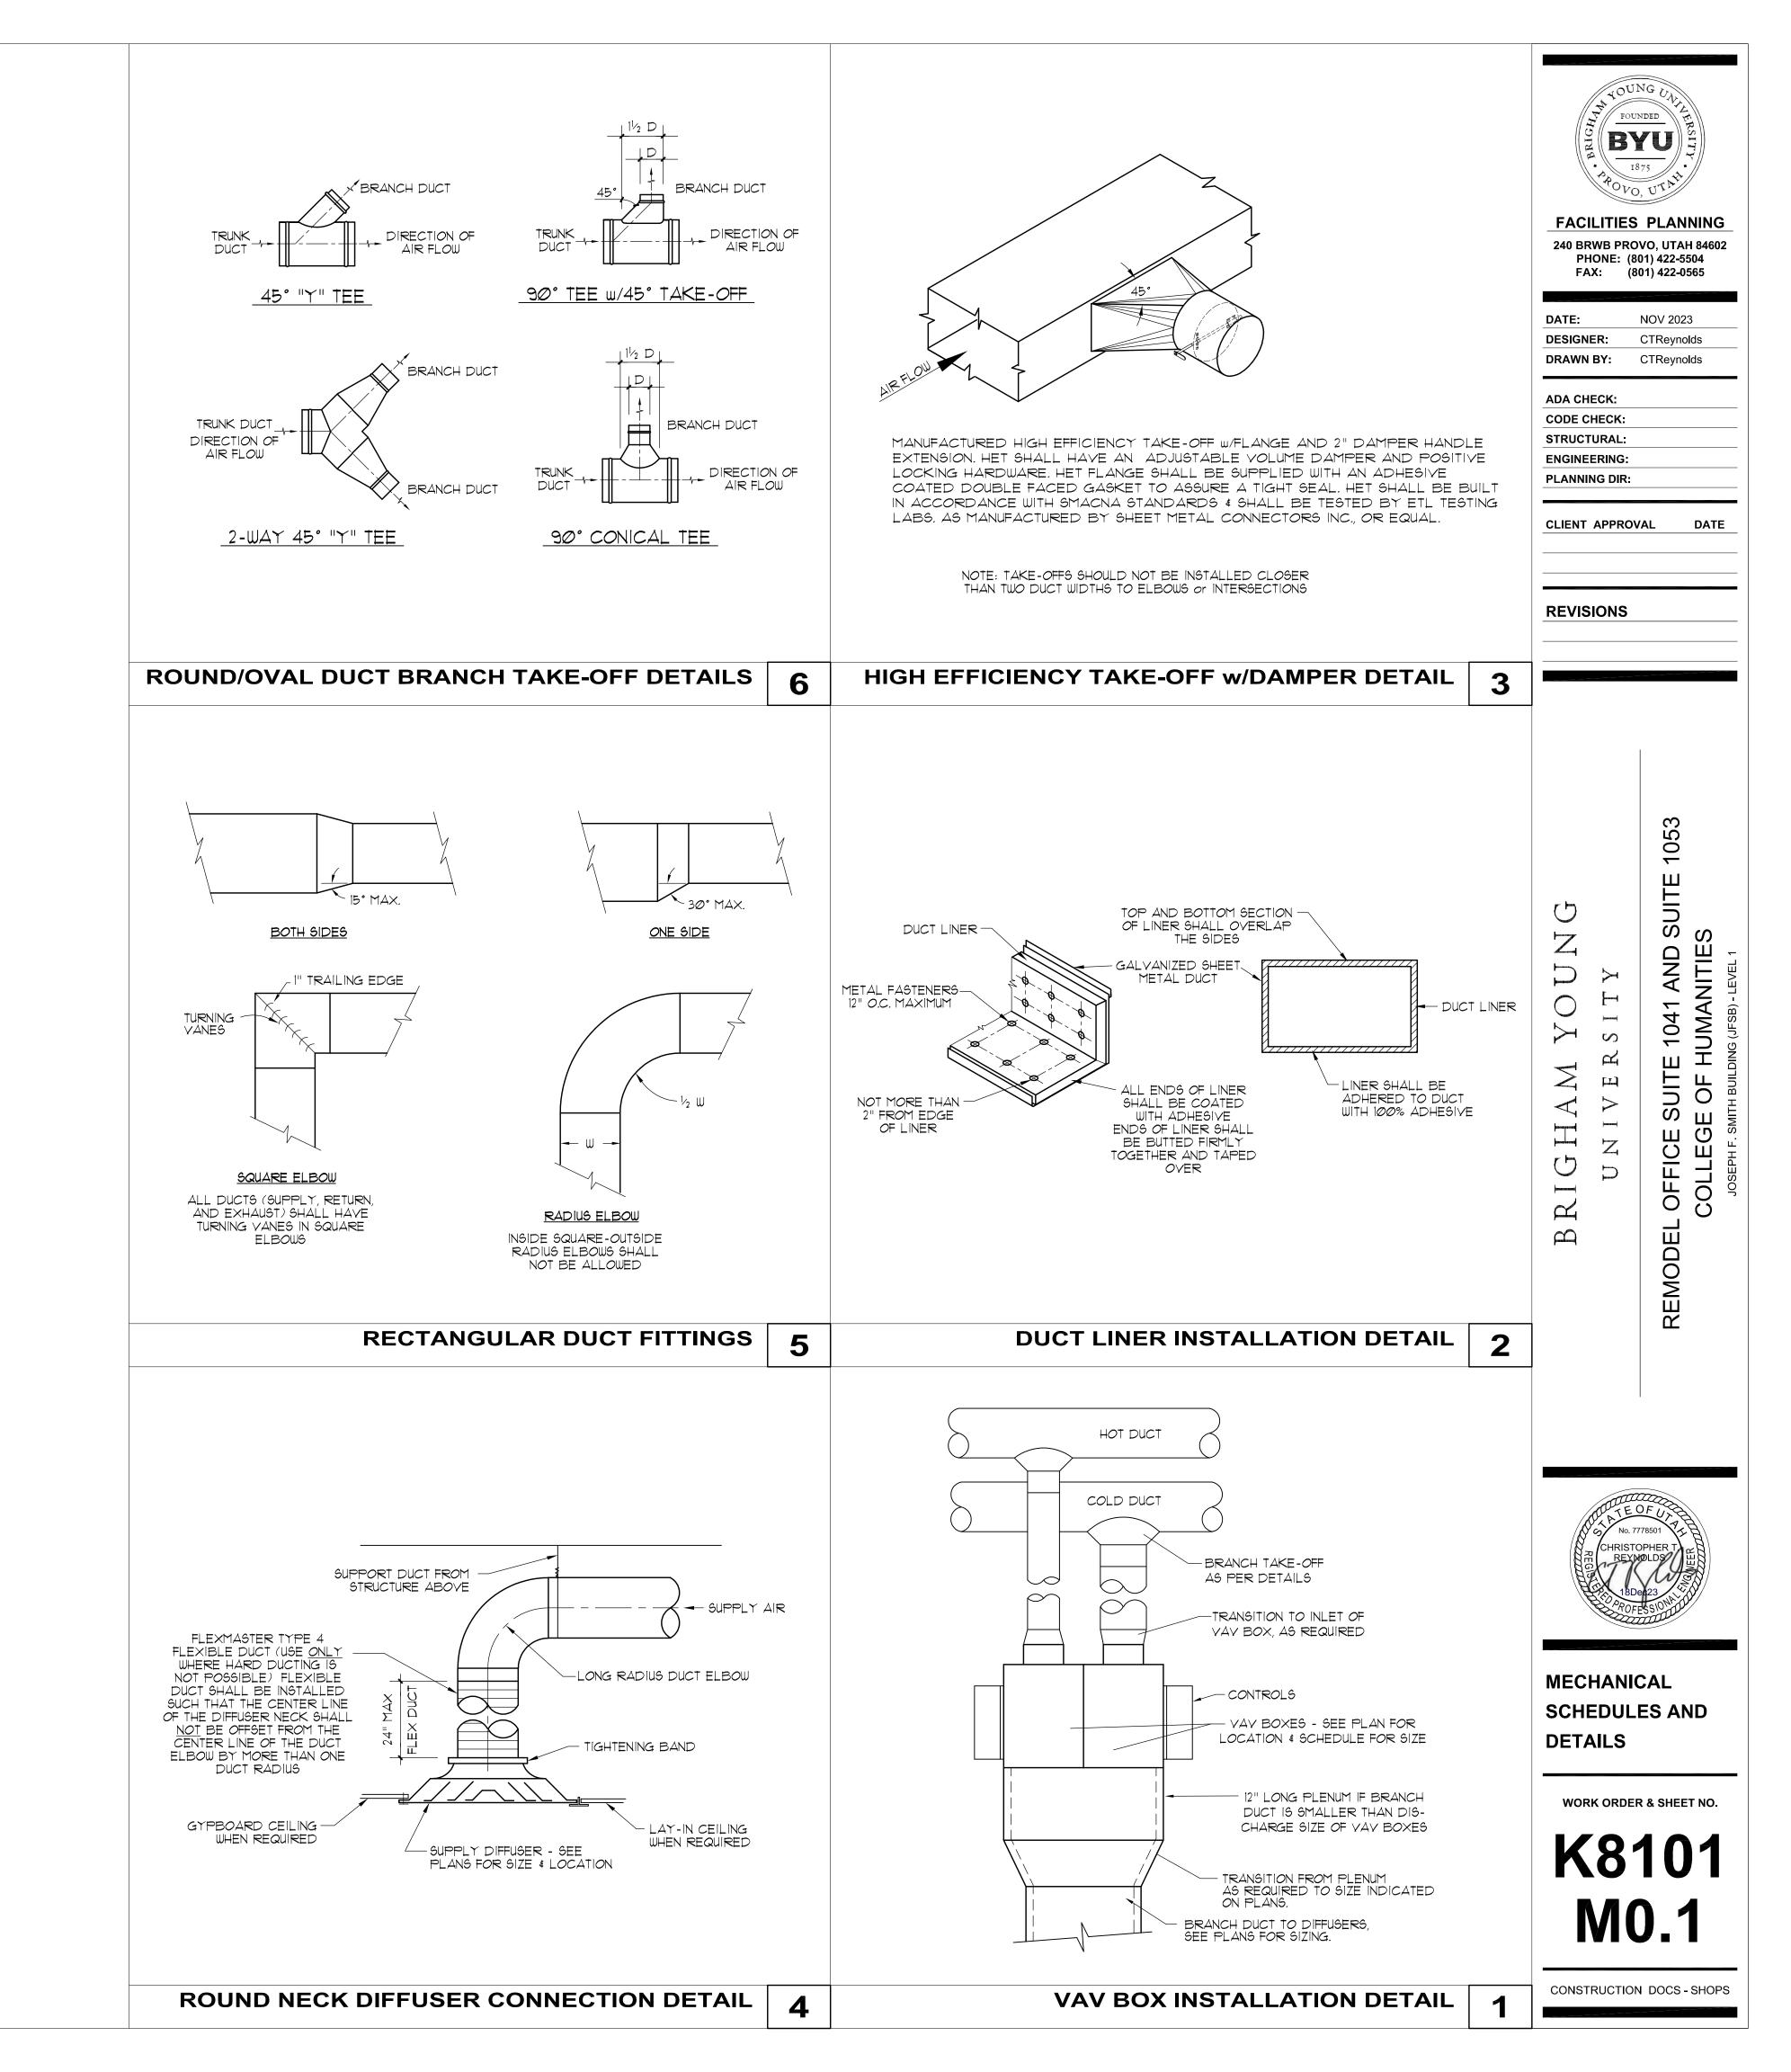
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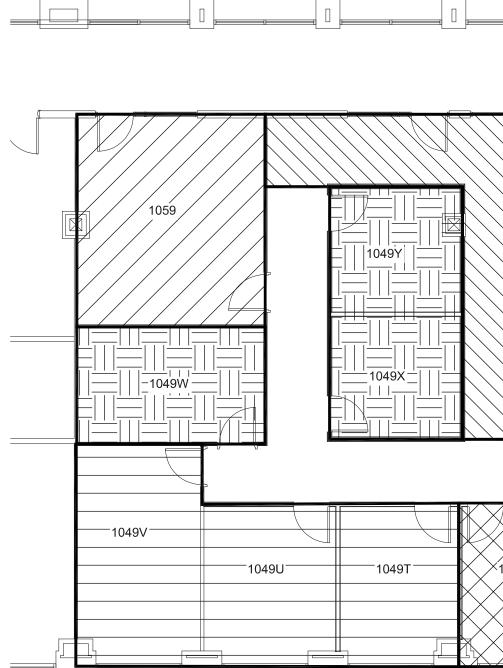


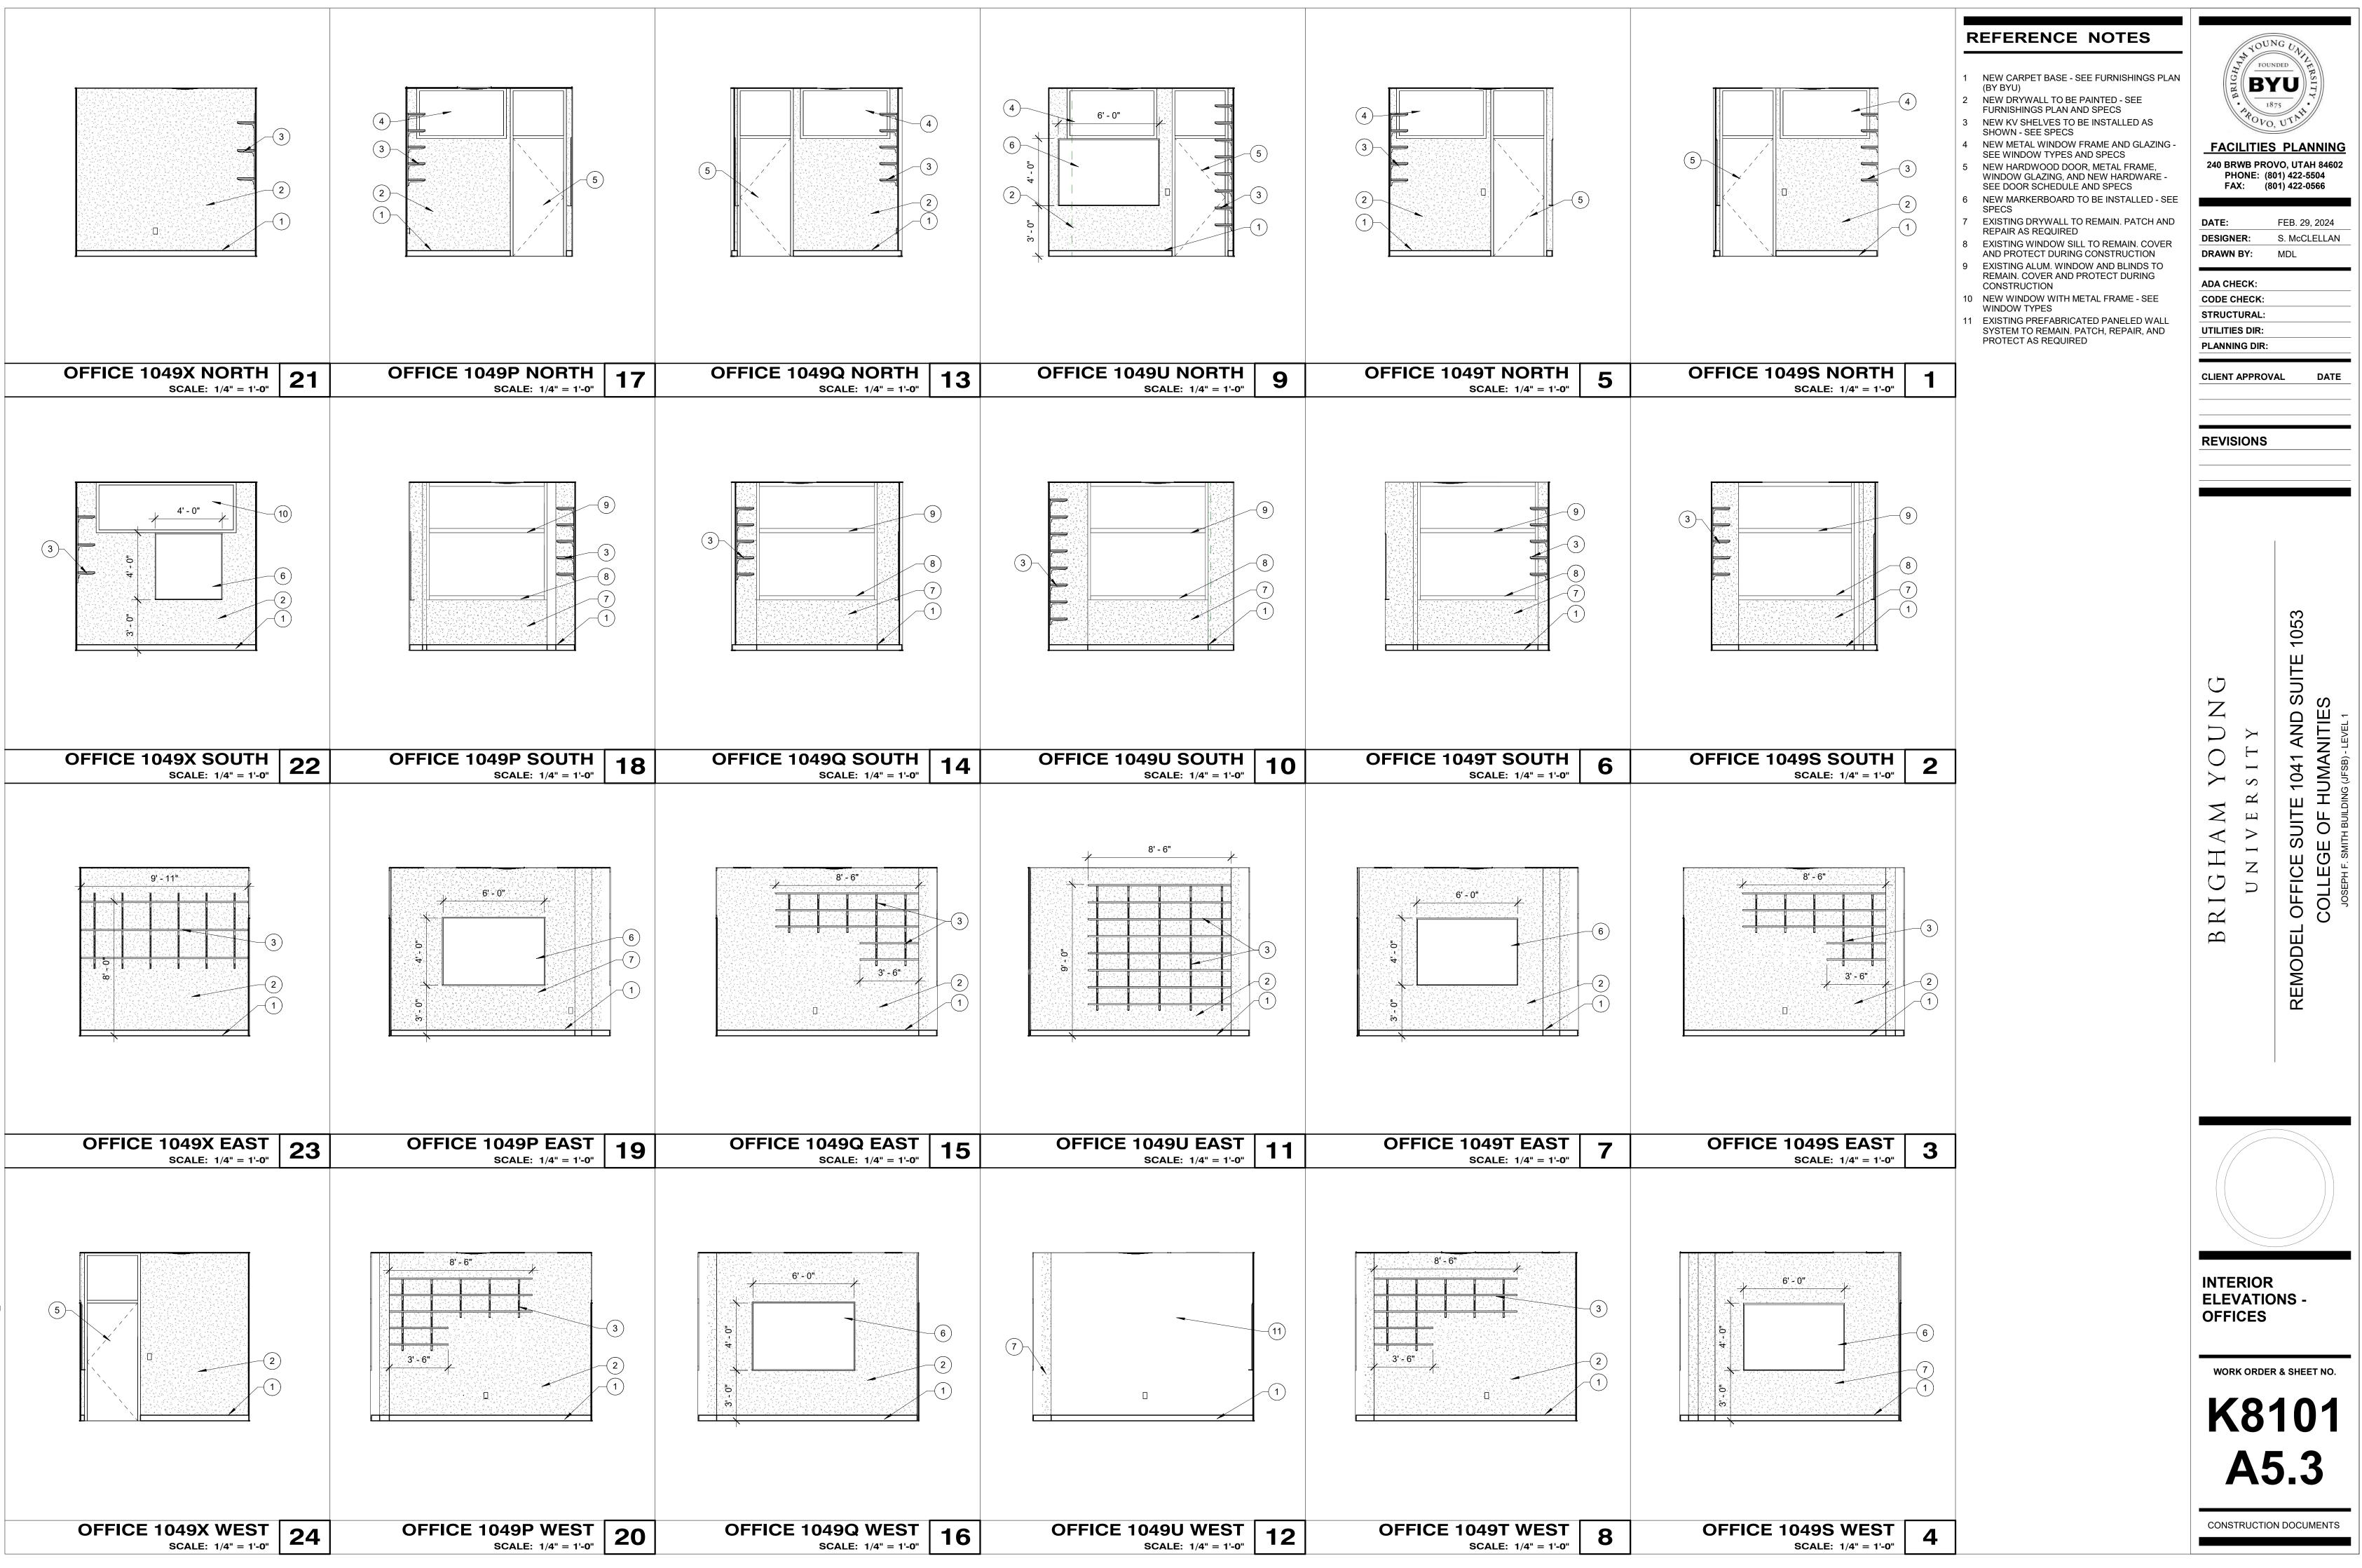


MECHANICAL EQUIPMENT SCHEDULE						
SYM	DESCRIPTION	MFG	CATALOG No.			
S1	SQUARE SUPPLY DIFFUSER 24" x 24" SQUARE PLAQUE FACE, FRAME TYPE 3 FOR LAY-IN CEILING, ALL STEEL CONSTRUCTION, WHITE FINISH NECK SIZE AND DIFFUSER LOCATION AS PER DRAWINGS	TITUS or KRUEGER or PRICE	OMNI PLQ SPD			
R1	RETURN AIR GRILLE 24" x 24" or 12" x 24" FACE, FRAME TYPE 3 FOR LAY-IN CEILING, ALL STEEL CONSTRUCTION, WHITE FINISH - NECK SIZE AND GRILLE LOCATION AS PER THIS DRAWING <u>SOUND BOOT</u> DUCTBOARD CAN WITH BAFFLE - 22"x22" or 10"x22" TO MATCH GRILLE	TITUS or PRICE HERCULES INDUSTRIES	PAR PFRF SB2222 or SB2210			
V1	VARIABLE AIR VOLUME VALVE DIGITAL CONTROL, MULTIPOINT CENTER AVERAGING INLET, INTERNAL INSULATION, SUPPLY <u>WITHOUT</u> A CONTROL ENCLOSURE BOX, SIZE AND LOCATION AS PER MECHANICAL DRAWINGS OR VAV SCHEDULE	TITUS or KRUEGER or PRICE	DESV LMHS SPV5000			

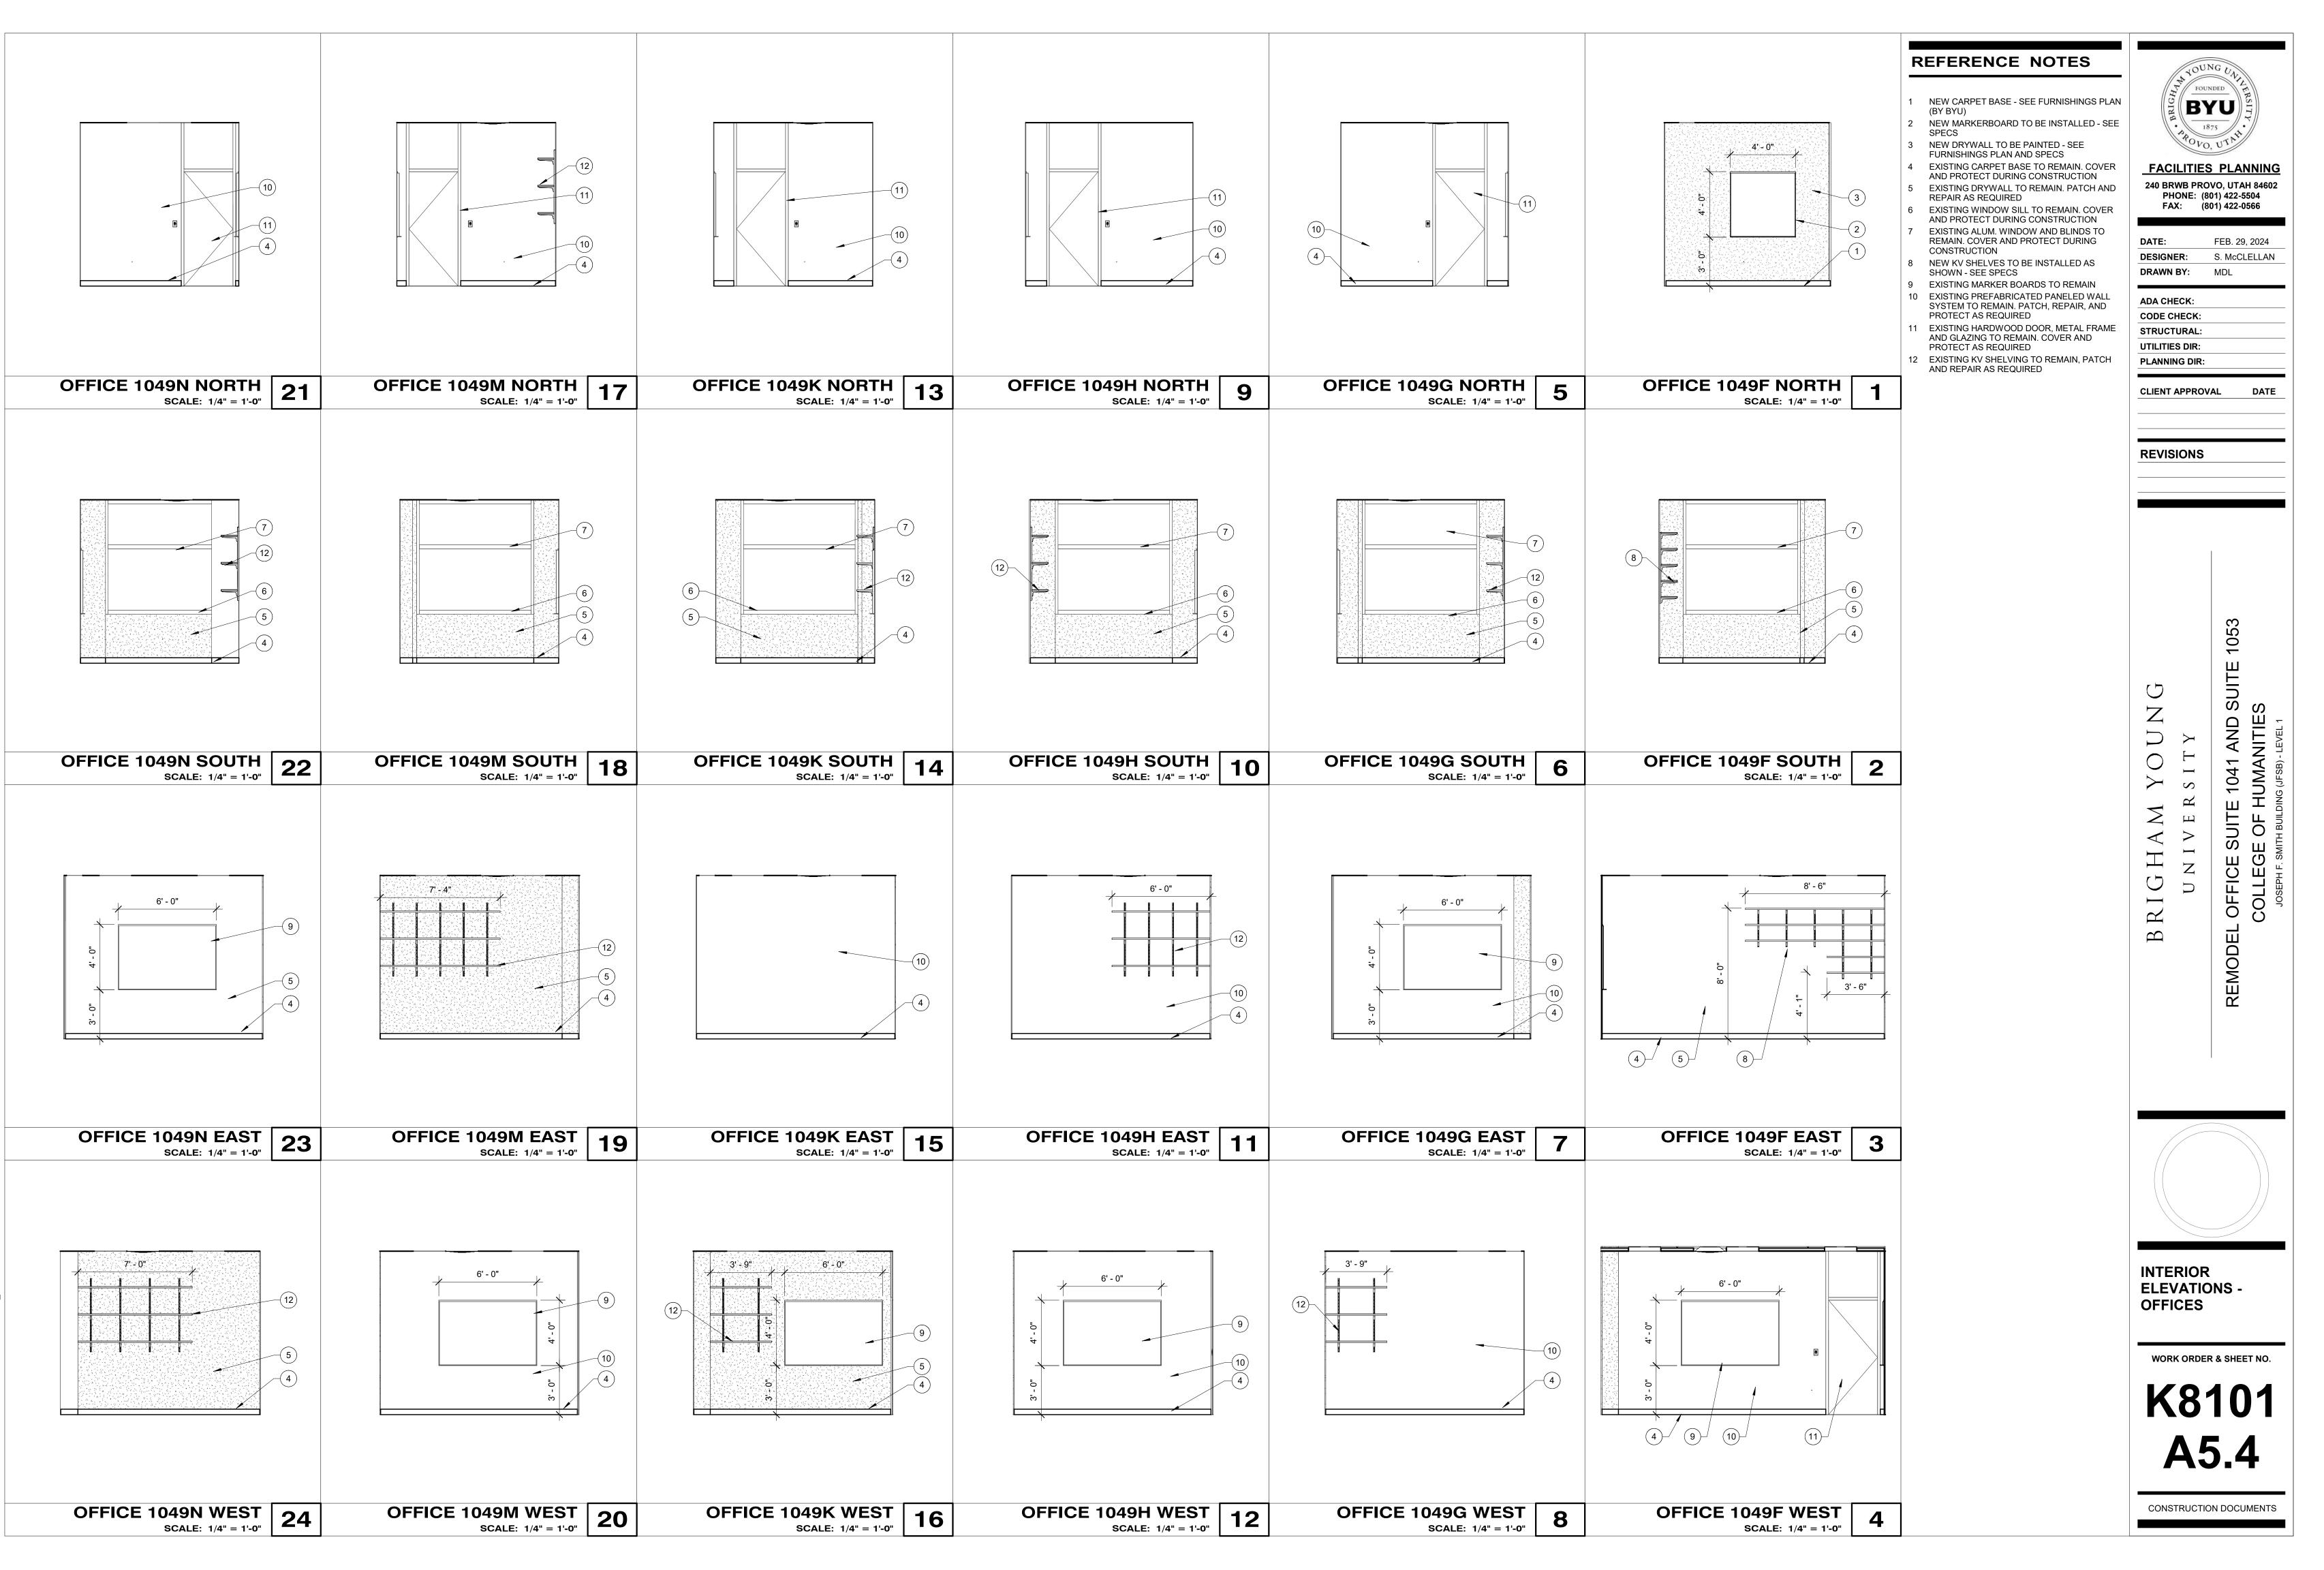
	\	/ARIABLE	AIR VOL	UME TERMINAL	BOX SC	HEDULE	
	ROOM		COOLING VAV BOX		HE		
NUMBER	TYPE	VAV TYPE	SIZE (IN)	MAX. COOLING AIRFLOW (CFM)	SIZE (IN)	MAX. HEATING AIRFLOW (CFM)	MIN. AIRFLOW (CFM)
1043 1049C 1049D	BREAK OFFICE OFFICE	DUAL	8	580	6	300	120
1045	CONFERENCE	COOL ONLY	10	650	-	-	180
1049 1049R	RECEPTION OPEN OFFICE	DUAL	12	1,100	8	660	250
1049A 1049B 1049E	OFFICE OFFICE OFFICE	DUAL	8	440	6	260	120
1049F 1049G 1049H	OFFICE OFFICE OFFICE	COOL ONLY	8	440	-	-	120
1049K 1049M 1049N	OFFICE OFFICE OFFICE	COOL ONLY	8	420	-	-	120
1049P 1049Q 1049S	OFFICE OFFICE OFFICE	COOL ONLY	8	420	-	-	120
1049T 1049U 1049V	OFFICE OFFICE OFFICE	COOL ONLY	8	440	-	-	120
1049W 1049X 1049Y	OFFICE OFFICE OFFICE	DUAL	8	420	6	260	120
1059	CONFERENCE	DUAL	8	450	6	260	120

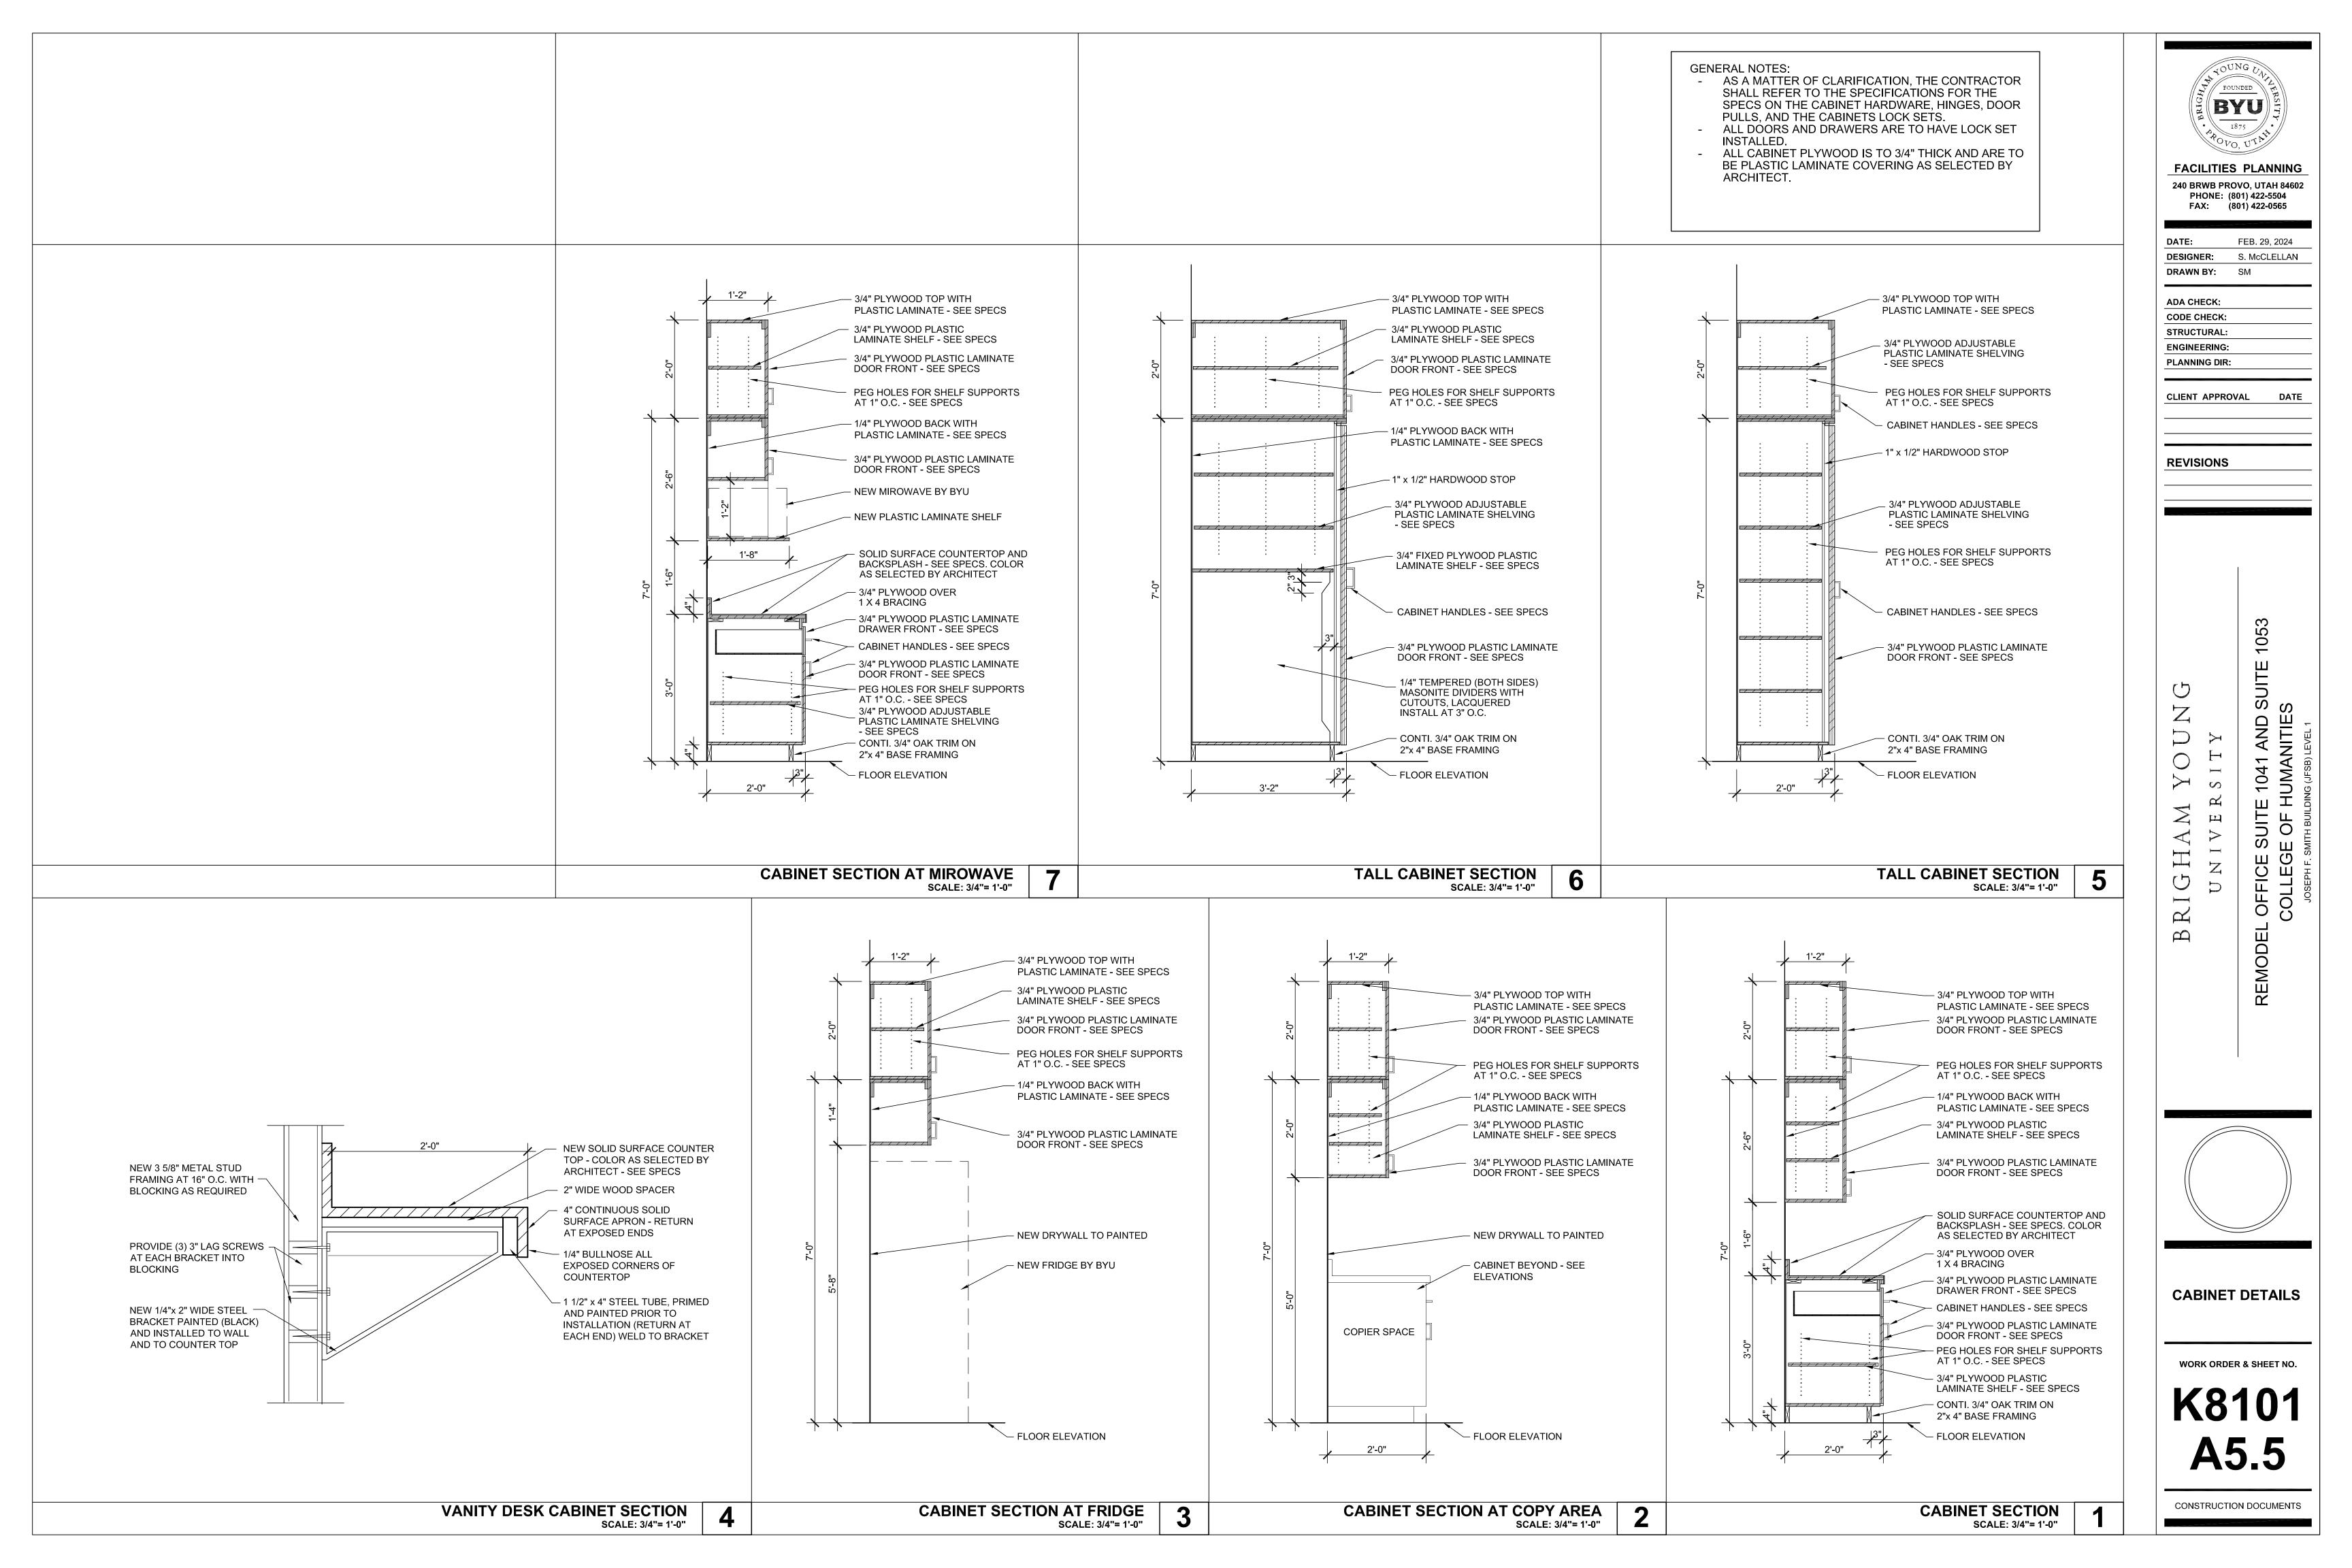




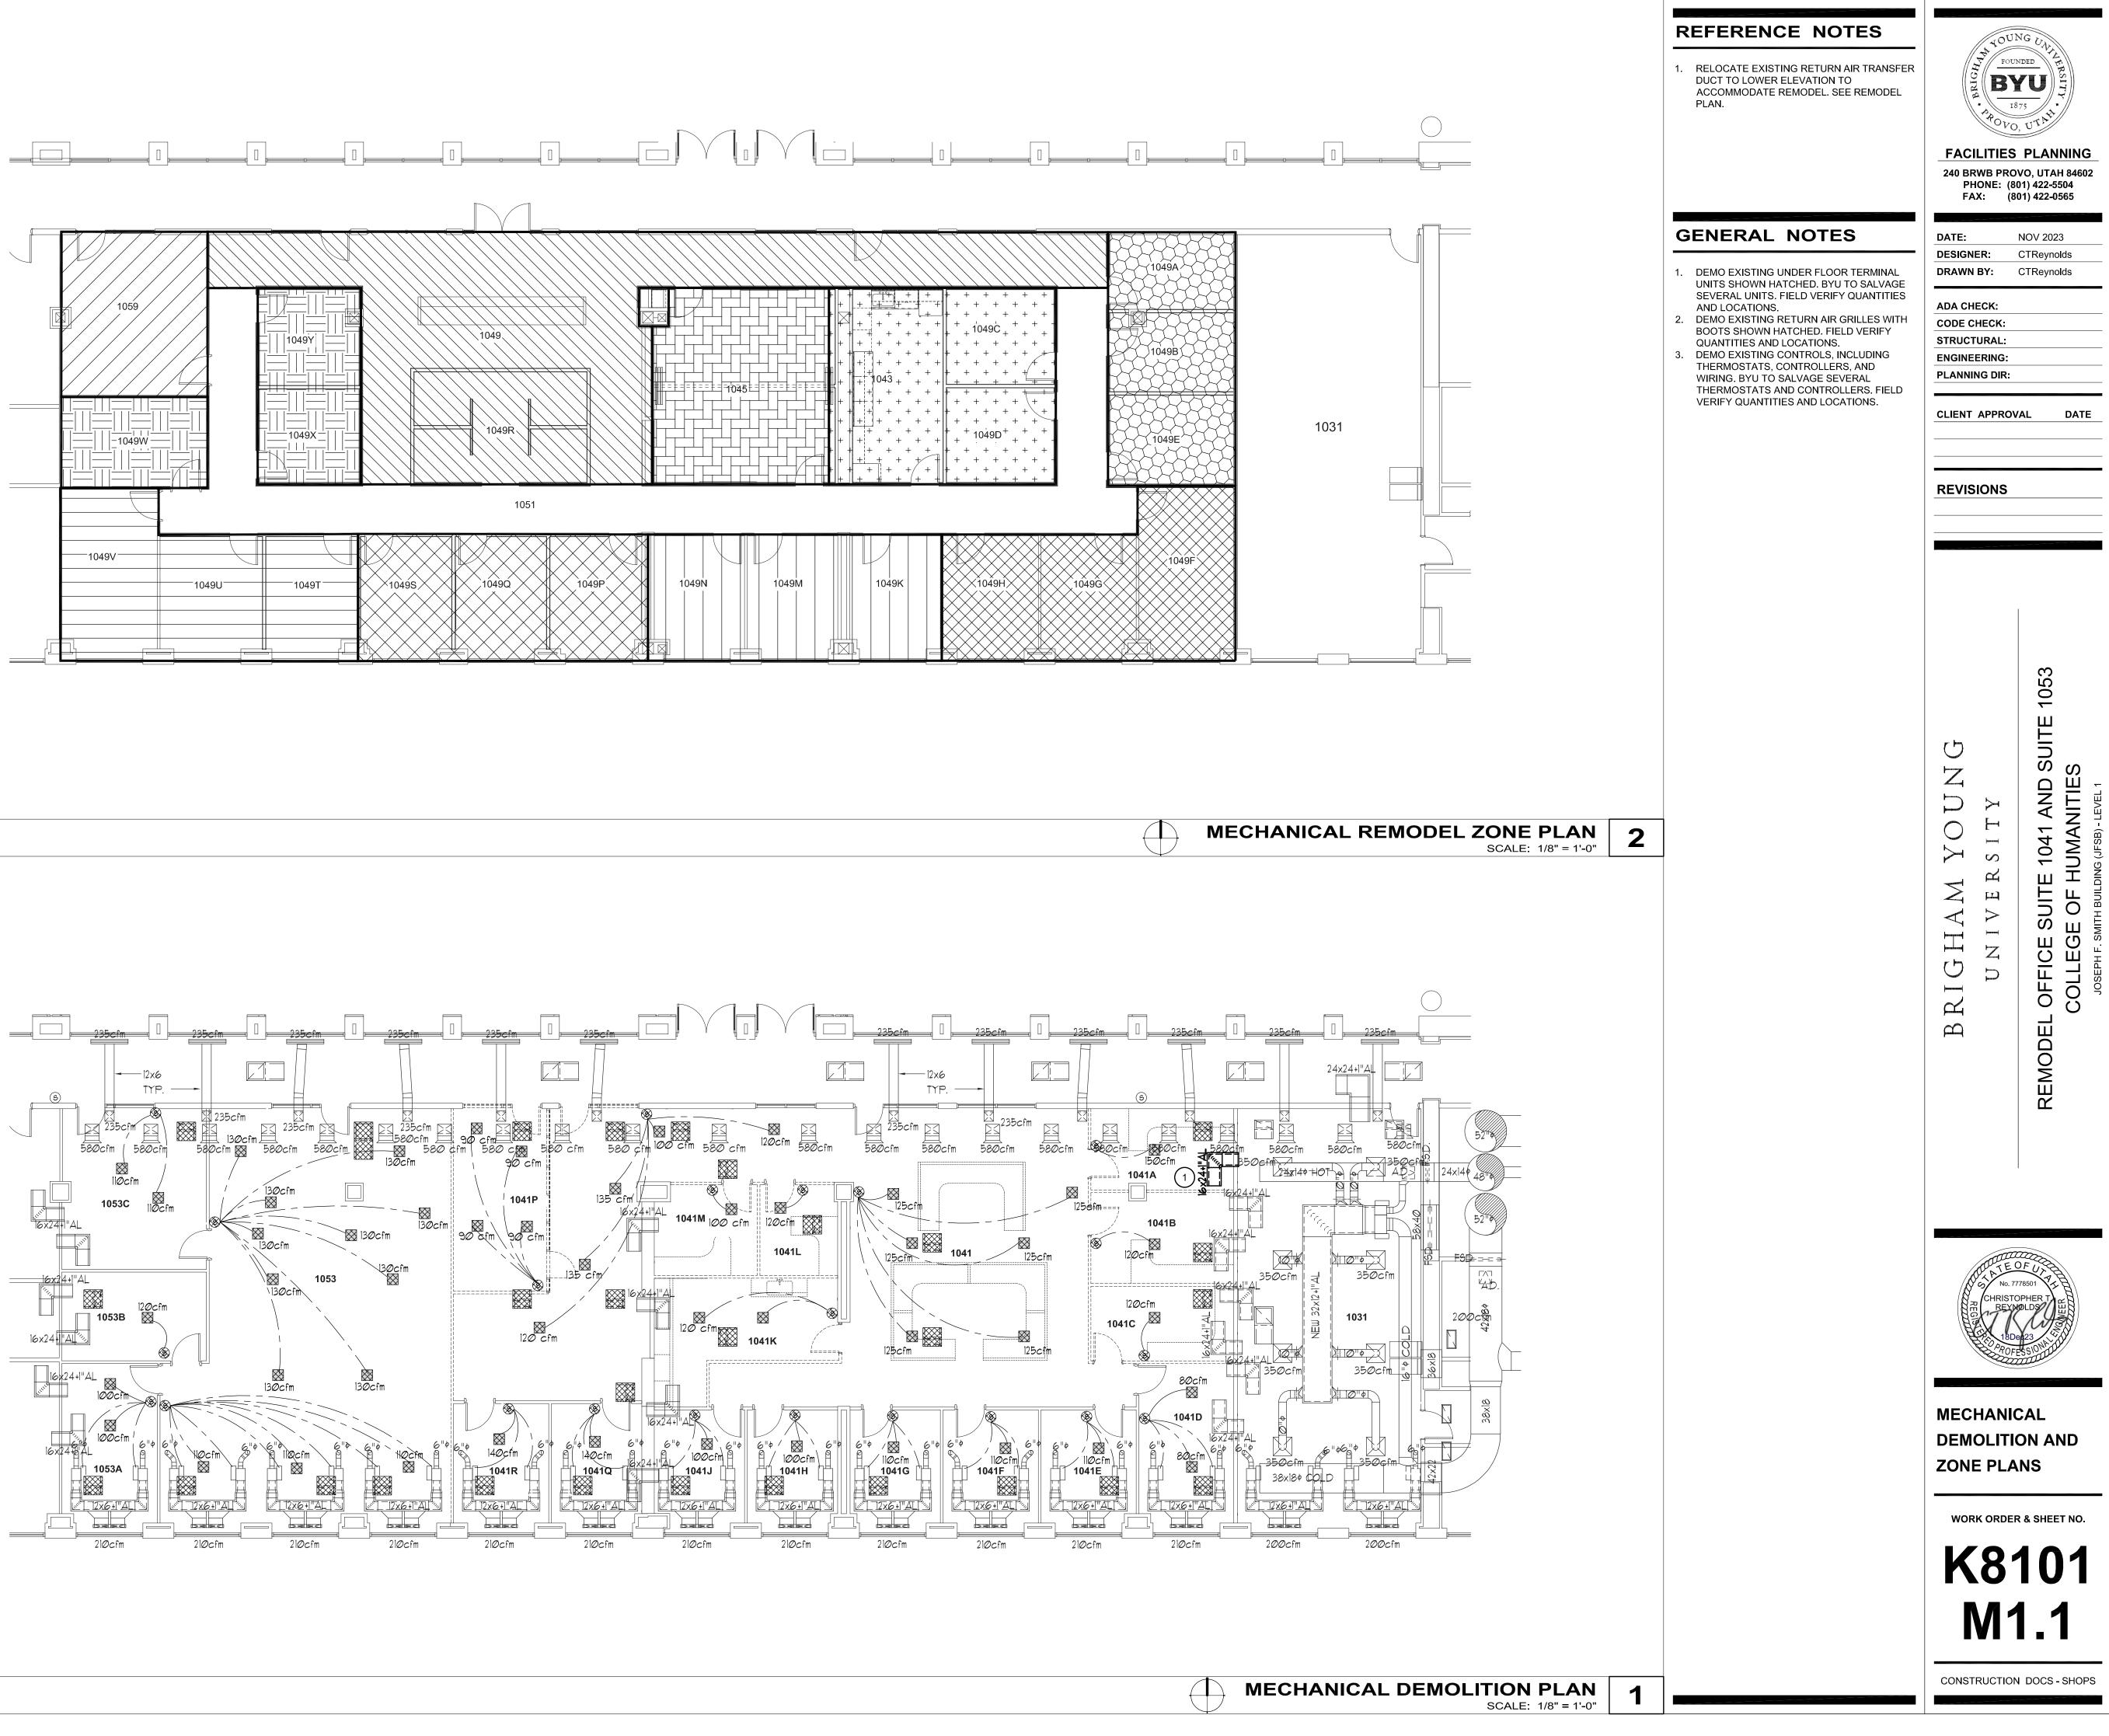


				1049A	
		$\begin{array}{c} \\ \\ \\ \\ \\ \\ \\ \\ \\ \\ \\ \\ \\ \\ \\ \\ \\ \\ \\$			
			$\begin{array}{c} + \\ + \\ + \\ + \\ + \\ + \\ + \\ + \\ + \\ + $		103 [,]
1051					
0495 1049Q 1049P	1049N 1	049M 1049K	1049H	1049G	

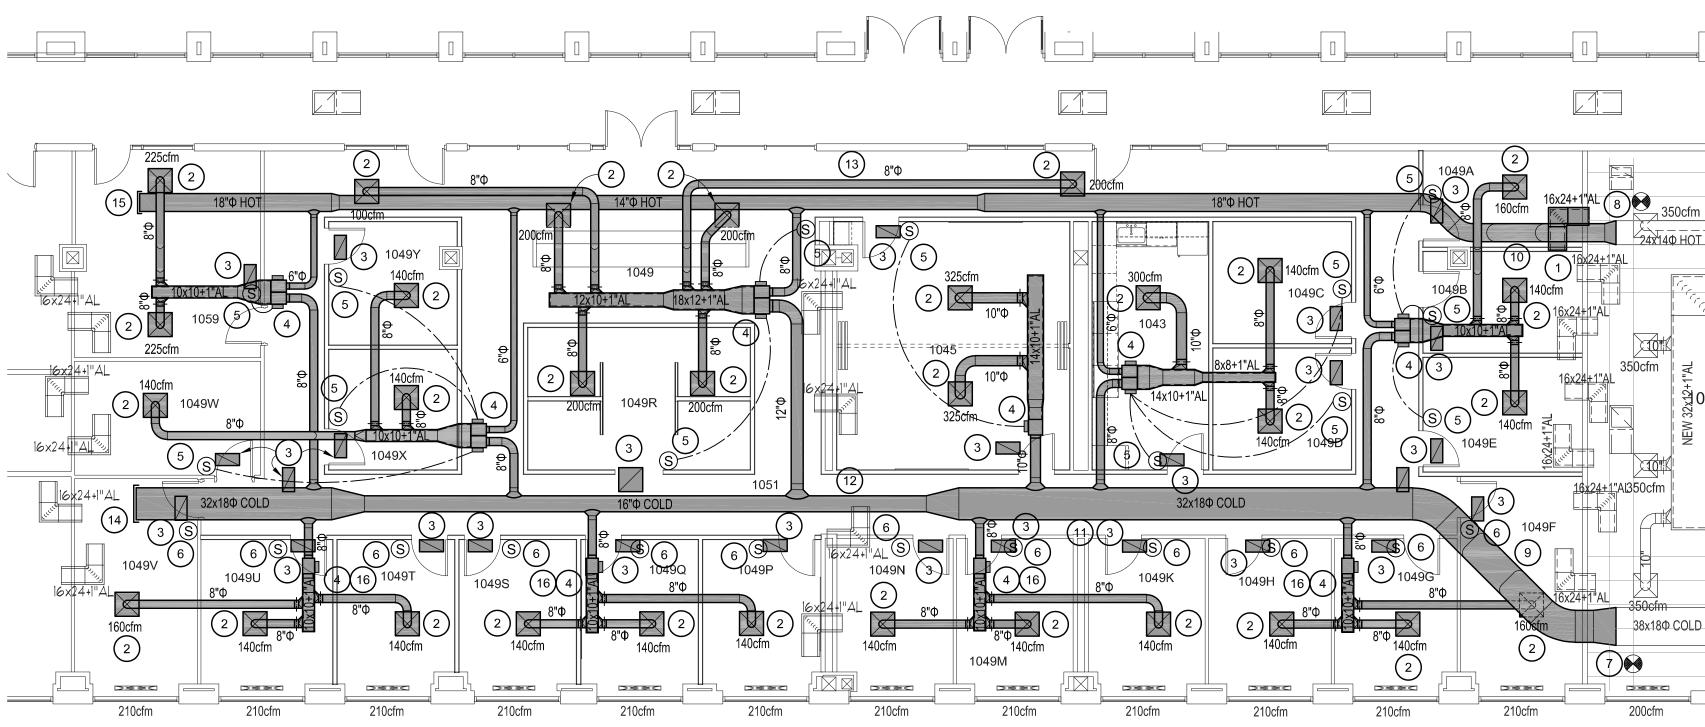

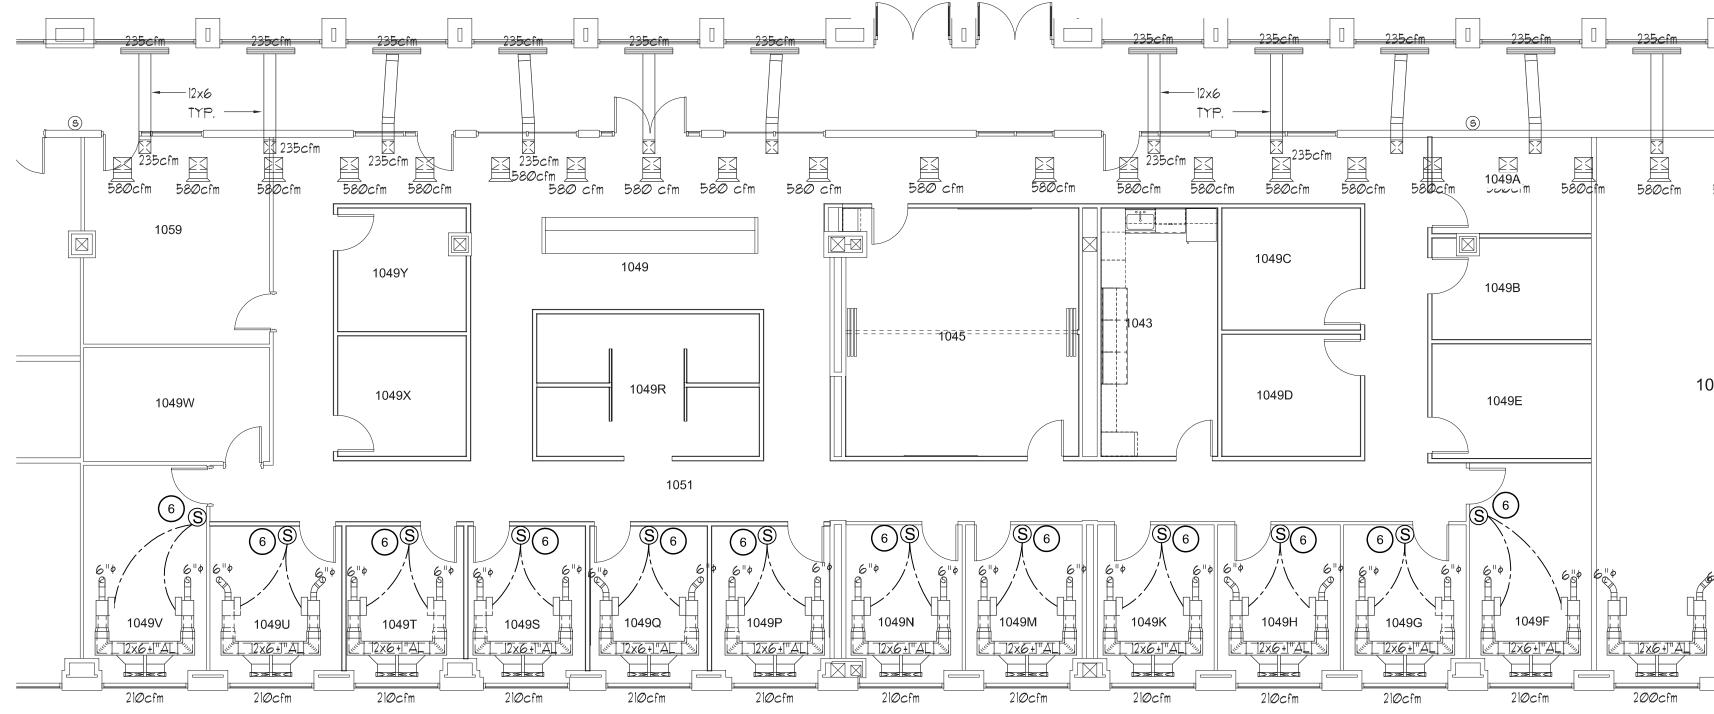

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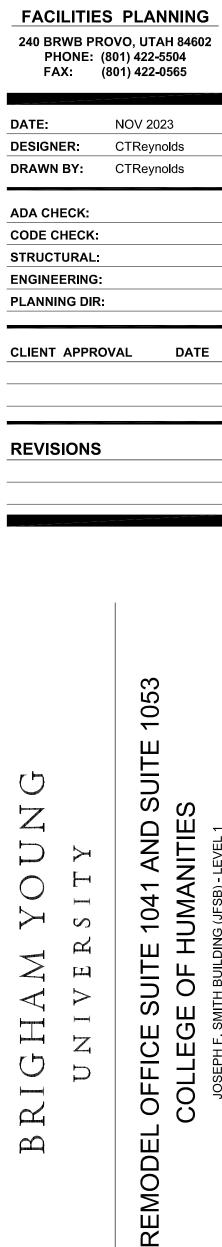
REFERENCE NOTES

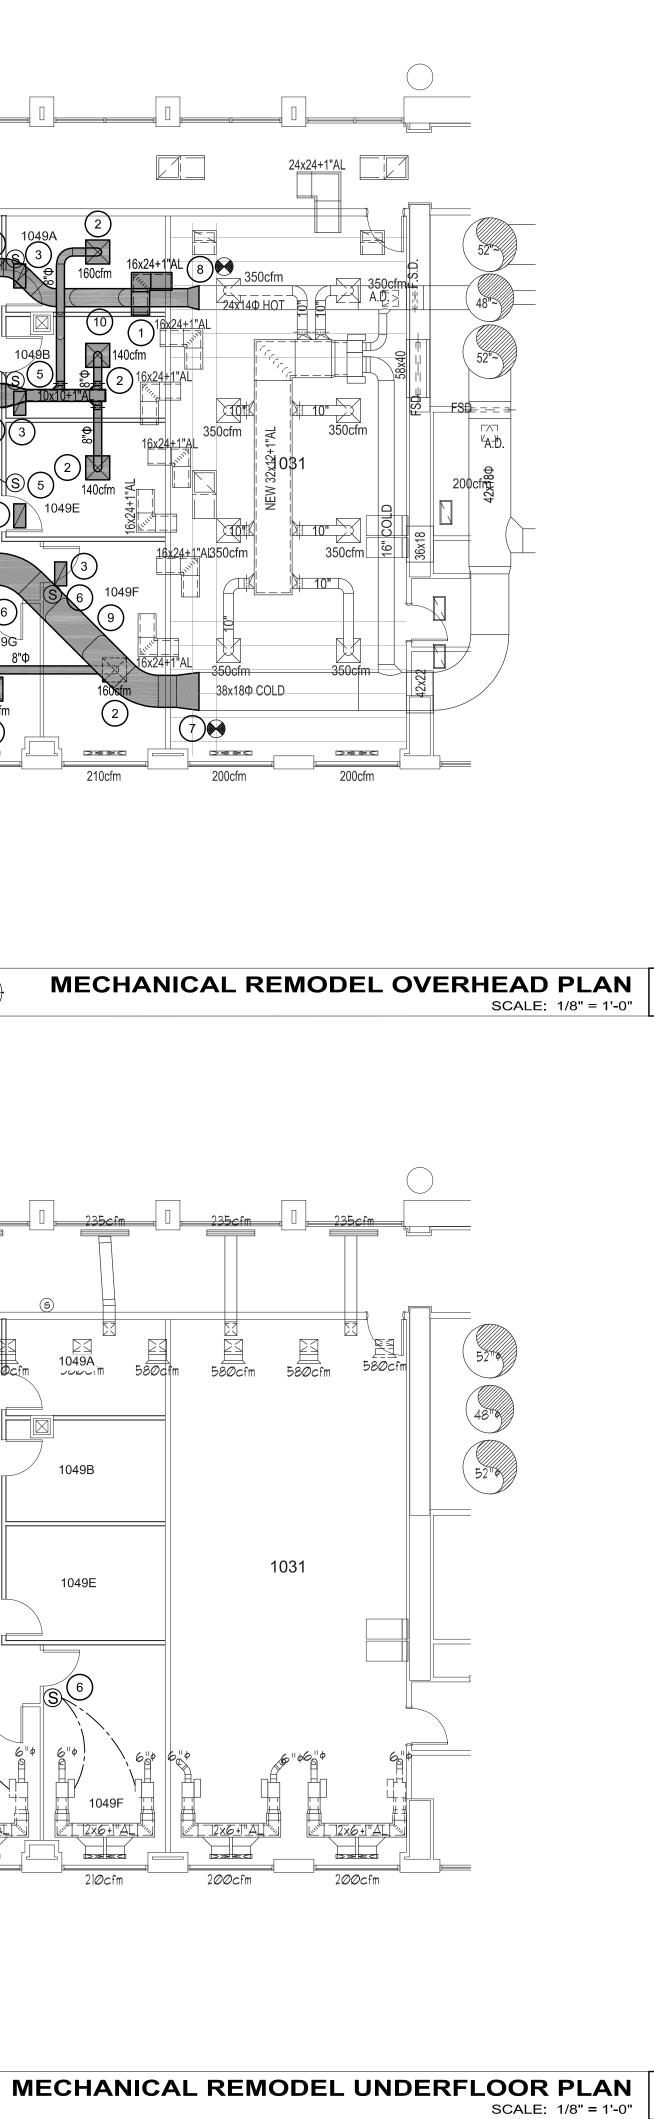- 1. RELOCATE EXISTING TRANSFER AIR DUCT TO LOWER ELEVATION TO ACCOMMODATE NEW HOT AIR DUCT ROUTING THROUGH WALL.
- 2. NEW SUPPLY DIFFUSER, S1. SEE MECHANICAL SCHEDULE. BALANCE TO CFM SHOWN ON PLANS.
- 3. NEW RETURN AIR GRILLE WITH SOUND BOOT, R1. SEE MECHANICAL SCHEDULE.
- 4. NEW VAV BOX(ES), V1. SEE MECHANICAL
- SCHEDULE. 5. NEW DELTA AVERAGING THERMOSTAT,
- CONTROLS, AND WIRING. 6. NEW DELTA THERMOSTAT, CONTROLS, AND
- WIRING CONNECTED TO EXISTING UNDER FLOOR DUAL DUCT VAV BOXES. 7. CONNECT TO EXISTING 38"x18" OVAL COLD
- DUCT (FIELD VERIFY DIMENSIONS) AND REDUCE TO 32"x18" OVAL DUCT. 8. CONNECT TO EXISTING 24"x14" OVAL HOT
- DUCT (FIELD VERIFY DIMENSIONS) AND REDUCE TO 18" ROUND DUCT. 9. OFFSET 32"x18" OVAL DUCT DOWN TO APPROXIMATELY 3'-0" ABOVE FINISH
- CEILING, BELOW EXISTING ROOF DRAINS IN CEILING SPACE. 10. ROUTE 18" ROUND DUCT ABOVE RELOCATED
- TRANSFER AIR DUCT, THEN OFFSET DOWN TO APPROXIMATELY 3'-0" ABOVE FINISH CEILING, BELOW EXISTING ROOF DRAINS IN CEILING SPACE.
- 11. ROUTE 32"X18" OVAL DUCT THROUGH EXISTING OPENING IN WALL.
- 12. ROUTE 16" ROUND DUCT THROUGH EXISTING WALL. PATCH AND SEAL AROUND PENETRATION.
- 13. ROUTE NEW DUCTS THROUGH EXISTING WALL. PATCH AND SEAL AROUND PENETRATION.
- 14. EXTEND 32"X18" OVAL DUCT TO WITHIN 5'-0" OF EXISTING WALL. CAP DUCT FOR FUTURE CONNECTION TO EXISTING SYSTEM.
- 15. EXTEND 18" ROUND DUCT TO WITHIN 5'-0" OF EXISTING WALL. CAP DUCT FOR FUTURE CONNECTION TO EXISTING SYSTEM.
- 16. PROGRAM THE COOLING ONLY VAV BOXES FOR EXTERIOR OFFICES TO MODULATE BASED ON THE MINIMUM COOLING DEMAND FOR THE 3 OFFICES FED, PROVIDING "BASE" COOLING FOR ALL OFFICES. THE UNDER FLOOR VAV BOXES SHALL PROVIDE ALL HEATING AND ANY NECESSARY "TRIM" COOLING FOR EACH INDIVIDUAL OFFICE. A SINGLE CONTROLLER WITH AT LEAST 4 ANALOG OUTPUTS SHALL CONTROL ALL 4 VAV BOXES FOR EXTERIOR OFFICES.



2

- 1. INSULATE ALL NEW OR REPAIRED AND UNLINED SUPPLY AIR DUCTWORK WITH 1" THICK FIBERGLASS INSULATION W/ALUMINUM FOIL SCRIM KRAFT FACING AND
- A DENSITY OF 1-1/2 lb/ft³. 2. LAY OUT ALL DUCTWORK SUCH THAT DUCT RUN-OUTS or DROPS TO DIFFUSERS ARE ALIGNED TO AVOID UNNECESSARY OFFSETS. USE FLEXIBLE DUCT ONLY WHERE HARD DUCTING IS NOT POSSIBLE. FLEXIBLE DUCT SHALL BE INSTALLED SUCH THAT THE CENTER LINE OF THE DIFFUSER NECK SHALL NOT BE OFFSET FROM THE CENTER LINE OF THE DUCT ELBOW BY MORE THAN ONE DUCT RADIUS. NO MORE THAN 24" MAXIMUM LENGTH OF FLEX DUCT AND NO FLEX DUCT ELBOWS ALLOWED.
- 3. THE JOINTS AND SEAMS OF ALL SUPPLY AIR DUCTWORK SHALL BE SEALED. MASTIC SEALING COMPOUND SHALL BE DURODYNE S-2, 3M EC-750, IRON GRIP 601 or
- HARDCAST TWO-PART SYSTEM II. AIR BALANCE ALL DIFFUSERS AND VAV 4. BOXES TO AIR VOLUMES NOTED IN
- SCHEDULE OR ON PLANS. REFER TO THE ARCHITECTURAL REFLECTED 5 CEILING PLANS FOR THE EXACT LOCATION OF ALL DIFFUSERS, GRILLES, FIRE
- SPRINKLERS, etc. 6. COORDINATE ALL DUCT ELEVATIONS WITH EXISTING DUCTWORK, FIRE SPRINKLER PIPING, AND ROOF DRAINS IN CEILING SPACE.



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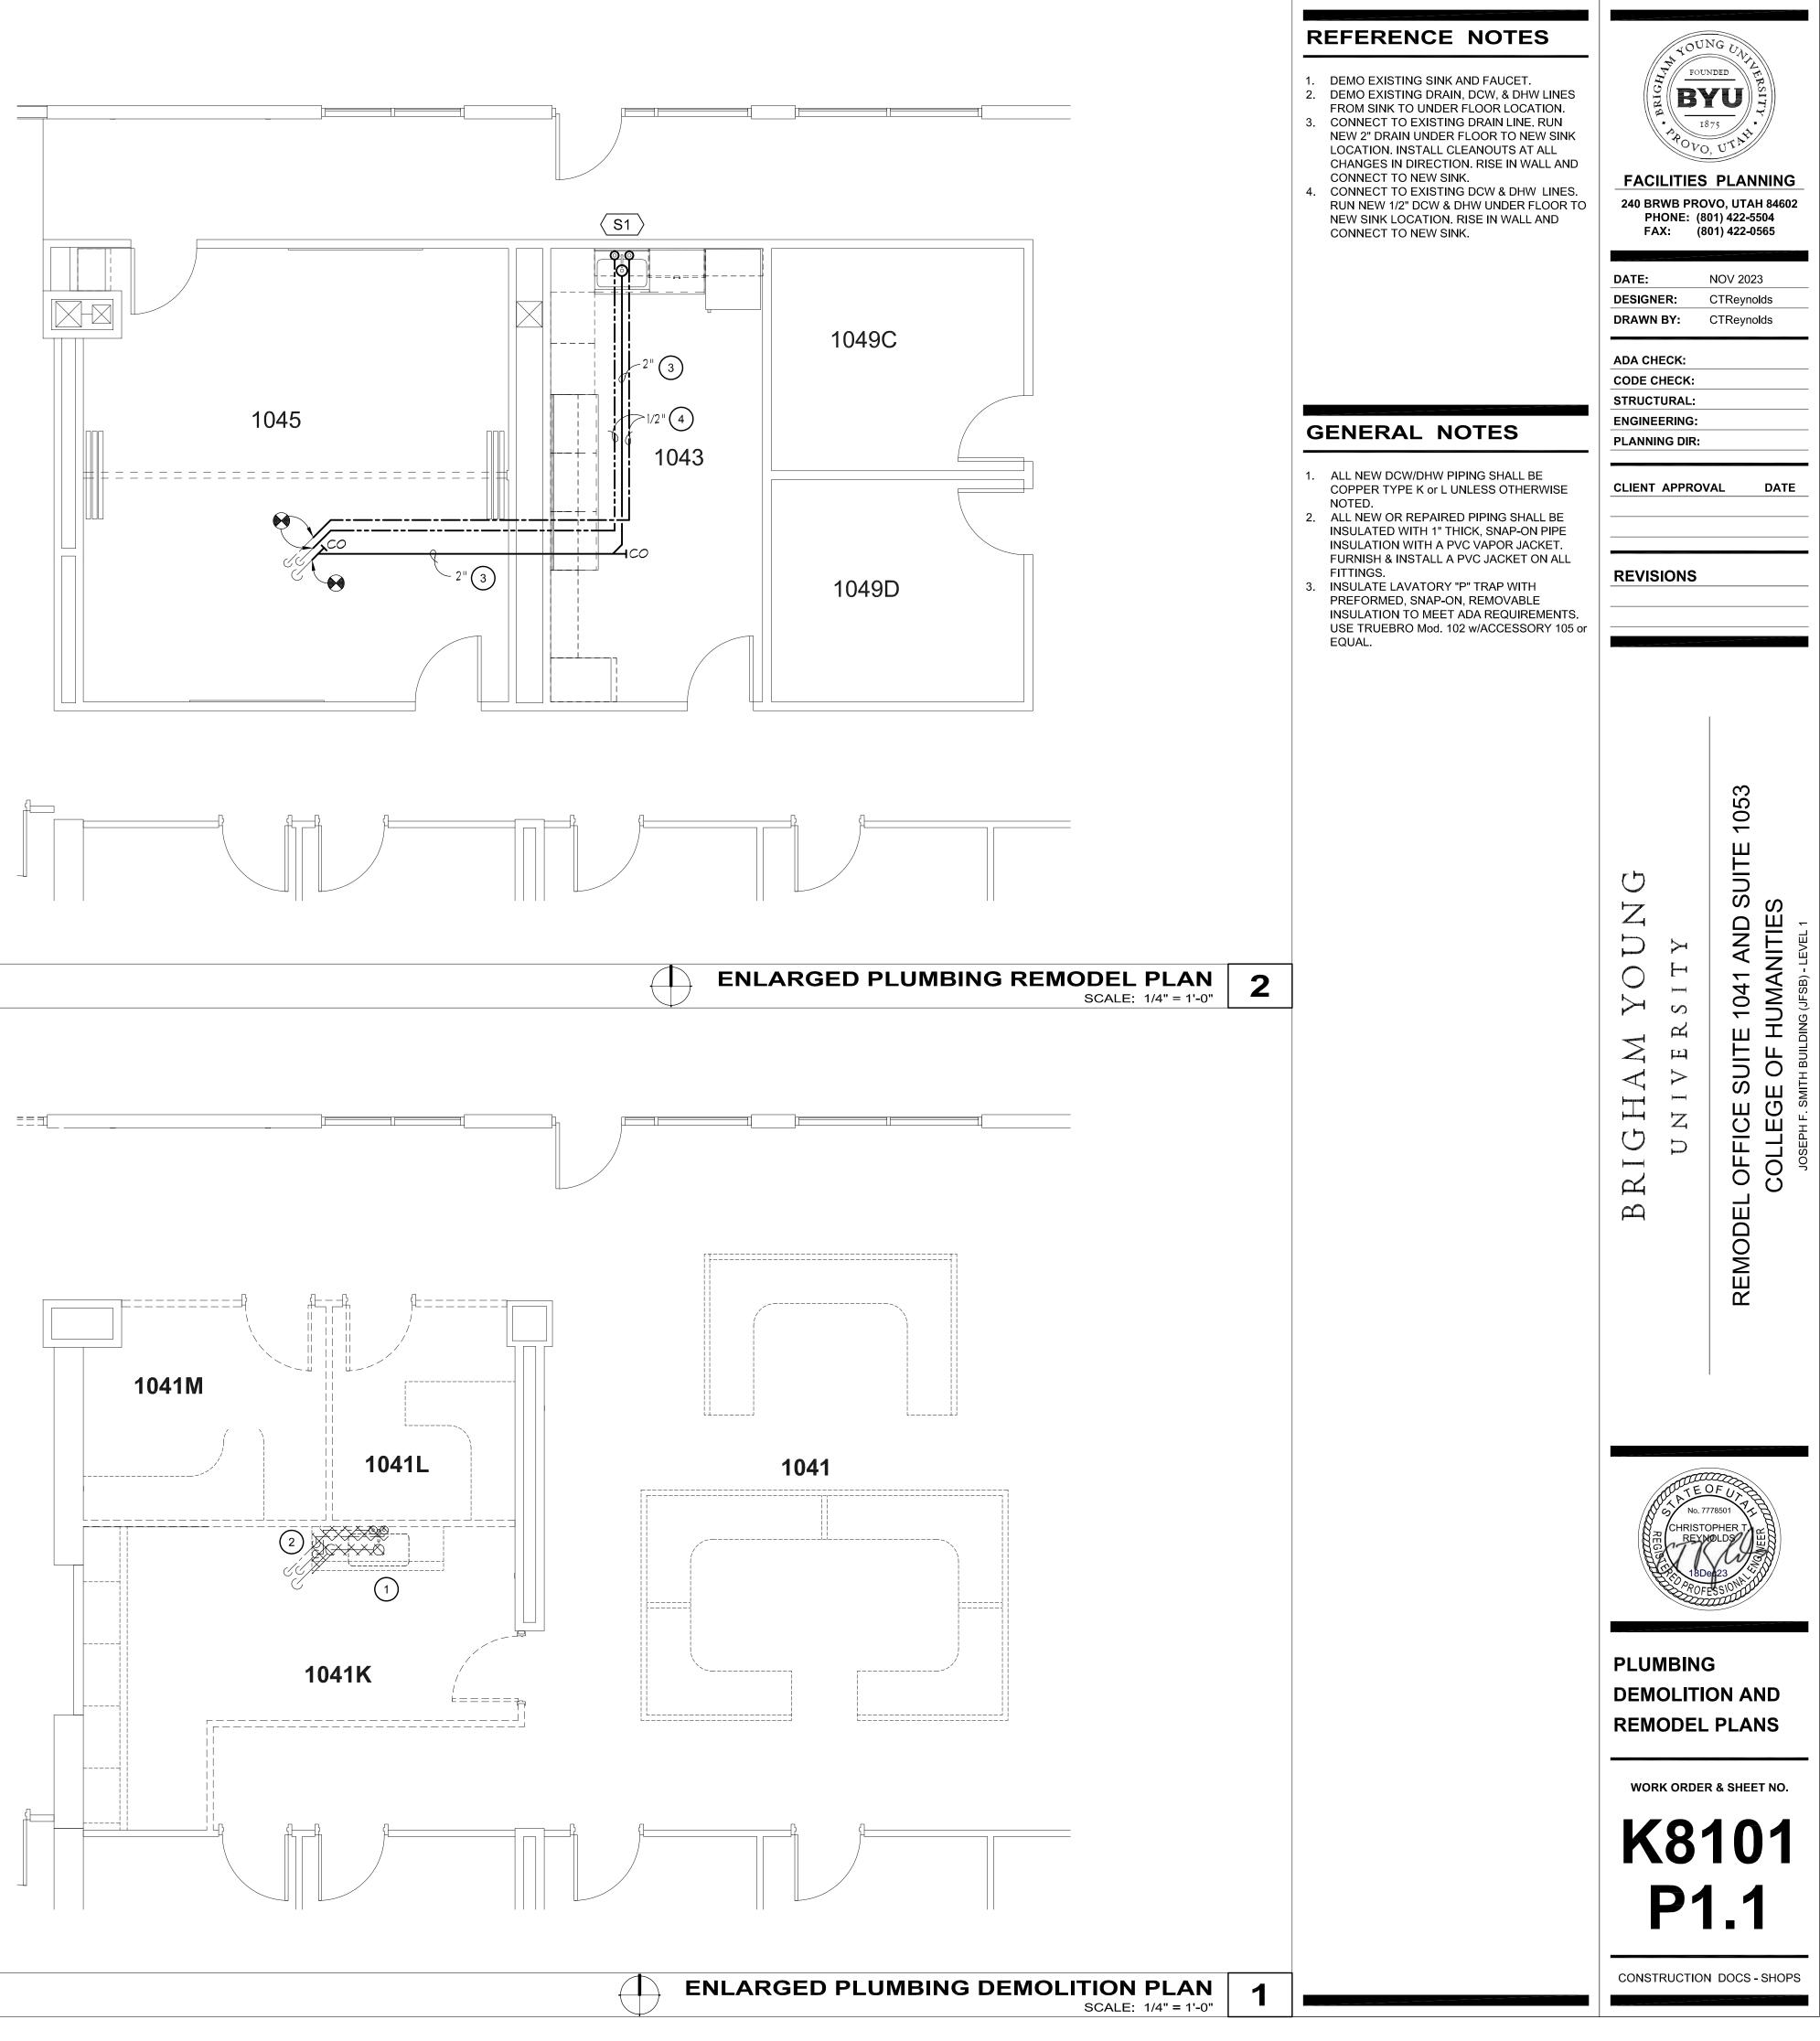
MECHANICAL **REMODEL PLANS**


WORK ORDER & SHEET NO.


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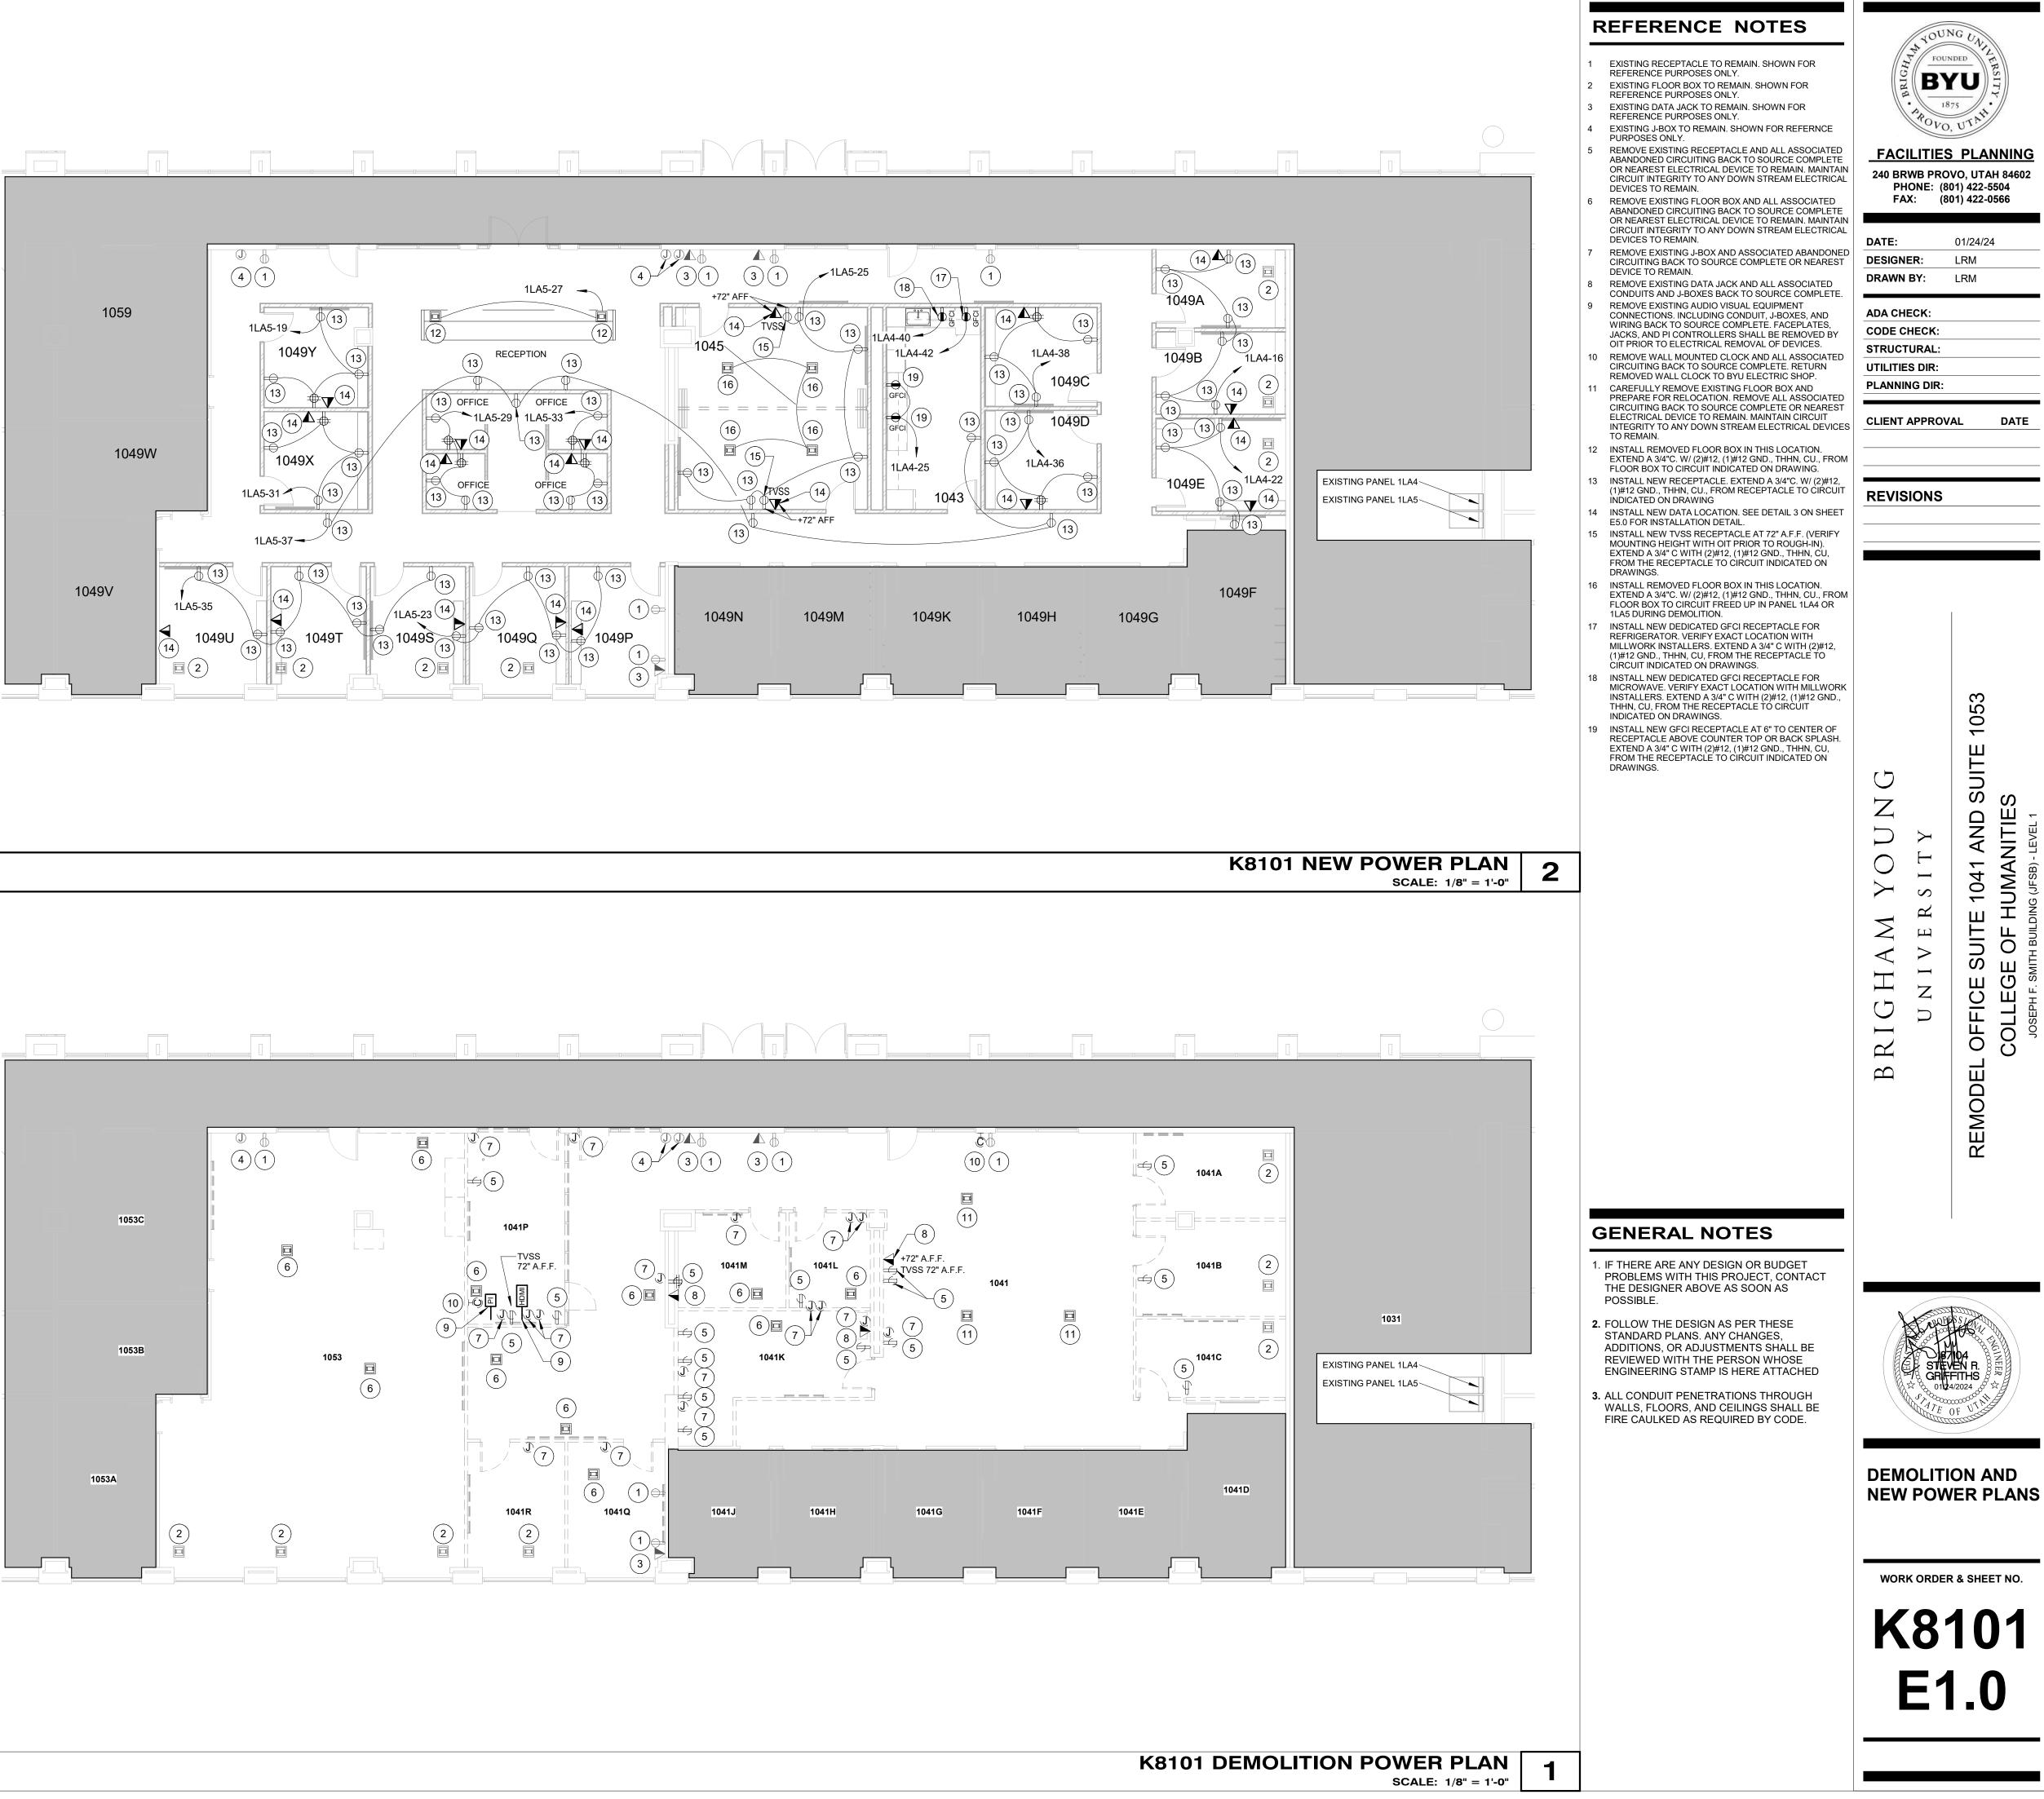
CONSTRUCTION DOCS - SHOPS


	PLUMBING FIXTURE SCHEDULE						
SYM	DESCRIPTION	COLD/ INLET	HOT/ OUTLET	TRAP	VENT		
S1	<u>BREAKROOM SINK</u> UNDER MOUNT, SINGLE COMPARTMENT, 28" $W \times 16$ " L $\times 10$ " D BOWL, 18 GAUGE 304 STAINLESS STEEL, FULLY COATED UNDERSIDE	KARRAN U-3Ø18	-	-	1-1/2"	1-1/4"	
	<u>SINK FAUCET</u> 8" FIXED CENTERS, 8" RIGID/SWING HIGH ARCH SPOUT, 2.2 GPM AERATOR, 4" WRISTBLADE HANDLES, QUATURN COMPRESSION OPERATING CARTRIDGE	СНІСА <u>G</u> O 527-НА8-ЗІТАВСР	1/2"	1/2"	-	-	







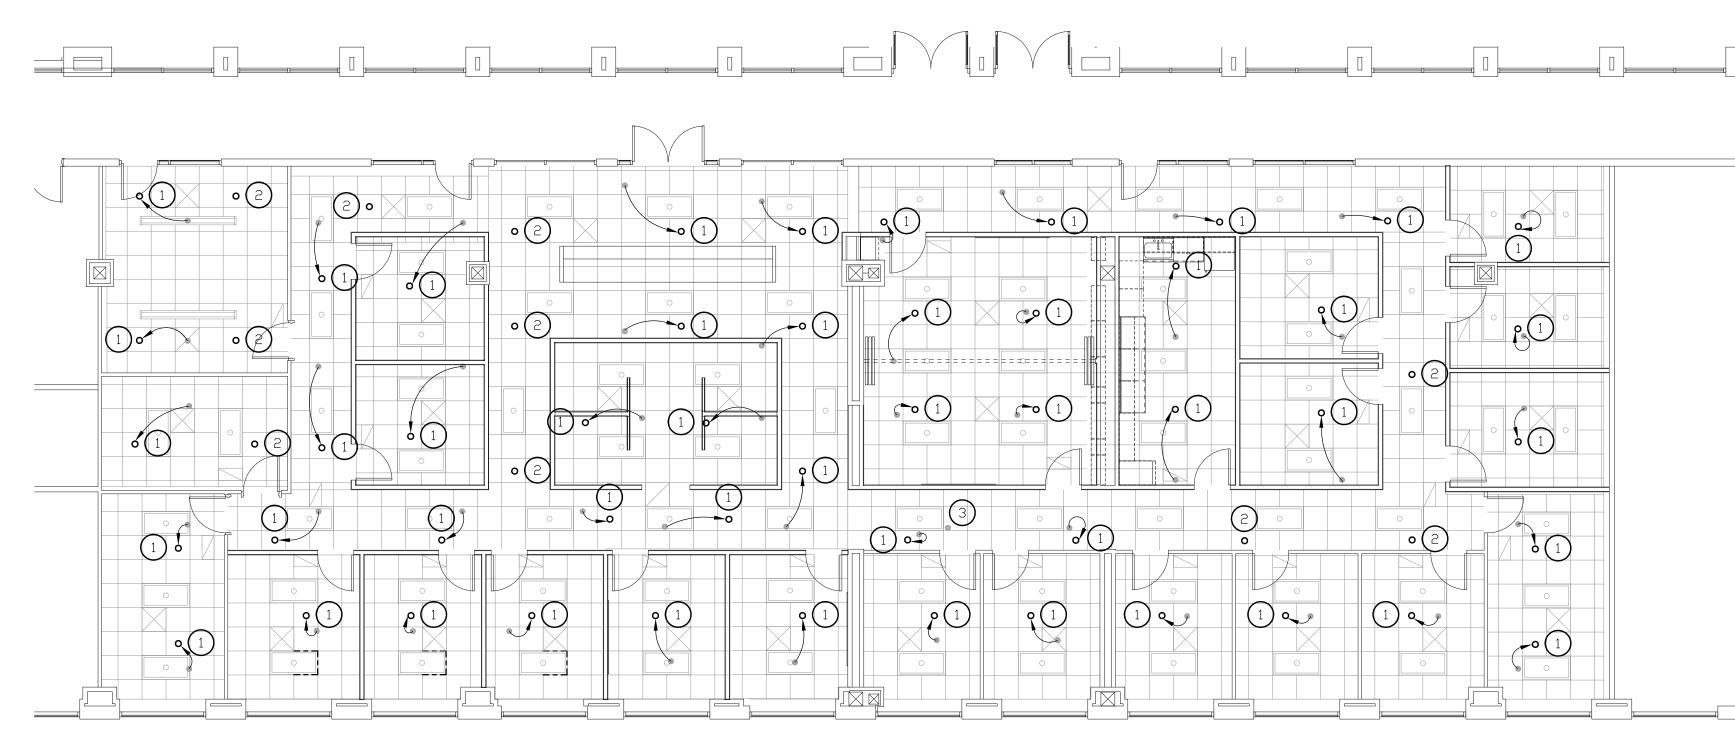


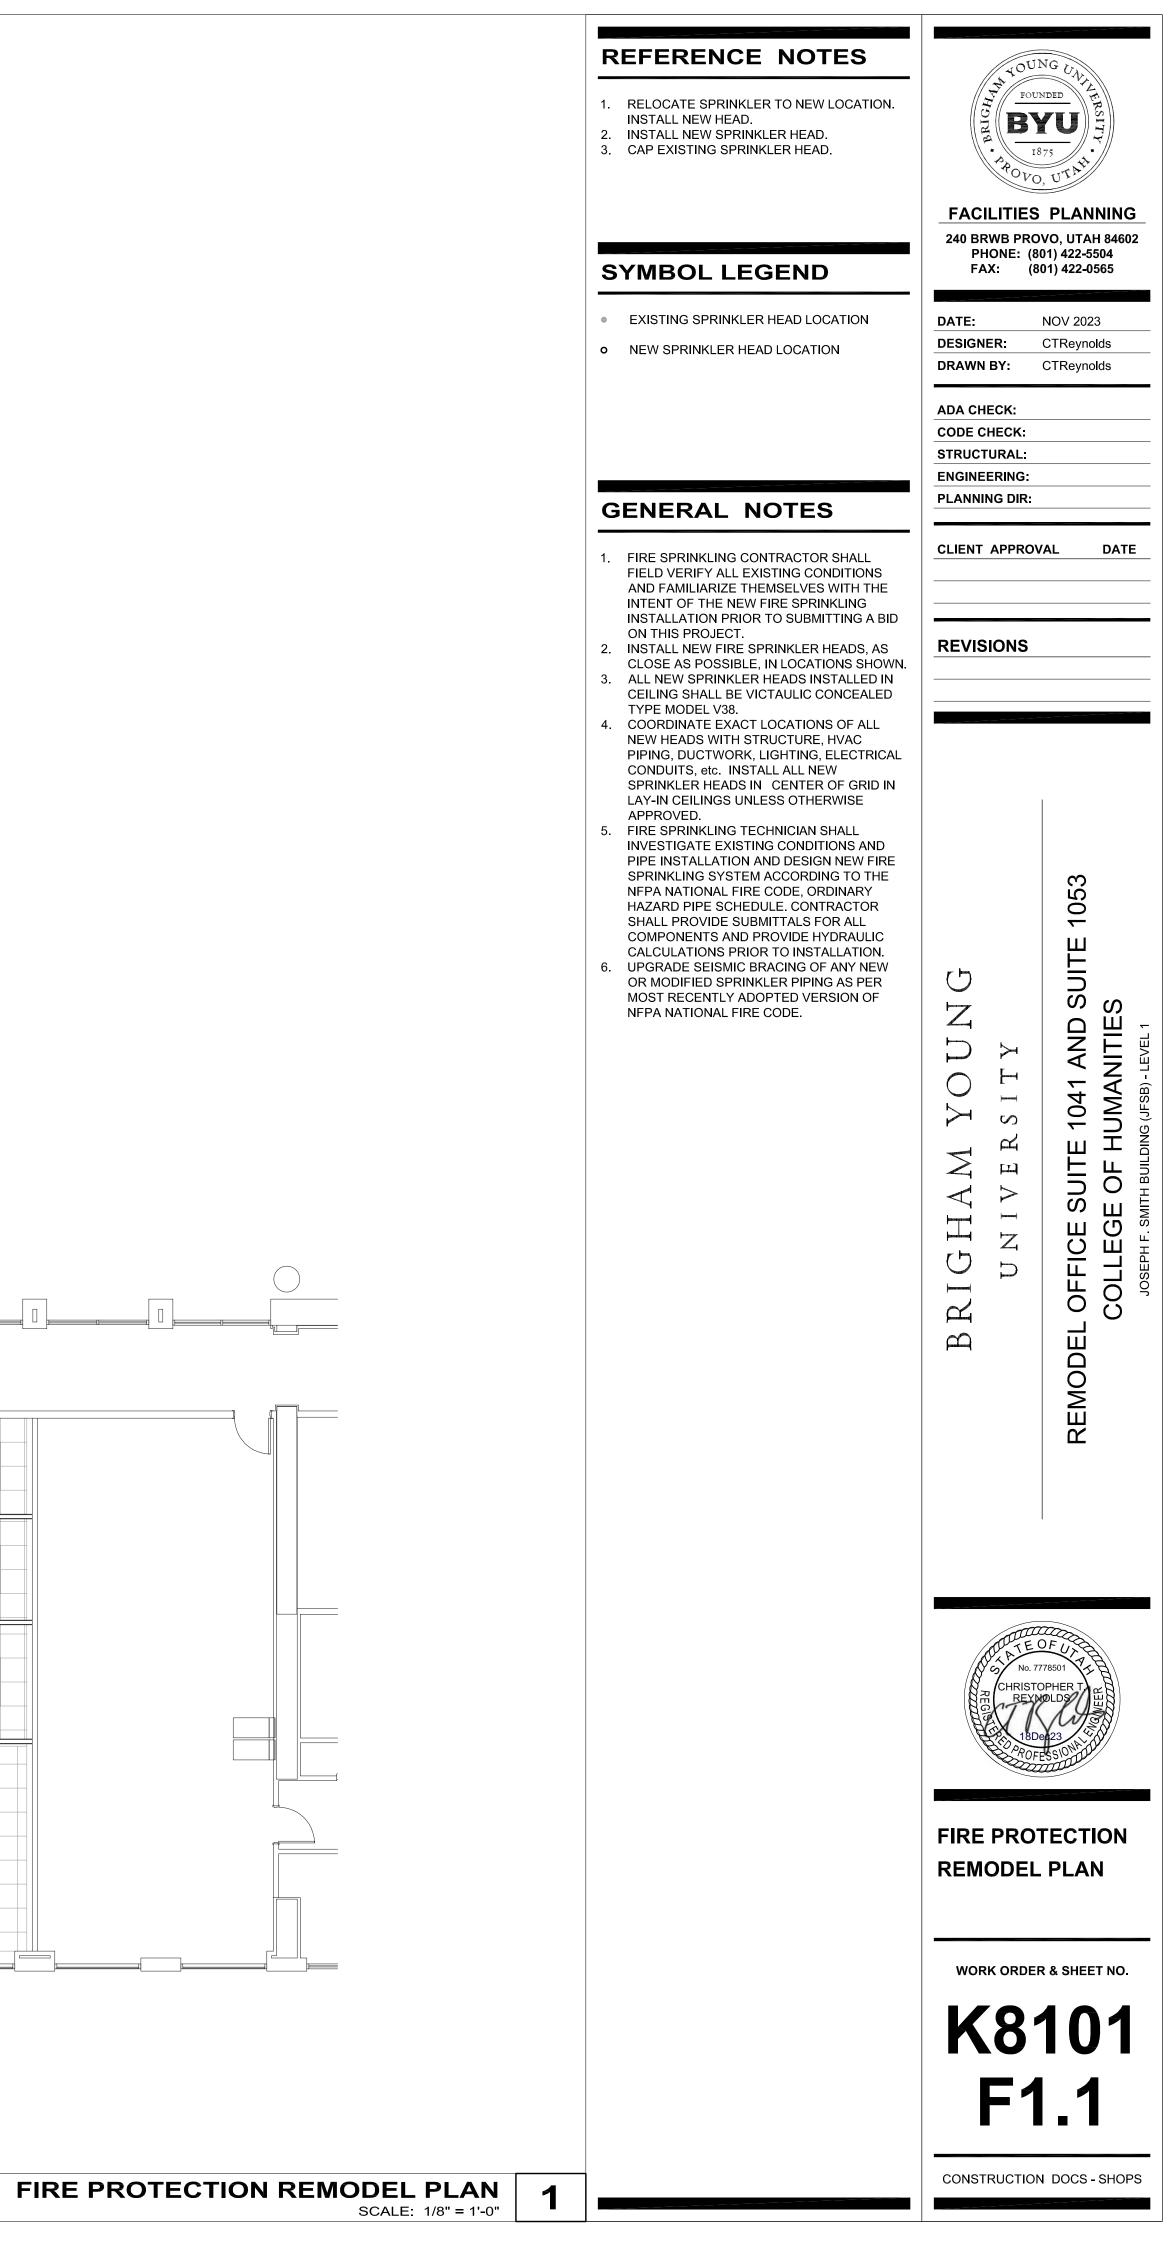

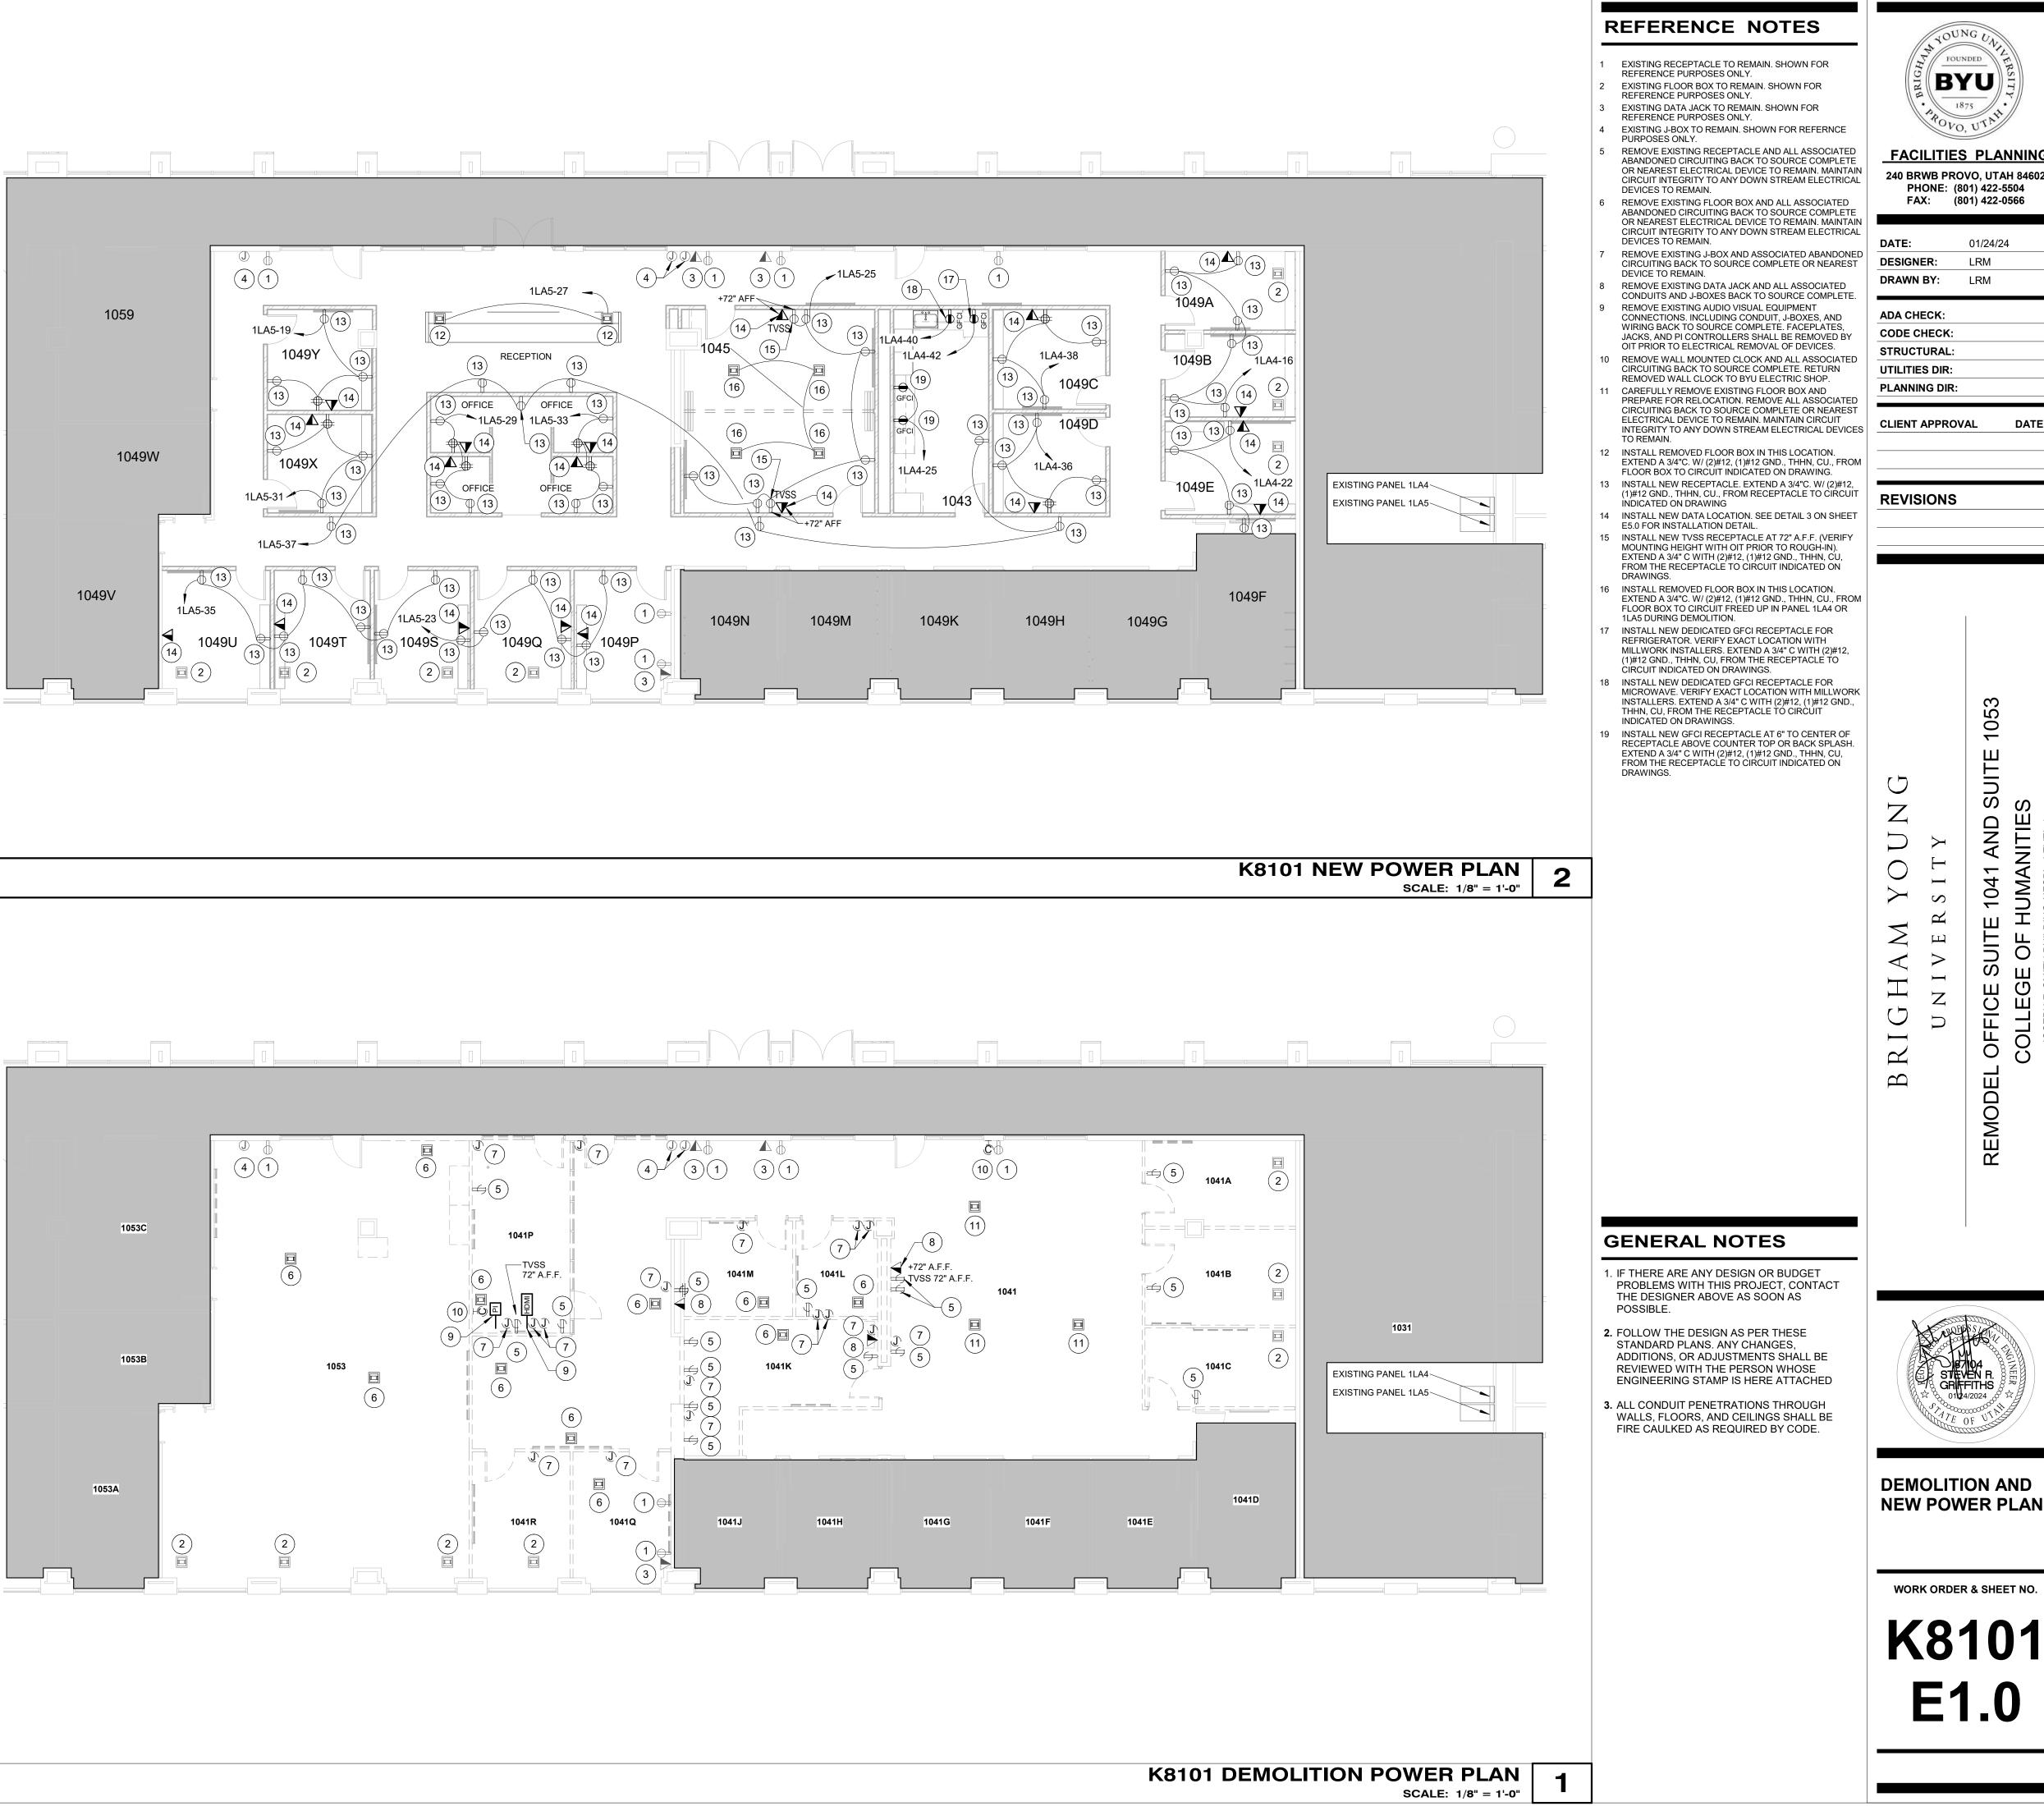

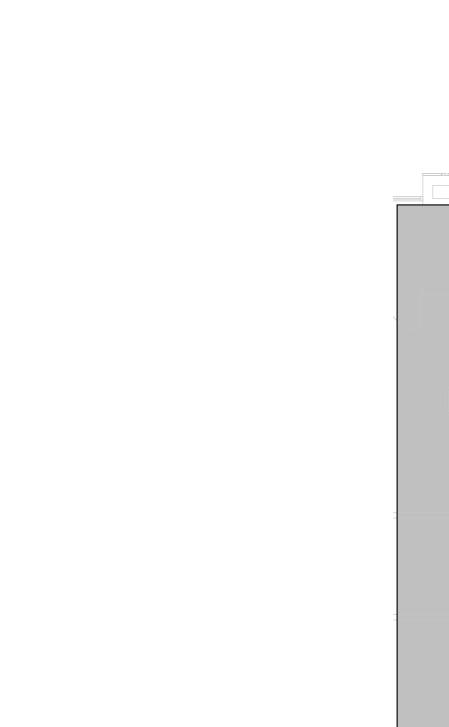


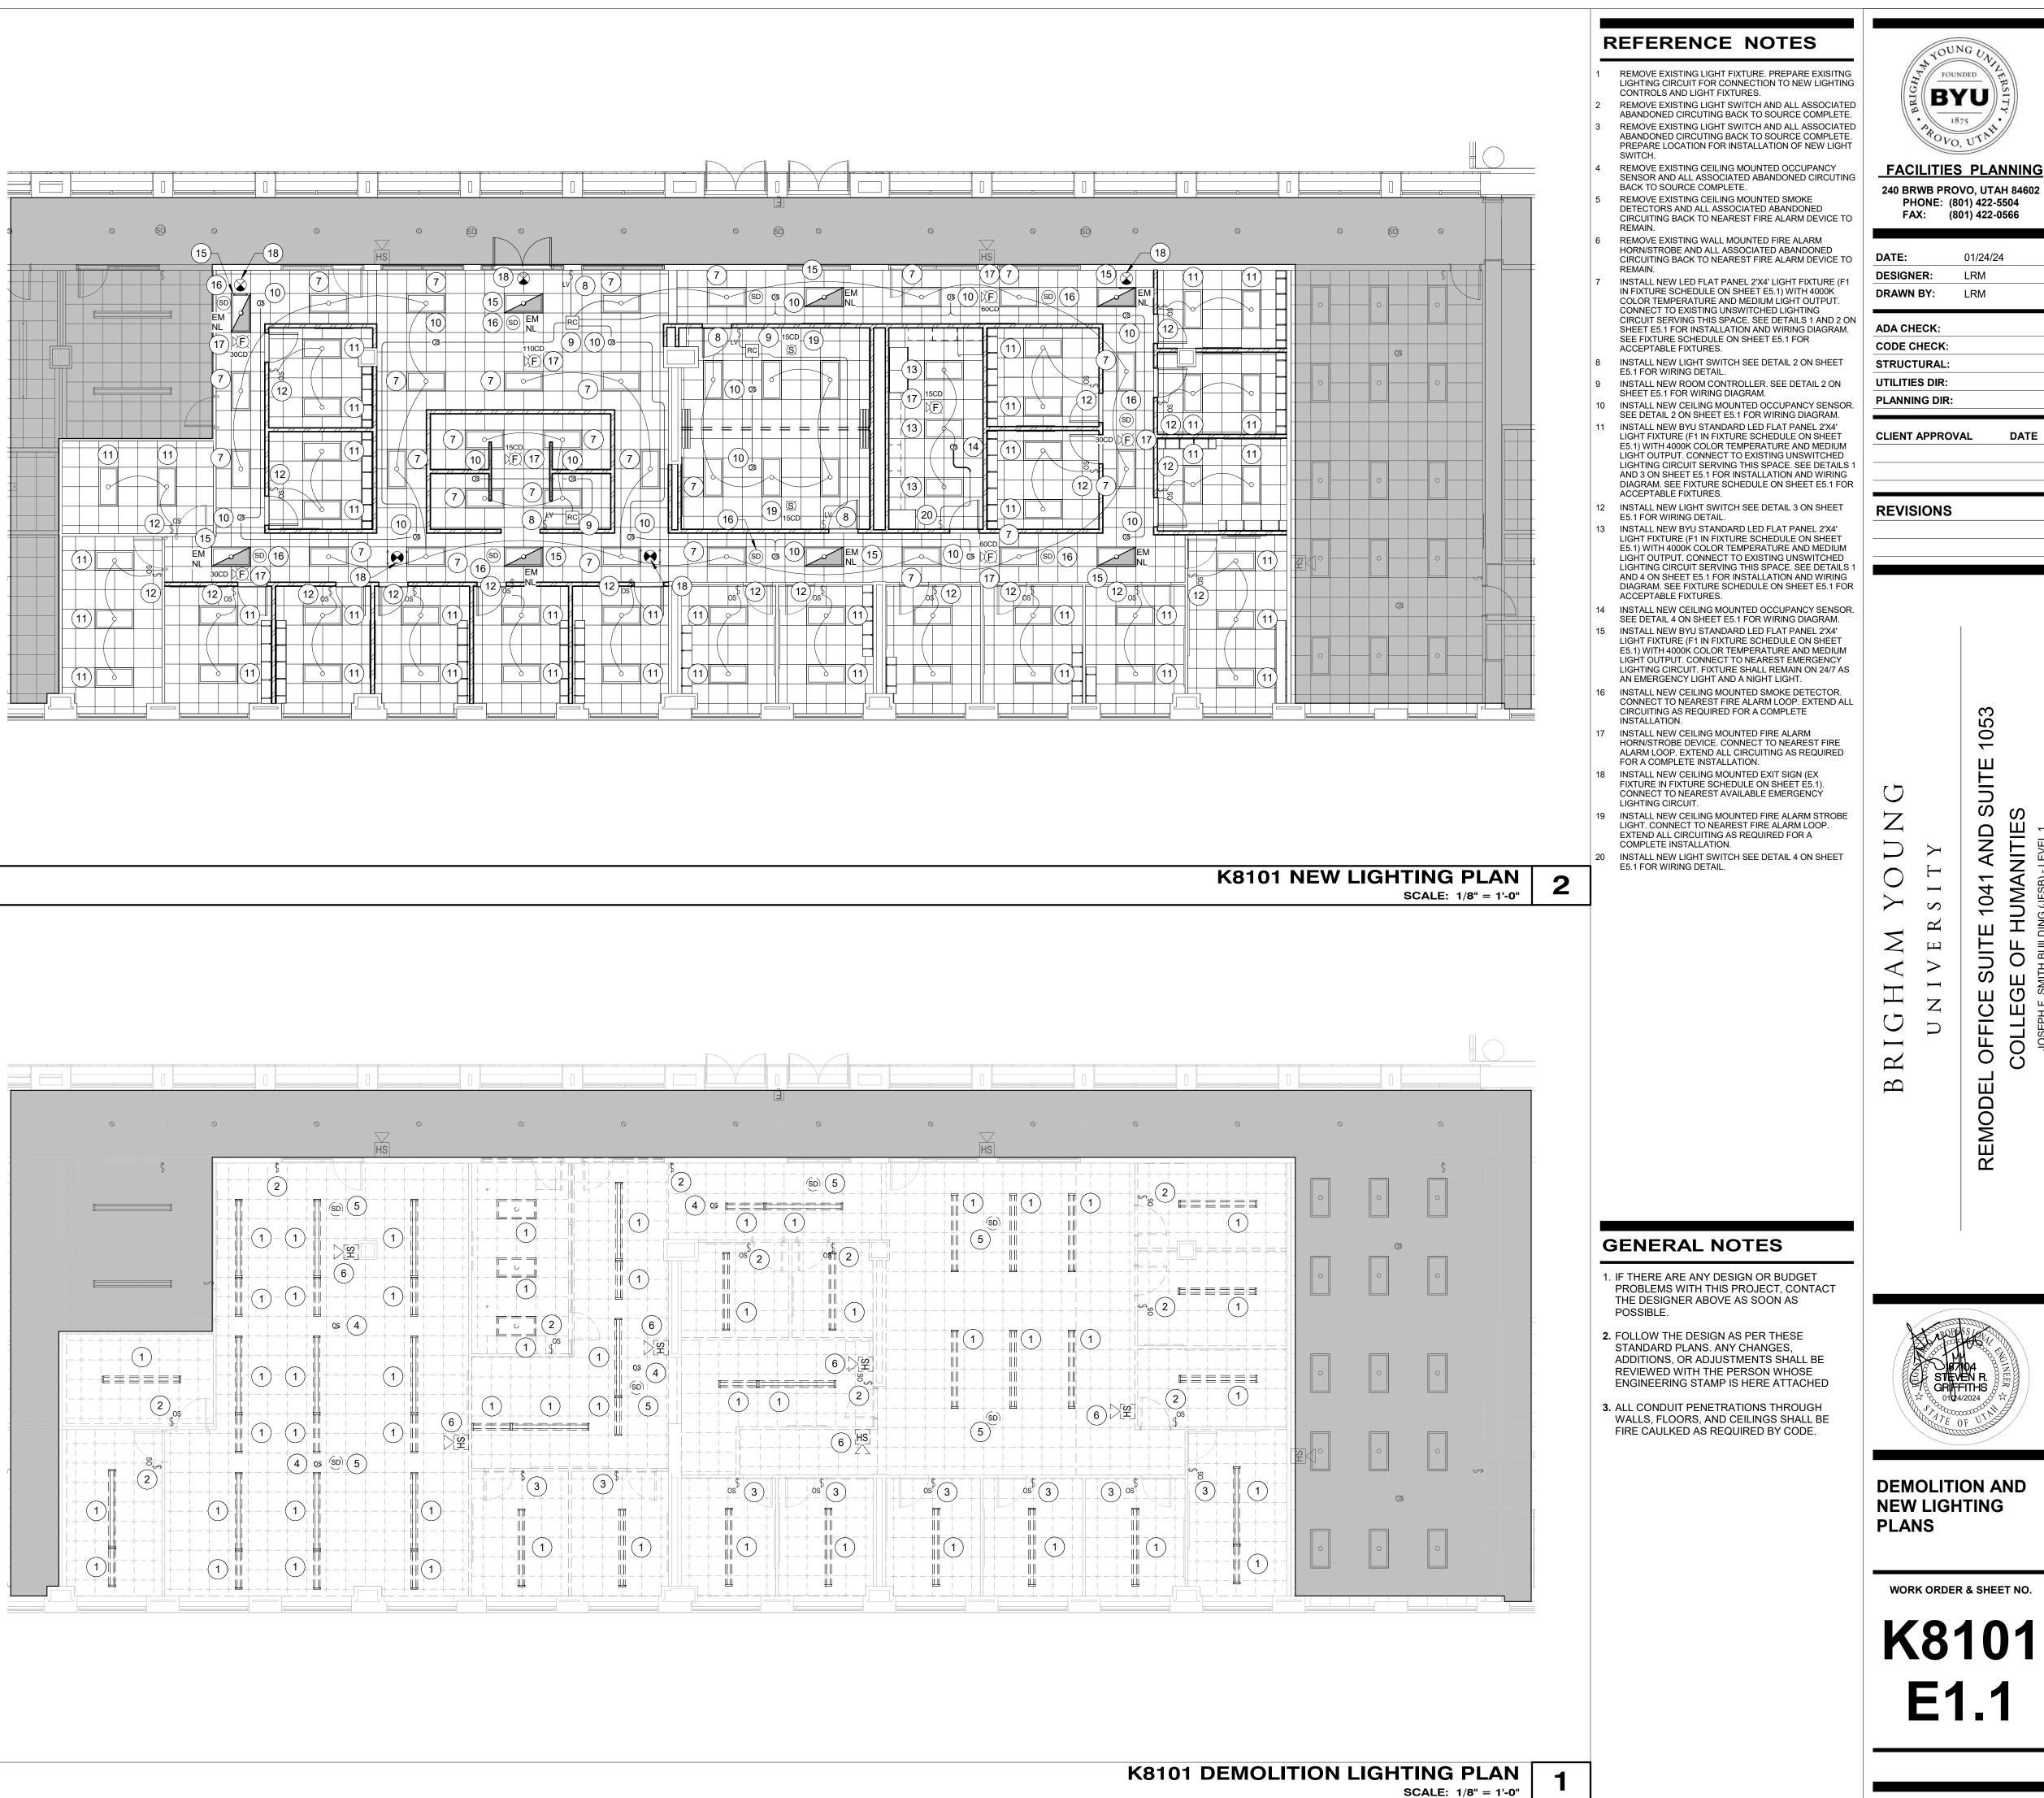


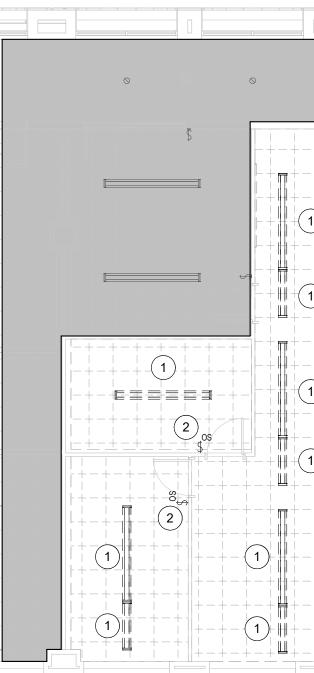


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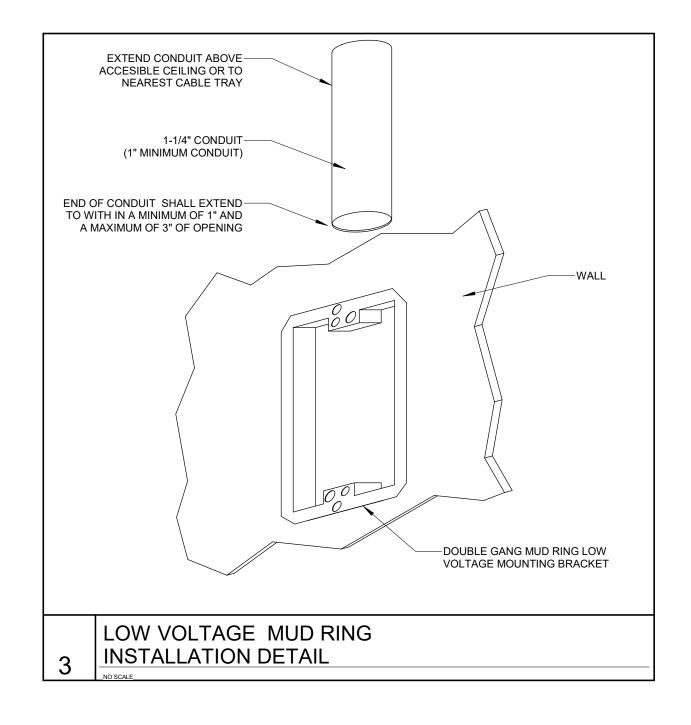
	DEVICES AND PATHWAYS
	WIRING SYSTEM CONCEALED IN WALL OR CEILING.
	BRANCH CIRCUIT HOMERUN TO PANEL.
J	JUNCTION BOX WITH CONNECTION TO EQUIPMENT SERVED. 4" SQUARE BOX WITH A SINGLE-GANG OPENING AND PLASTER RING.
=	DUPLEX RECEPTACLE, 20 AMP, 120 VOLT (USE 20 AMP FOR SINGLE RECEPTACLE ON A CIRCUIT).
-	DUPLEX RECEPTACLE MOUNTED 6" ABOVE COUNTER BACKSPLASH, OR AT HEIGHT
#	QUAD RECEPTACLE. TWO NEMA 5-20R DUPLEX RECEPTACLES.
GFI	GROUND FAULT RECEPTACLE. NEMA 5-20R DUPLEX. ALL RECEPTACLES INSTALLED OUTSIDE, WITHIN 6' OF A SINK OR IN A KITCHEN SHALL BE GFCI.
÷	DUPLEX RECEPTACLE, 20 AMP, 120 VOLT (USE 20 AMP FOR SINGLE RECEPTACLE ON A CIRCUIT). T.V. RECEPTACLE MOUNTED AT 72" A.F.F. OR AT HEI NOTED ON DRAWING.
== WP	WEATHERPROOF RECEPTACLE. NEMA 5-20R GFI DUPLEX.
TVSS	TELEVISION RECEPTACLE, 20 AMP, 120 VOLT (USE 20 AMP FOR SINGLE RECEPTACLE ON A CIRCUIT). MOUNTED AT HEIGHT SPECIFIED BY OIT.
	WIREMOLD NEMA 5-15R RECEPTACLES 24" ON CENTERS. ALTERNATE CIRCUITS.
н©	SPECIAL OUTLET. SEE PLANS.
HFC	MODULAR FURNITURE CONNECTION. PROVIDE DOUBLE-GANG BARRIERED J-BOX FOR POWER & TELE/DATA. EXTEND 1-1/4" EC TO ABOVE ACCESSIBLE CEILING FOR TELE/DATA. CONNECT POWER AS INDICATED.
	FLOOR BOX WITH POWER AND DATA CONNECTIONS. SEE KEYED NOTES ON SHEET PRODUCT PART NUMBER.
V÷	POKE THROUGH WITH POWER AND DATA CONNECTIONS. SEE KEYED NOTES ON S PRODUCT PART NUMBER.
PP	ELECTRICAL POWER POLE.

	PANELS, DISCONNECTS
	NON-FUSED HEAVY DUTY DISCONNECT SWITCH. NUMERALS INDICATE SWITCH RATING. NEMA 1 ENCLOSURE, UNLESS OTHERWISE NOTED.
	FUSED HEAVY DUTY DISCONNECT SWITCH. NUMERALS INDICATE SWITCH RATING/FUSE SIZE. NEMA 1 ENCLOSURE, UNLESS OTHERWISE NOTED.
Xr	CIRCUIT BREAKER. NUMERALS INDICATE RATING. NEMA 1 ENCLOSURE, UNLESS OTHERWISE NOTED.
	PANELBOARD. SEE SCHEDULE FOR MOUNTING. TOP OF PANEL AT 6'-6" AFF.
000	DOOR MOTOR CONTROL. MOUNT +48" AFF, CONTROLS SHALL BE UP, DOWN, AND STOP MOUNTED ON 4" SQUARE BOX (FLUSH BOX)

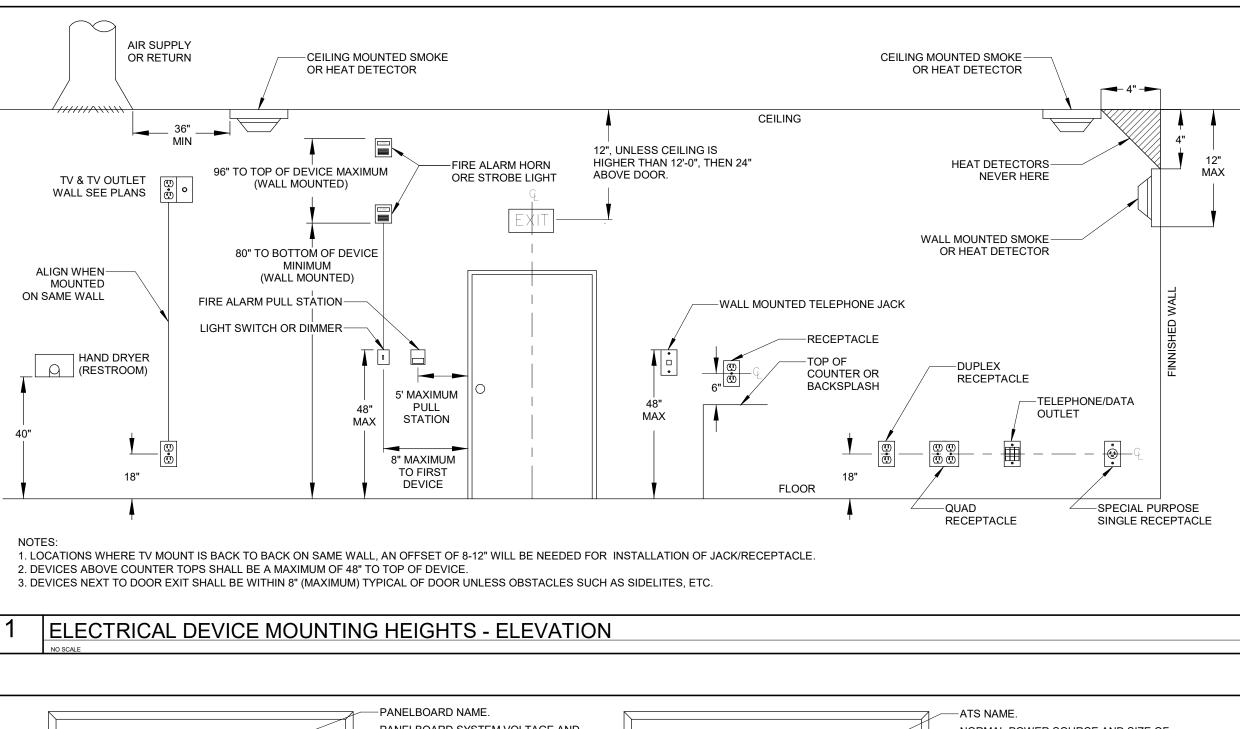TELECOMMUNICATIONS TELE/DATA OUTLET. 1" EC TO ABOVE NEAREST ACCESSIBLE CEILING FOR J-HOOK S

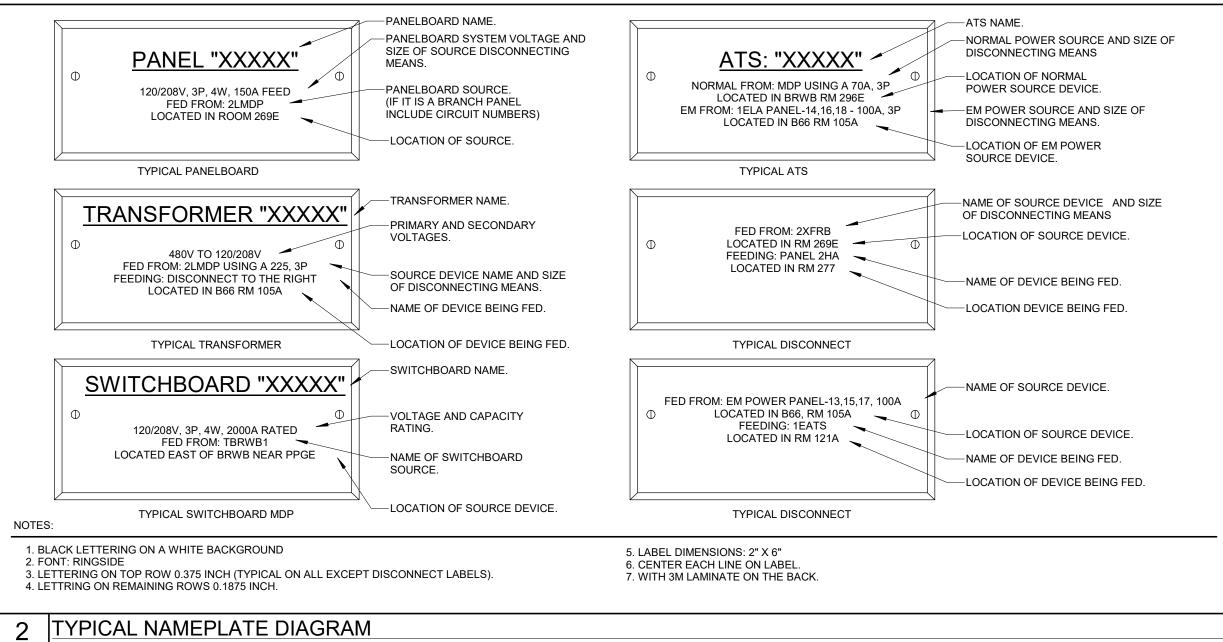LOCAL CABLE TRAY (WITHIN 6") AS APPLICABLE WITH PULL STRING. 4" SQUARE BOX SINGLE-GANG OPENING AND PLASTER RING.

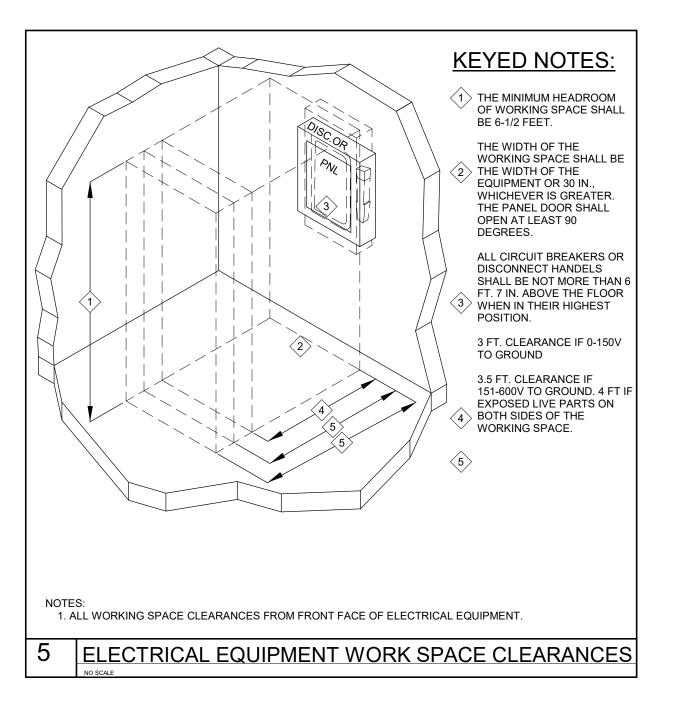 \mathbf{V}



	L	IGHTING (S	SEE FIXTURE SCH.)	NYOUN	G UNIT
	0		URE. SEE FIXTURE SCHEDULE. SUSPEND TWO CORNERS WITH ALLOW GRID ALONE TO SUPPORT FIXTURE.	THE BY	
		LED STRIP LIGHT FIXTURE.		187	5
	0	LED RECESSED DOWN LIGHT FI	IXTURE.	Rovo,	UTA
NOTED.	Ю	WALL MOUNTED LED LIGHT FIX		FACILITIES 240 BRWB PROV	
		FIXTURE CONNECTED TO E	EMERGENCY LIGHTING CIRCUIT. SEE FIXTURE SCHEDULE FOR	PHONE: (80	
	•	LED DOWNLIGHT CONNECTED T FOR FIXTURE TYPE.	TO EMERGENCY LIGHTING CIRCUIT. SEE FIXTURE SCHEDULE		
нт	+ (A) (A)		NUMBERS OF FACES AS INDICATED ON PLANS. CONNECTED TO T. SEE LIGHTING FIXTURE SCHEDULE.		01/24/24 LRM
		EMERGENCY LIGHT FIXTURE. C	ONNECTED TO EMERGENCY LIGHTING CIRCUIT. SEE LIGHTING	DRAWN BY:	LRM
			KIT COMBO FIXTURE CONNECTED TO EMERGENCY LIGHTING	ADA CHECK:	
	\$	CIRCUIT. SEE FIXTURE SCHEDU SINGLE POLE SWITCH, 20 AMP,		CODE CHECK: STRUCTURAL:	
	\$ ³	THREE WAY SWITCH, 20 AMP, 12	20/277 VOLT.	UTILITIES DIR:	
	\$ ⁴	FOUR WAY SWITCH, 20 AMP, 120	0/277 VOLT.	PLANNING DIR:	
FOR	\$ ^D	DIMMER SWITCH.			AL DATE
EET FOR	\$ ^{oc}	WALL MOUNTED OCCUPANCY S	ENSOR AND SWITCH WITH DUAL TECHNOLOGY.		
	\$ ^{LV}	LOW VOLTAGE LIGHT SWITCH.		REVISIONS	
			Y SENSOR, DUAL TECHNOLOGY.		
	PP	CEILING MOUNTED OCCUPANCY			
	EM	EMERGENCY LIGHTING CONTROL			
		FI	RE ALARM		1053
	FACP	FIRE ALARM CONTROL PANEL W	VITH LOCAL SMOKE DETECTOR.		
	(SD) RA		ATOR. PROVIDE BOX AS REQUIRED PER ATION. PROVIDE 1"C CONDUIT FOR CABLING.	U	SUITE S
	M	FIRE ALARM MANUAL STATION.	PROVIDE PROTECTION DEVICE	Z	
	SD	CEILING MOUNTED SMOKE DET	ECTOR. FA VENDOR PROVIDED.	X C	I AND NITIE
	HD	CEILING MOUNTED HEAT DETEC			
SYSTEM OR TO (WITH A	(DD)———	CONTRACTOR, INSTALLED BY M OF DUCT, INSTALLATION OF DE	CTOR. FURNISHED AND CONNECTED BY ELECTRICAL MECHANICAL CONTRACTOR. CUTTING TECTOR. AND DETERMINATION OF SAMPLING TUBE NICAL CONTRACTOR. PROVIDE REMOTE INDICATING	M Y E R S	н Н Н Н Н Н П
	FS	SPRINKLER SYSTEM FLOW SWI	TCH.	A M V E]	E OF
	TS	SPRINKLER SYSTEM TAMPER S	WITCH.	H Z	ШО
	SD	SMOKE DAMPER. FURNISHED A FIRE ALARM SYSTEM BY ELECT	ND INSTALLED BY MECHANICAL CONTRACTOR, CONNECTED TO RICAL CONTRACTOR.		DLLE JOSEPH F
	DH		OVIDED BY GENERAL CONTR, INSTALLED BY ELEC. TECTOR WITHIN 5 FT. OF BOTH SIDES OF DOORS IPON SMOKE SIGNAL.	RI RI	
	F	ADA COMPLIANT WALL MOUNT I NOTED. WHITE FINISH.**.	FIRE ALARM HORN WITH STROBE LIGHT, 15CD UNLESS OTHERWISE	BI	Ē
	Ś	ADA COMPLIANT WALL MOUNT I WHITE FINISH.	FIRE ALARM STROBE LIGHT, 15CD UNLESS OTHERWISE NOTED.		OO
	FX	UNLESS OTHERWISE NOTED. W			REMODEL
	S	OTHERWISE NOTED. WHITE FIN			R
	R		ITED FIRE ALARM SPEAKER STROBE LIGHT, 15cd,		
		UNLESS OTHERWISE NOTED. W			
	(SP)	UNLESS OTHERWISE NOTED. W	/HITE FINISH.		
	R				
				N 15555	
r					
GEN	NERAL	NOTES	ABBREVIATIONS	STEV	
ISSUE THE I			+42" DIMENSION INDICATES HEIGHT ABOVE FINISHED FLOOR AT WHICH CENTER OF DEVICE IS TO BE MOUNTED. SEE PLANS. 3R NEMA 3R RATING AFF ABOVE FINISHED FLOOR	$ \begin{array}{c} $	$ \begin{array}{c} 2024 \\ 2024 \\ 0^{0} \\ $
2. FOLL	OW THE DESIGI	AS PER THESE	AFF ABOVE FINISHED FLOOR AHJ AUTHORITY HAVING JURISDICTION AHU AIR HANDLER UNIT C CONDUIT WITH PULL CORD		
ADDI		NY CHANGES, STMENTS SHALL BE E PERSON WHOSE	C.B. CIRCUIT BREAKER CLG INSTALLED IN CEILING EC EMPTY CONDUIT WITH PULL CORD	ELECTRIC SYMBOLS	
ENGI	EWED WITH THE NEERING STAMI CHED.		E.C. ELECTRICAL CONTRACTOR EWC ELECTRIC WATER COOLER EWH ELECTRIC WATER HEATER	AND DETA	
3. SEE (OIT DRAWINGS	FOR PATHWAYS	FACPFIRE ALARM CONTROL PANELFPNFUSE PER NAMEPLATE		
	J-BOXES REQUI AUDIO/VISUAL N	RED FOR TELE/DATA EEDS.	LC LIGHTING CONTACTOR M.C. MECHANICAL CONTRACTOR P.C. PLUMBING CONTRACTOR	WORK ORDER	& SHEET NO.
WALL		RATIONS THROUGH D CEILINGS SHALL 5 REQUIRED BY	U.G. UNDERGROUND WP WEATHER PROOF S.E. SERVICE ENTRANCE EM EMERGENCY FIXTURE WITH BATTERY		

lsc

CURRENT

CODE.

SCOPE OF WORK.

5. ALL SHADED AREAS ARE OUTSIDE


RMS SYMMETRICAL SHORT CIRCUIT

OR GENERATOR BACK-UP


AIC AMPERE INTERRUPTING CAPACITY (EQUIPMENT RATING) TVSS TV RECEPTACLE MOUNTED AT HEIGHT


DESIGNATED BY OIT.

K8101 **E5.0**

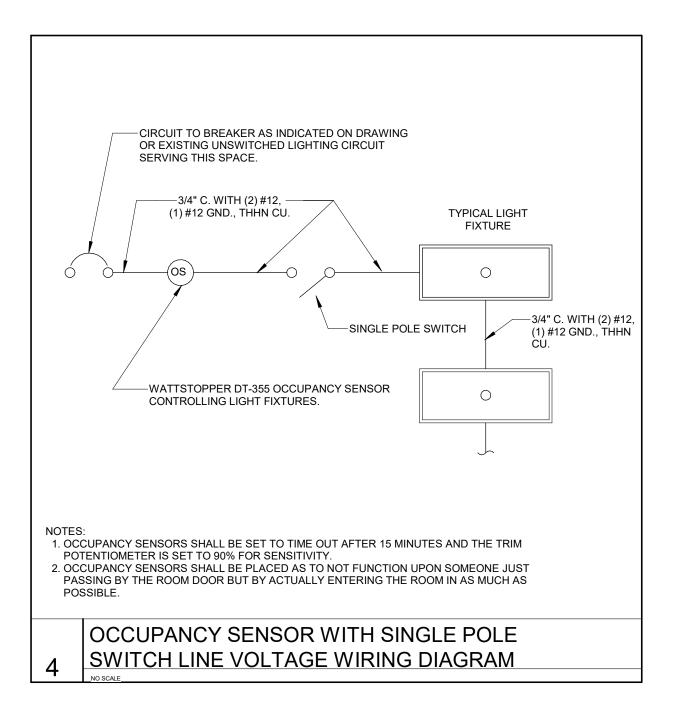

	BYU LIGHITNG FIXTURE SCHEDULE										
FIXTURE	MANUFACTURER	FIXTURE CATALOG NUMBER				FIXTU	RE	FIXTURE DESCRIPTION REMARKS			
NUMBER	MANOFACTORER		ТҮРЕ	QTY.	VOLTS	WATTS	MOUNTING				
F1	LITHONIA SLG BLG SYLVANIA COOPER	CPX 2X4 ALO8 SWW7 TPS2435/45/55G2FSK LPX-24-CP4 PANELF3BSO45UNVD8699 24CGTS-L3C3	LED	1	UNV	50	CEILING TROFFER	2X4 LED FLAT PANEL TROFFER			
EX	DUAL LITE	SESGW (SINGLE FACE) SEDGW (DOUBLE FACE)	LED	2	UNIV	2.1		WALL OR CEILING MOUNTED EXIT SIGN WITH SINGLE OR DOUBLE FACE LETTERING AND BREAK OUT CHEVRONS FOR DIRECTION ARROWS.			

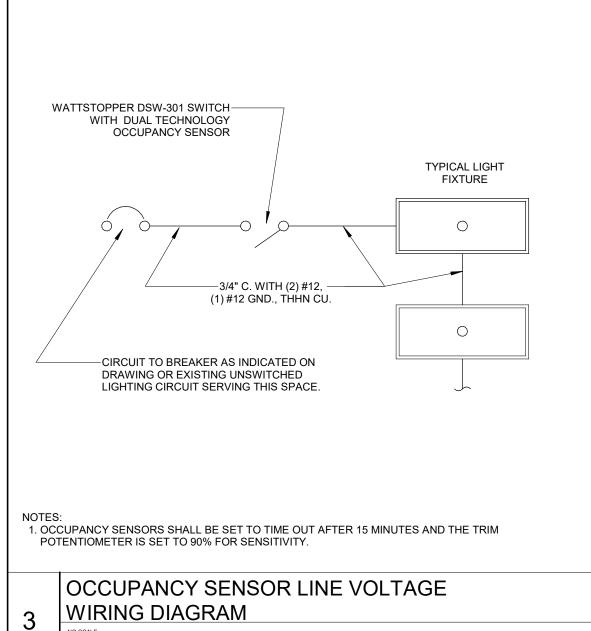

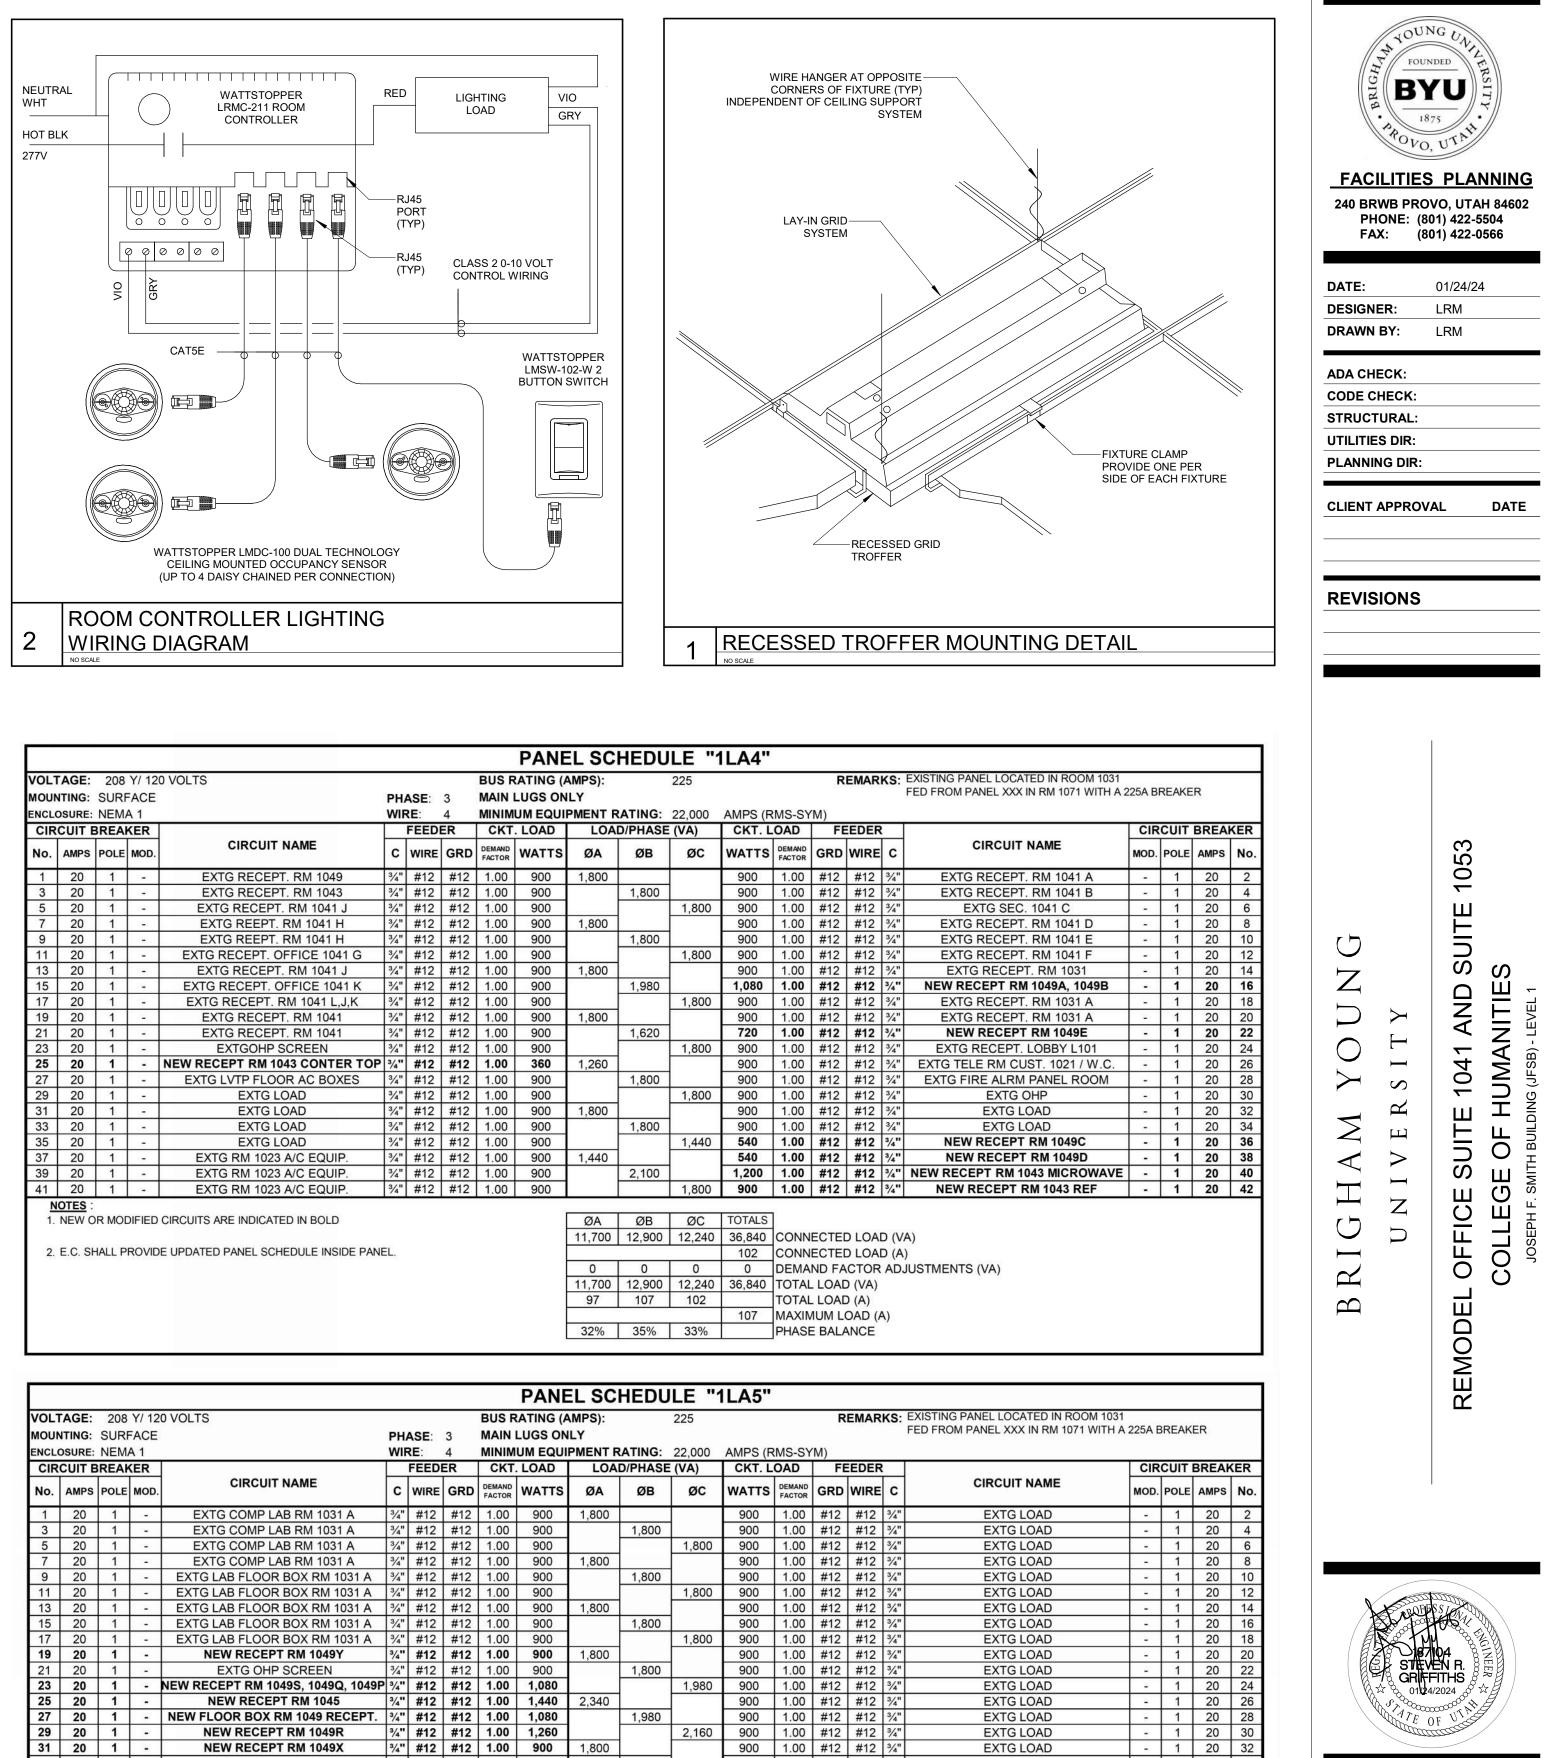

2,160

2,160

 900
 1.00
 #12
 #12
 3/4"

 900
 1.00
 #12
 #12
 3/4"

 900
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 900
 1.00
 #12
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 10,520
 12,240
 12,500
 30,100
 CONNECTED LOAD (VA)

 0
 0
 0
 0
 DEMAND FACTOR ADJUSTMENTS (VA)

 13,320
 12,240
 12,600
 38,160
 TOTAL LOAD (VA)

 111
 102
 105
 TOTAL LOAD (A)

 9
 90%
 90%
 90%

 ØA
 ØB
 ØC
 TOTALS

 13,320
 12,240
 12,600
 38,160
 CONNECTED LOAD (VA)

35% 32% 33% PHASE BALANCE

EXTG LOAD

EXTG LOAD EXTG LOAD

EXTG LOAD

EXTG LOAD

EXTG LOAD

1,800

1,980

2,160

900

									PA	
VOL	TAGE:	208	Y/ 12	0 VOLTS				BUS F	RATIN	
MOUN	NTING:	SURF	ACE		PH/	ASE:	3	MAIN	LUGS	
ENCL	OSURE:	NEM	A 1		WIF	RE:	4	MINIM	UM EQ	
CIR	CUIT	BREA	KER		FEEDER			CKT. LOAI		
No.	AMPS	POLE	MOD.	CIRCUIT NAME	с	WIRE	GRD	DEMAND FACTOR	WAT	
1	20	1	-	EXTG RECEPT. RM 1049	3/4"	#12	#12	1.00	900	
3	20	1	-	EXTG RECEPT. RM 1043	3/4"	#12	#12	1.00	900	
5	20	1	-	EXTG RECEPT. RM 1041 J	3/4"	#12	#12	1.00	900	
7	20	1	34	EXTG REEPT. RM 1041 H	3/4"	#12	#12	1.00	900	
9	20	1	-	EXTG REEPT. RM 1041 H	3/4"	#12	#12	1.00	900	
11	20	1	-	EXTG RECEPT. OFFICE 1041 G	3/4"	#12	#12	1.00	900	
13	20	1	-	EXTG RECEPT. RM 1041 J	3/4"	#12	#12	1.00	900	
15	20	1		EXTG RECEPT. OFFICE 1041 K	3/4"	#12	#12	1.00	900	
17	20	1		EXTG RECEPT. RM 1041 L, J, K	3/4"	#12	#12	1.00	900	
19	20	1	124	EXTG RECEPT. RM 1041	3/4"	#12	#12	1.00	900	
21	20	1	-	EXTG RECEPT. RM 1041	3/4"	#12	#12	1.00	900	
23	20	1	-	EXTGOHP SCREEN	3/4"	#12	#12	1.00	900	
25	20	1		NEW RECEPT RM 1043 CONTER TOP	3/4"	#12	#12	1.00	36	
27	20	1	-	EXTG LVTP FLOOR AC BOXES	3/4"	#12	#12	1.00	900	
29	20	1	-	EXTG LOAD	3/4"	#12	#12	1.00	900	
31	20	1	1.71	EXTG LOAD	3/4"	#12	#12	1.00	900	
33	20	1		EXTG LOAD	3/4"	#12	#12	1.00	900	
35	20	1	-	EXTG LOAD	3/4"	#12	#12	1.00	900	
37	20	1	-	EXTG RM 1023 A/C EQUIP.	3/4"	#12	#12	1.00	900	
39	20	1	. . .	EXTG RM 1023 A/C EQUIP.	3/4"	#12	#12	1.00	900	
41	20	1	-	EXTG RM 1023 A/C EQUIP.	3/4"	#12	#12	1.00	900	
	OTES :		-	EATO KM 1020 A/O EQUIP.	74	#12	#12	1.00		

/OL1	AGE:	208	Y/ 12	0 VOLTS				BUS R	ATIN
	TING:				рн/	ASE:	3	MAIN	
	OSURE:				WIF		4	MINIM	
	CUIT B					FEED			LOA
No.	AMPS					WIRE	GRD	DEMAND FACTOR	WA
1	20	1	-	EXTG COMP LAB RM 1031 A	3/4"	#12	#12	1.00	90
3	20	1	-	EXTG COMP LAB RM 1031 A	3⁄4"	#12	#12	1.00	90
5	20	1	· ••	EXTG COMP LAB RM 1031 A	3/4"	#12	#12	1.00	90
7	20	1	-	EXTG COMP LAB RM 1031 A	3/4"	#12	#12	1.00	90
9	20	1	-	EXTG LAB FLOOR BOX RM 1031 A	3/4"	#12	#12	1.00	90
11	20	1	-	EXTG LAB FLOOR BOX RM 1031 A	3/4"	#12	#12	1.00	90
13	20	1	14	EXTG LAB FLOOR BOX RM 1031 A	3/4"	#12	#12	1.00	90
15	20	1	-	EXTG LAB FLOOR BOX RM 1031 A	3/4"	#12	#12	1.00	90
17	20	1	-	EXTG LAB FLOOR BOX RM 1031 A	3/4"	#12	#12	1.00	90
19	20	1	аран (NEW RECEPT RM 1049Y	3/4"	#12	#12	1.00	90
21	20	1	-	EXTG OHP SCREEN	3/4"	#12	#12	1.00	90
23	20	1	-	NEW RECEPT RM 1049S, 1049Q, 1049P	3/4"	#12	#12	1.00	1,0
25	20	1	-	NEW RECEPT RM 1045	3/4"	#12	#12	1.00	1,4
27	20	1	-	NEW FLOOR BOX RM 1049 RECEPT.	3/4"	#12	#12	1.00	1,0
29	20	1		NEW RECEPT RM 1049R	3/4"	#12	#12	1.00	1,2
31	20	1	-	NEW RECEPT RM 1049X	3/4"	#12	#12	1.00	90
33	20	1		NEW RECEPT RM 1049R	3/4"	#12	#12	1.00	1,2
35	20	1	-	NEW RECEPT RM 1049U, 1049T, 1049S	3/4"	#12	#12	1.00	1,2
37	20	1		NEW RECEPT RM 1051, 1049, 1049R	3/4"	#12	#12	1.00	1,0
39	20	2		EXTG LOAD				1.00	
41	2 .				2 - 2		- 1	1.00	


1. NEW OR MODIFIED CIRCUITS ARE INDICATED IN BOLD.


2. E.C. SHALL PROVIDE UPDATED PANEL SCHEDULE INSIDE PANEL.


ELECTRICAL DETAILS AND SCHEDULES

WORK ORDER & SHEET NO.


K8101 E5.1

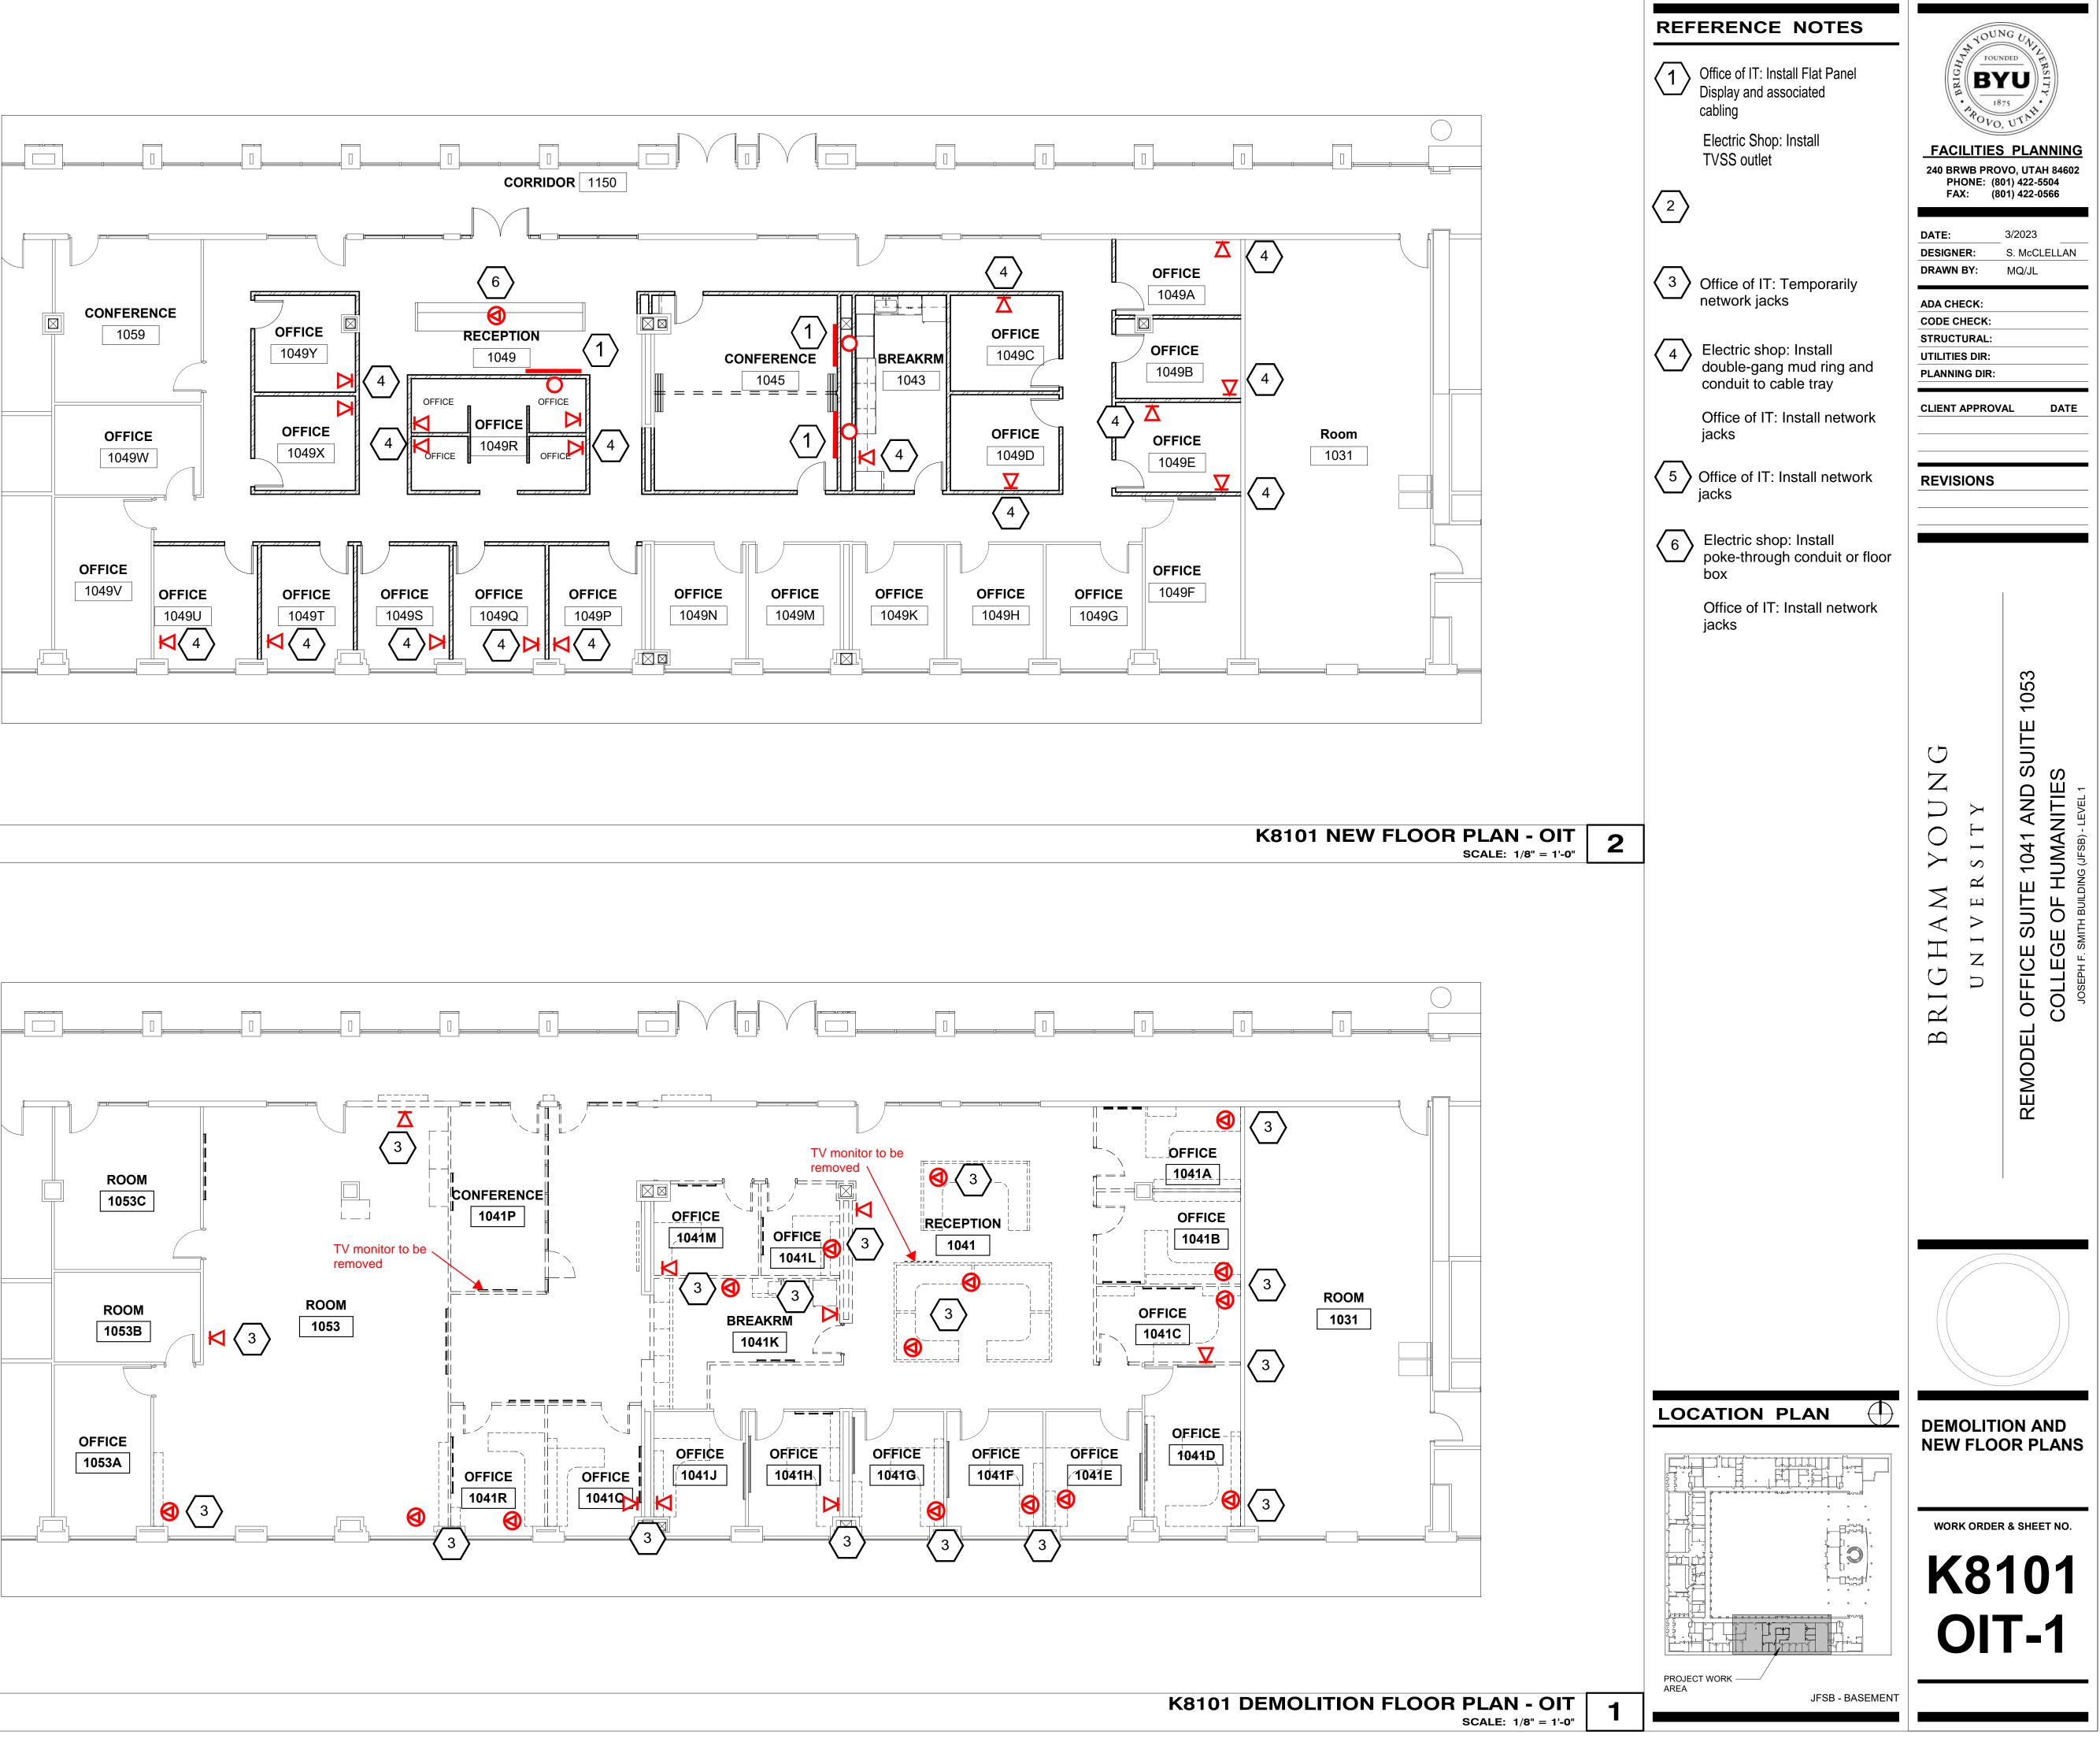

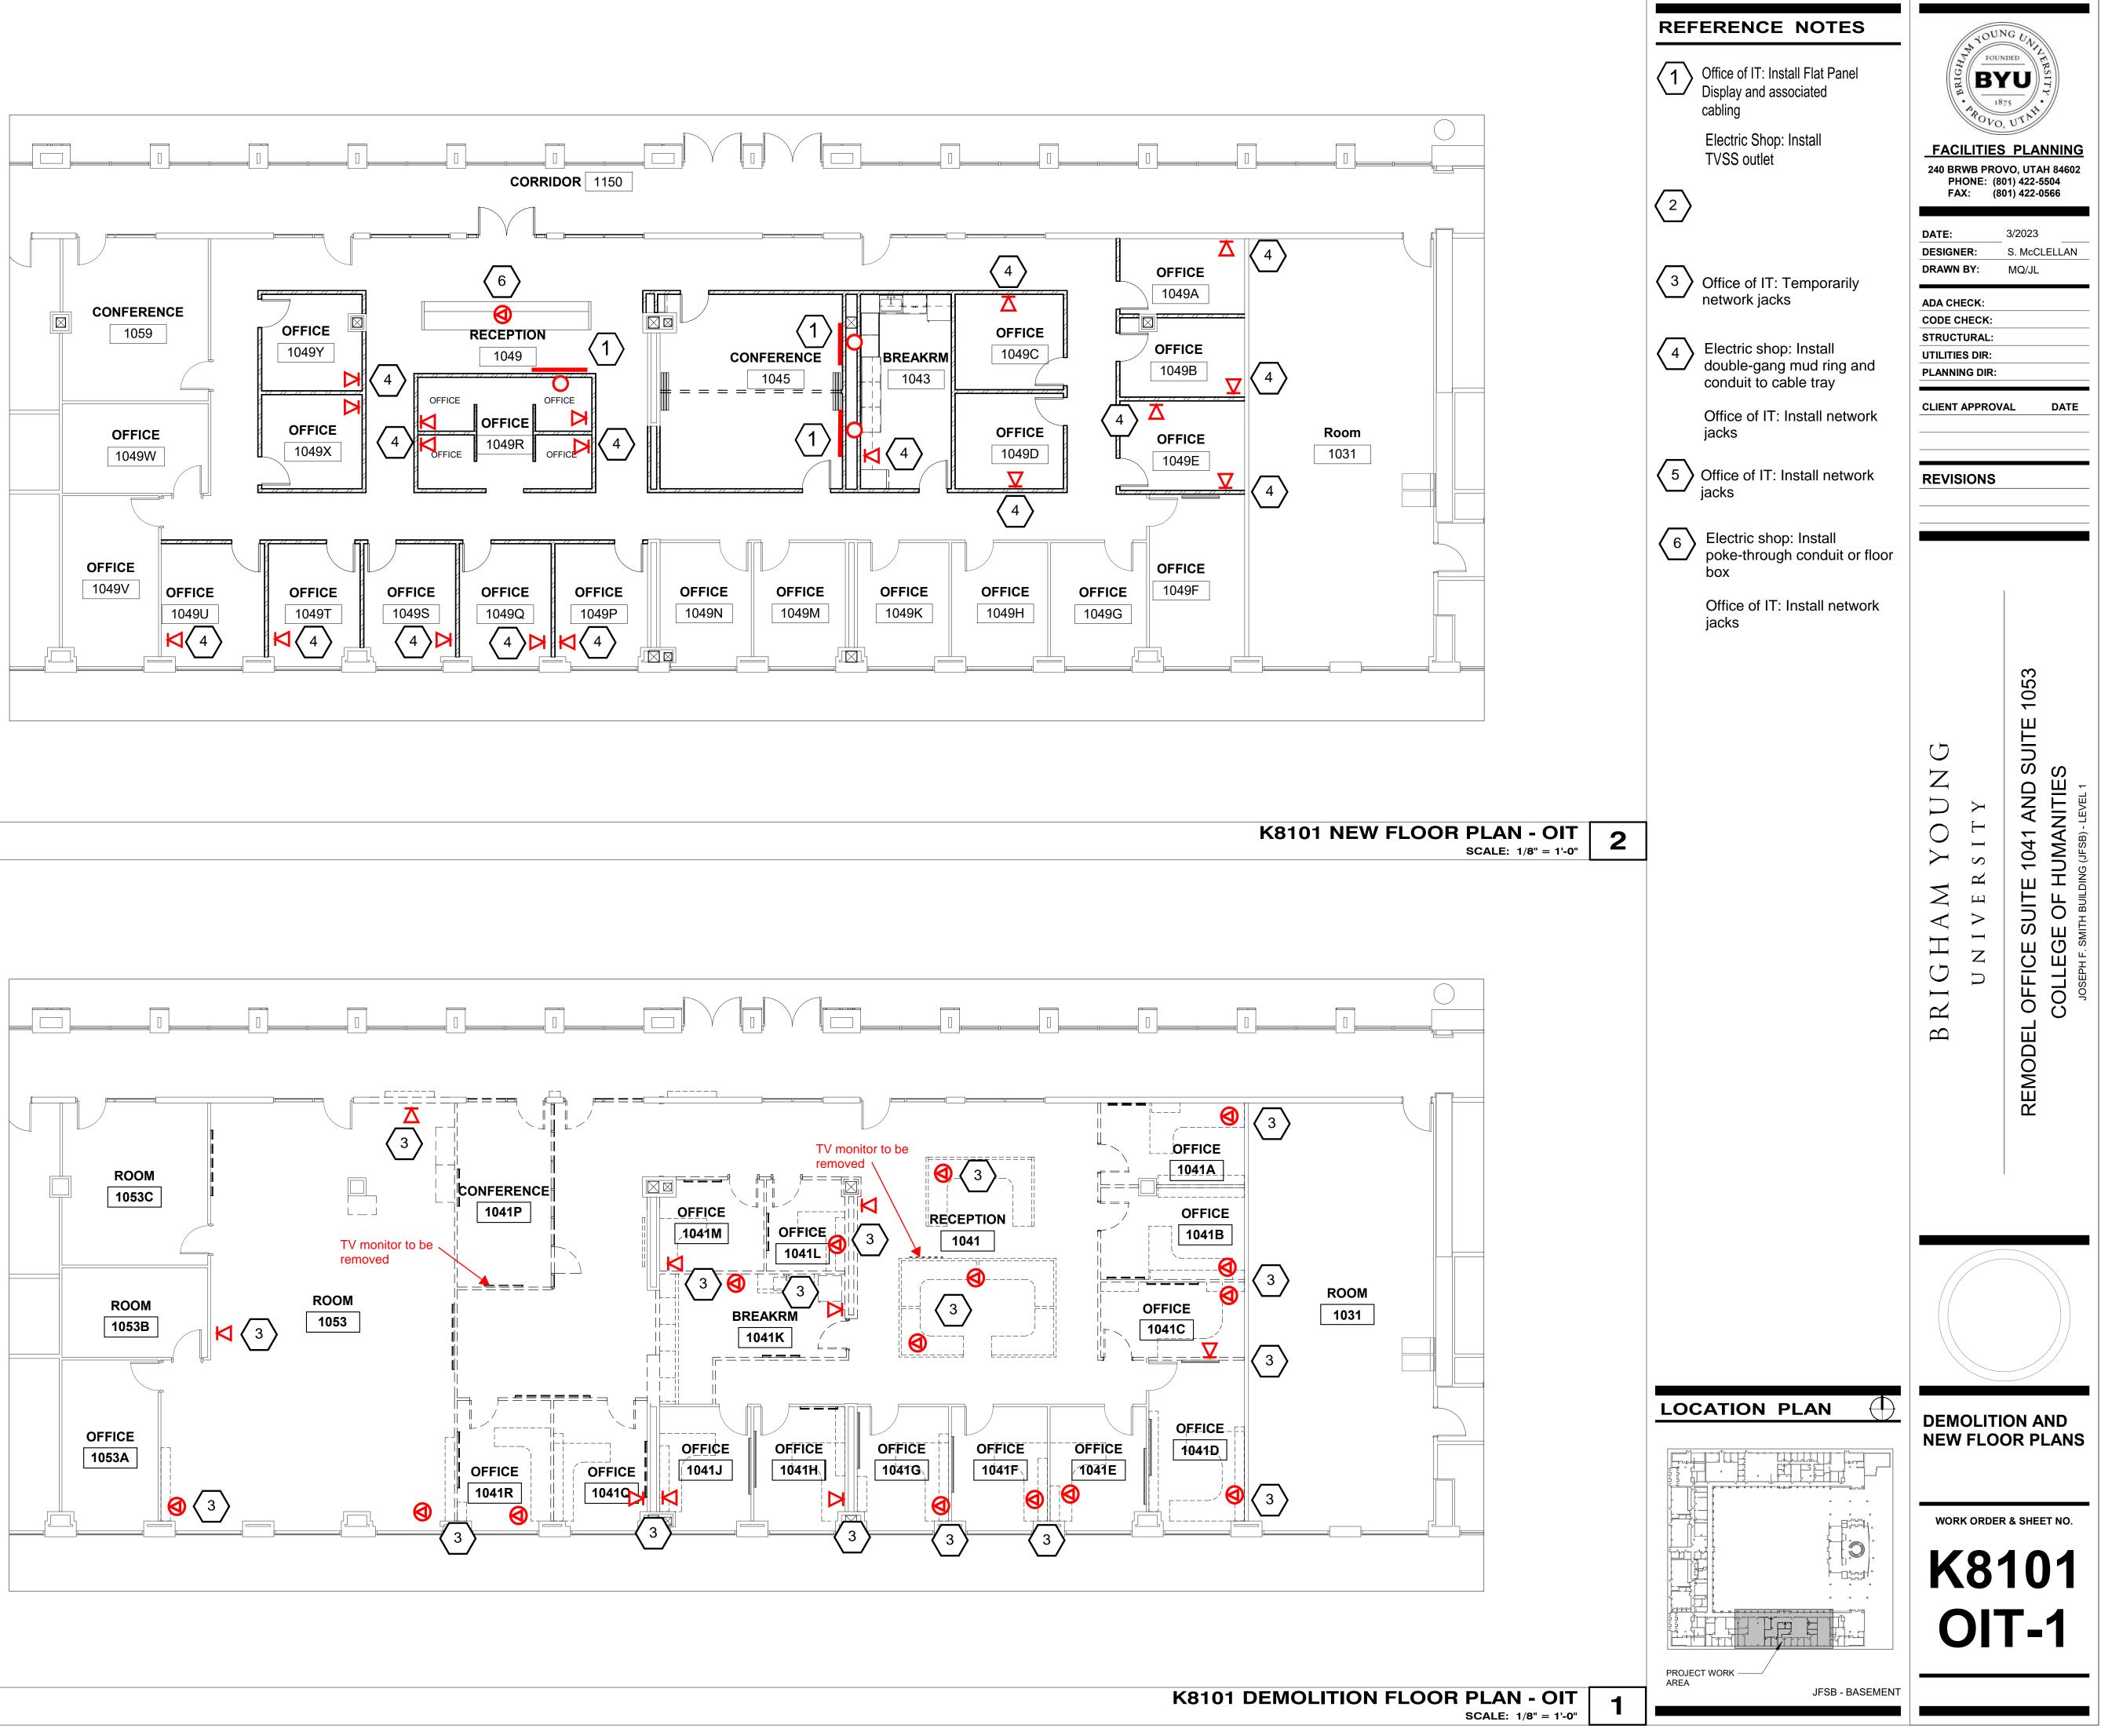

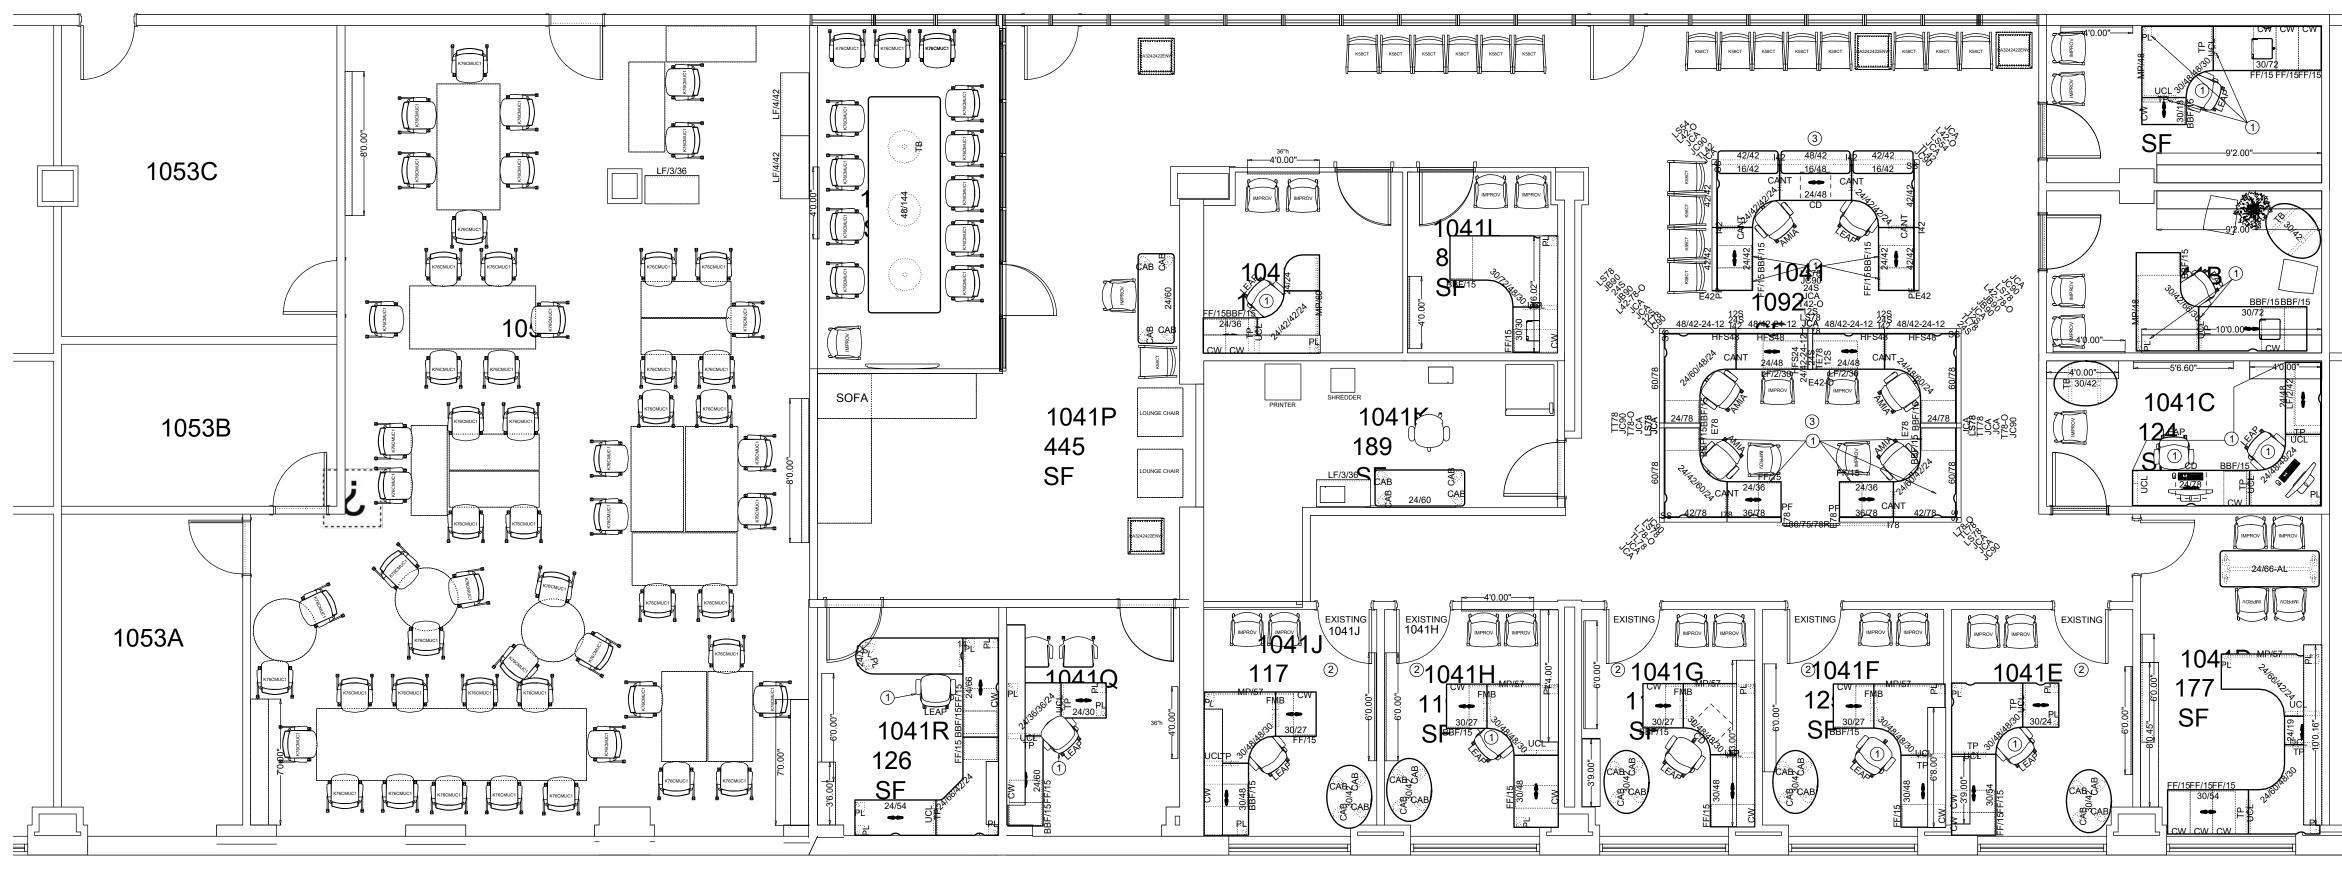

EXISTING LAYOUT

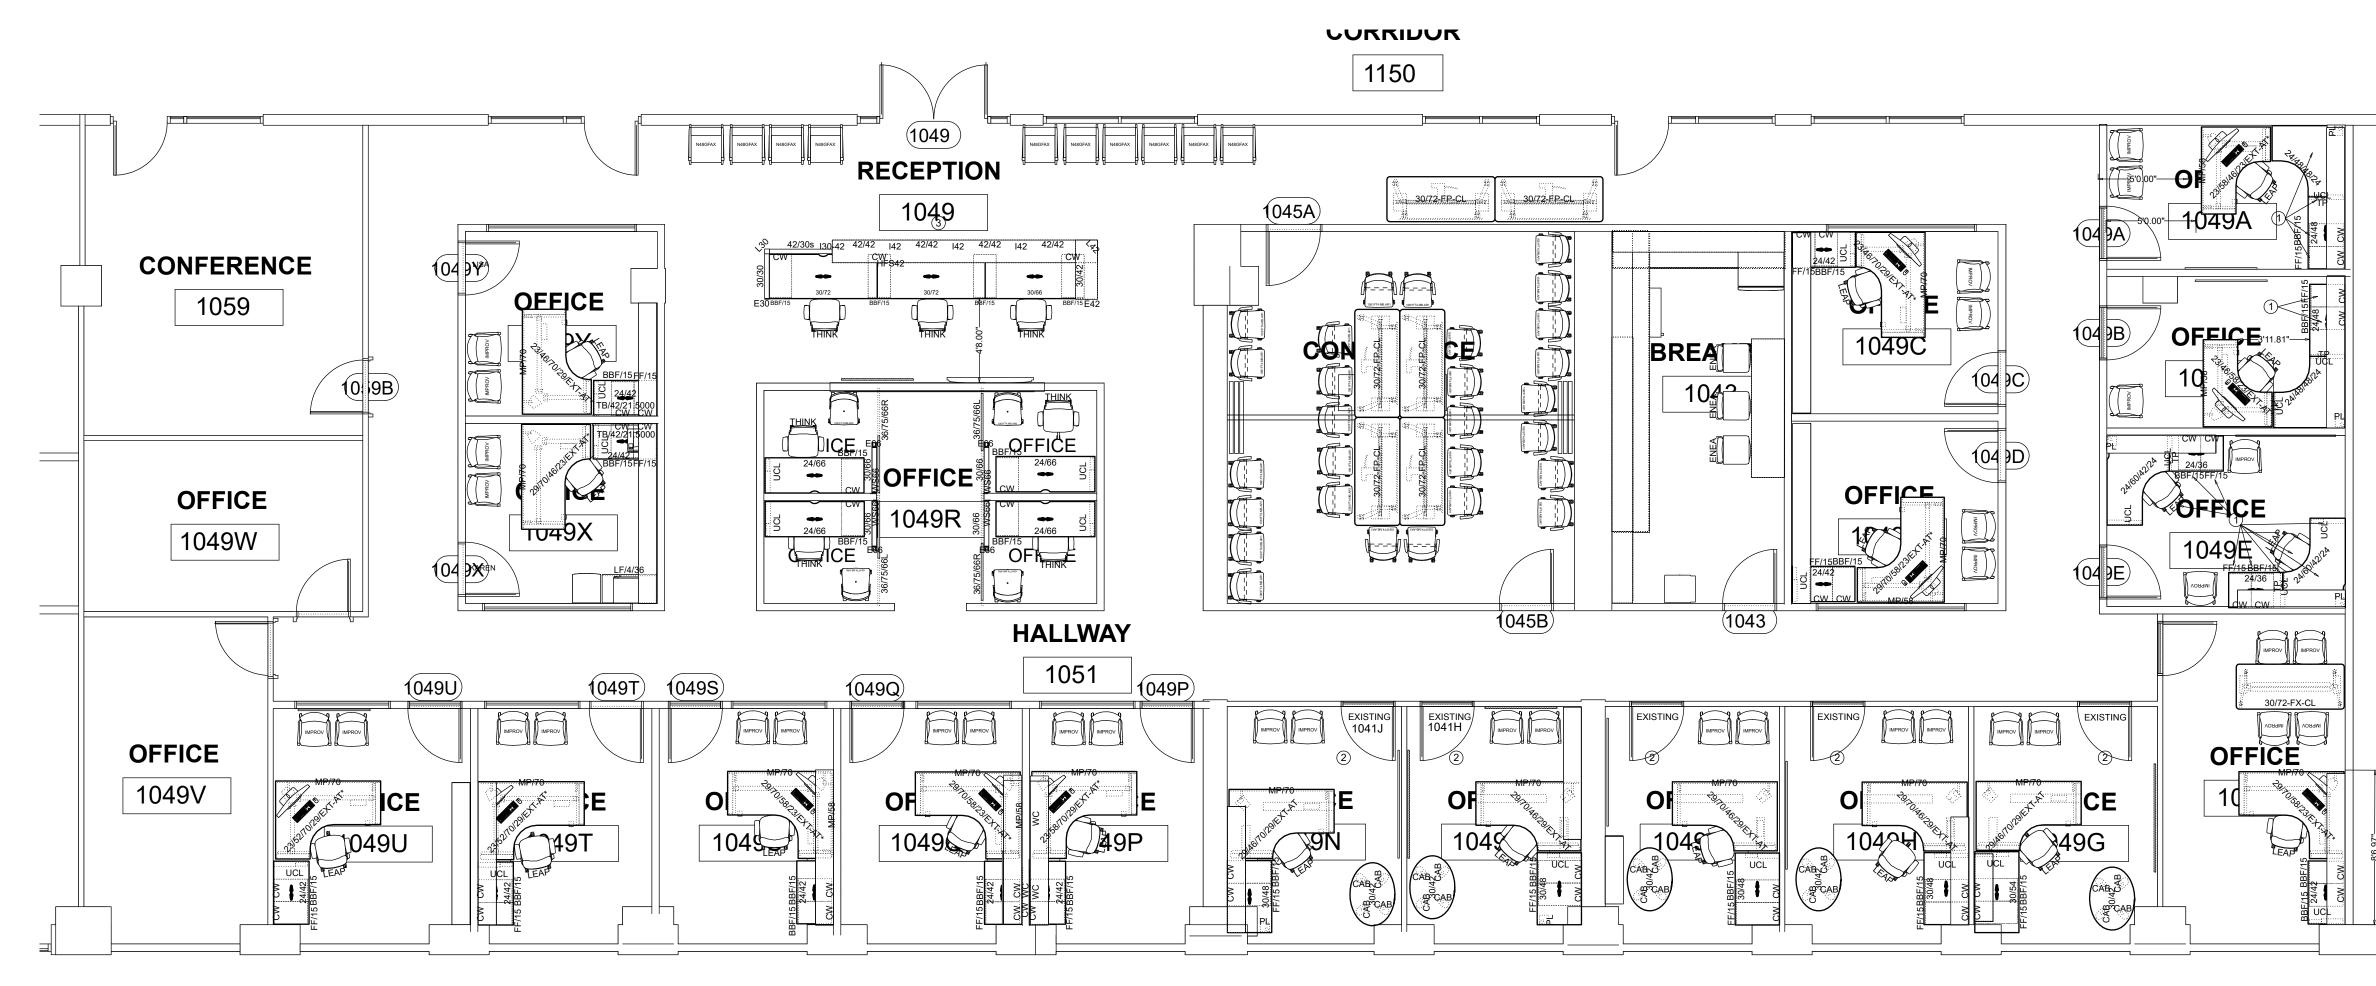

NEW LAYOUT

Scale3/16" = 1'

Scale3/16" = 1'

