# BRIGHAM YOUNG

UNIVERSITY

# REMODEL AUDITORIUMS 151 & 251 PHYSCIAL FACILITIES

N. ELDON TANNER BUILDING (TNRB) - LEVEL 1 & 2

**EGRESS PLAN** 

**ABBREVIATIONS** Floor FLUOR. At Centerline Fluorescent Diameter or Round FURN. Furnish, Furnished GYP. Gypsum Perpendicular HDWD. Hardwood Pound, Number HDWR. Hardware HORIZ. Horizontal Air Conditioning ACOUS Heating Ventilating & A/C Acoustical ADD. Addendum Insulation ADD'L Additional A.F.F. Above Finished Floo Material Maximum Mechanical MANUF Manufacturer Approximate Miscellaneous Not In Contract **Board Feet** Not To Scale BLDG. On Center(s) BLKG. Opening Blocking Open To Structure Chamfer Centerline Plastic Laminate CLG. PLBG. CLR. PLYWD. Clear(ance) Plywood CMU Concrete Masonry Unit Prefabricate COL. PREFIN Prefinished CONC. P.S.F. Concrete Pounds per Square Foot CONSTR Construction Pounds per Square Inch QTY. CONT. Quantity Continuous CONTR. Contractor Radius REQD. Required DEMO. RESIL. Resilient Demolish, Demolition DIA. SPECS. Specifications DIM. Square S.S. STD. DN. Stainless Steel Standard STL. DET. Detail DWG. Typical T.O. Top of VAT. VCT. **ELEC** Vinyl Asbestos Tile Electric(al) ELEV. Elevation Vinyl Composition Tile VERT. Equal **EQUIP** W/O Without Equipment SCHED Schedule

NOTE: SEE OTHER CONSULTANT DRAWINGS FOR ADDITIONAL ABBREVIATION INFORMATION


EXIST.

**APPROVALS** 

Existing

Similar

# Ole M. Smith, Assistant Administrative Vice Pres. -- Physical Facilities Richard Nelson, Managing Director -- Physical Facilities Planning Department

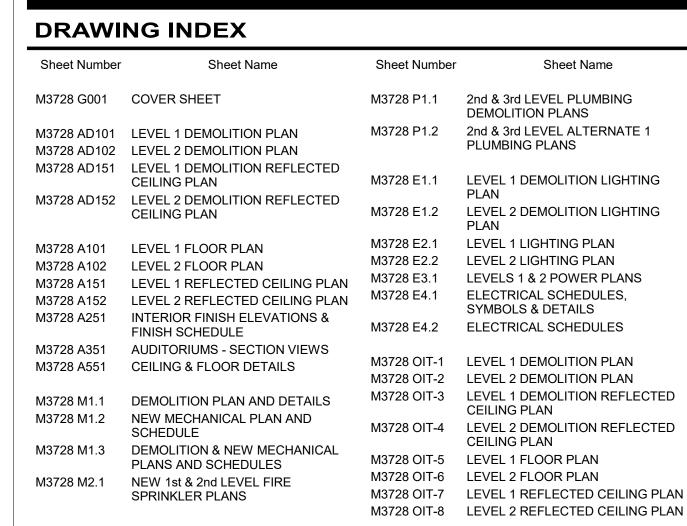


**SYMBOLS LEGEND** 

## **AUTHORITY HAVING JURISDICTION:** EXTERIOR EXIT COMMON PATH OF EGRESS: 58'-5" COMMON PATH OF EGRESS: 67'-9' DISTANCE TO FIRST **DISTANCE TO EXTERIOR EXIT: 154'-5'** DISTANCE TO EXTERIOR FLOOR EXTERIOR EXIT: 176'-6" **EXTERIOR EXIT** DISTANCE TO EXIT ENCLOSURE: 130'-0" **EXTERIOR EXIT** DISTANCE TO EXTERIOR **EXIT ENCLOSURE** EXIT: 88'-6" EXTERIOR EXIT: 143'-0" **LEVEL 1 EGRESS PLAN LEVEL 2 EGRESS PLAN**


## NOT-IN-CONTRACT (NIC) COORDINATION LIST

Not-In-Contract (NIC) Coordination List	Furnished by BYU	Installed by BYU / BYU Vendor	Installed by General Contractor	Furnished by General Contractor
· · ·	рувто	vendor	Contractor	Contractor
General OIT				
Podiums, Equipment Cabinets, with mounting hardware, etc. (power and rough				
electrical In Contract)	x			
Audio / Sound Reinforcement with mounting hardware, etc. (power and rough	Х	Х		
electrical In Contract)	x	x		
Projectors (power and rough electrical for controls In Contract)	X	x		
Projection Screens (power and rough electrical for controls in Contract)	X	_ ^	x	
Projection Screen Boxes, ceiling-recessed	^		×	х
Flat Panel Displays and Digital Signage with mounting hardware (backing, power			_ ×	_ x
and rough electrical in Contract)	x			
and rough electrical in Contract)	Х	Х		
CCTV Cameras with mounting hardware (power and rough electrical In Contract)	v			
Smart Boards and Interactive Marker Boards with mounting hardware (power and	Х	Х		
rough electrical In Contract)	x	x		
Building Directory (power, data, and rough electrical In Contract)				
All AV systems (power and rough electrical in Contract)	X X	X X		
All Data Pathways, Termination Boxes, Cabling, Terminations to Wall Plates and	^	_ ^		
Patch Panels, Warranty			×	×
All Data Racks			×	x
All Cable Trav			X	x
Cable Pass Systems complete, Terminations, Wall Racks, Cable Hangers, Wall Plugs,				^
Intumescent bags (1 per cable pass penetration)			×	х
Wireless Access Points (Power and Data in Contract)	X	х		
Interiors	^	^		
Movable Furniture and Seating	x	х		
Fixed Seating in Auditorium and Meeting Rooms	×	x		
Carpet and Carpet Base, LVT, Rubber Base	X	X		
Systems	^	^		
Mechanical Controls Hardware (both system and terminal units) by Atkinson or				
Johnson Controls	x		x	
Mechanical Controls Raceway			×	х
Mechanical Controls Programming (Software - both system and terminal units) by			<u> </u>	<u> </u>
, , , , , , , , , , , , , , , , , , , ,	×	l ,		
	^	^		
, ·	Y			
Atkinson or Johnson Controls  Project Specific  Moving Existing Equipment  Revision Date: 2-23-22	x	X		

#### PROJECT LOCATION PLAN

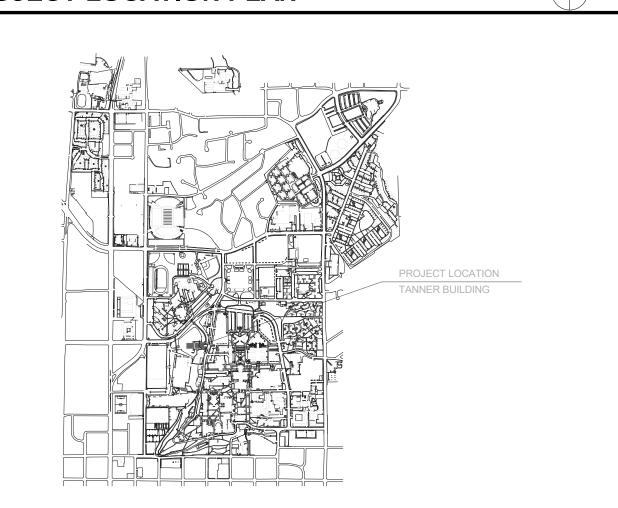

#### **GENERAL NOTES**

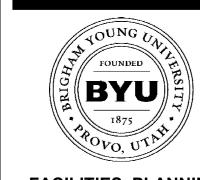

**240 BRWB PROVO, UTAH 84602** PHONE: (801) 422-5504 FAX: (801) 422-0566

DATE:	03/14/24	
DESIGNER:	SW	
DRAWN BY:	SW	

ADA CHECK: CODE CHECK: STRUCTURAL: **ENGINEERING:** 

**CLIENT APPROVAL** 

PLANNING DIR:

**REVISIONS** 

2

**CODE COMPLIANCE** 

ACCORDING TO THE LATEST EDITION OF TH FOLLOWING STANDARDS & AMENDMENTS TO THOSE STANDARDS AS ADOPTED BY THE

2021 IBC (International Building Code) 2021 IEBC (International Existing Building Code) 2021 IFC (International Fire Code) 2020 NEC (National Electrical Code) 2021 IECC (International Energy Conservation Code) 2021 IFGC (International Fuel Gas Code) NEMA (National Electrical Manufacturer's Assoc.) 2021 IMC (International Mechanical Code) 2021 IPC (International Plumbing Code) 1997 Uniform Code for Building Conservation NFPA (National Fire Protection Association) UL (Underwriters Laboratories, Inc.)

State & Local Building Authority & Codes Section 305 New Group:

Section 601 New Type: IEBC ALTERATION LEVEL

OCCUPANT LOAD (Work Area): (1) occupant per fixed seat New Load:

(1) occupant per 150 sqft. Exist. Load: (1) occupant per fixed seat Exist. Load: 182 New Load: Exist. Load:

New Load: Exist. Load: TOTALS: New Load:

BUILDING SQFT, LEVEL 1 & 2: 82,910 sqft. **WORK AREA SQFT** 5200 sqft. FIRE PROTECTION: Fully sprinkled


Section 903 Unchanged REQUIRED PLBG. FIXTURES: Unchanged

#### PROJECT DIRECTORY

1. BYU Planning PM: Stanton Woods 801-422-5695 stanton\_woods@byu.edu

2. BYU Building Code Analyst: Keith Martin 801 422-5571 keith\_martin@byu.edu


3. Please CC project correspondence to the Tony Burdette anthony\_burdette@byu.edu Bob Coleman robert\_coleman@byu.edu

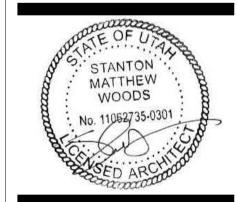

**COVER SHEET** 

**WORK ORDER & SHEET NO.** 

M3728

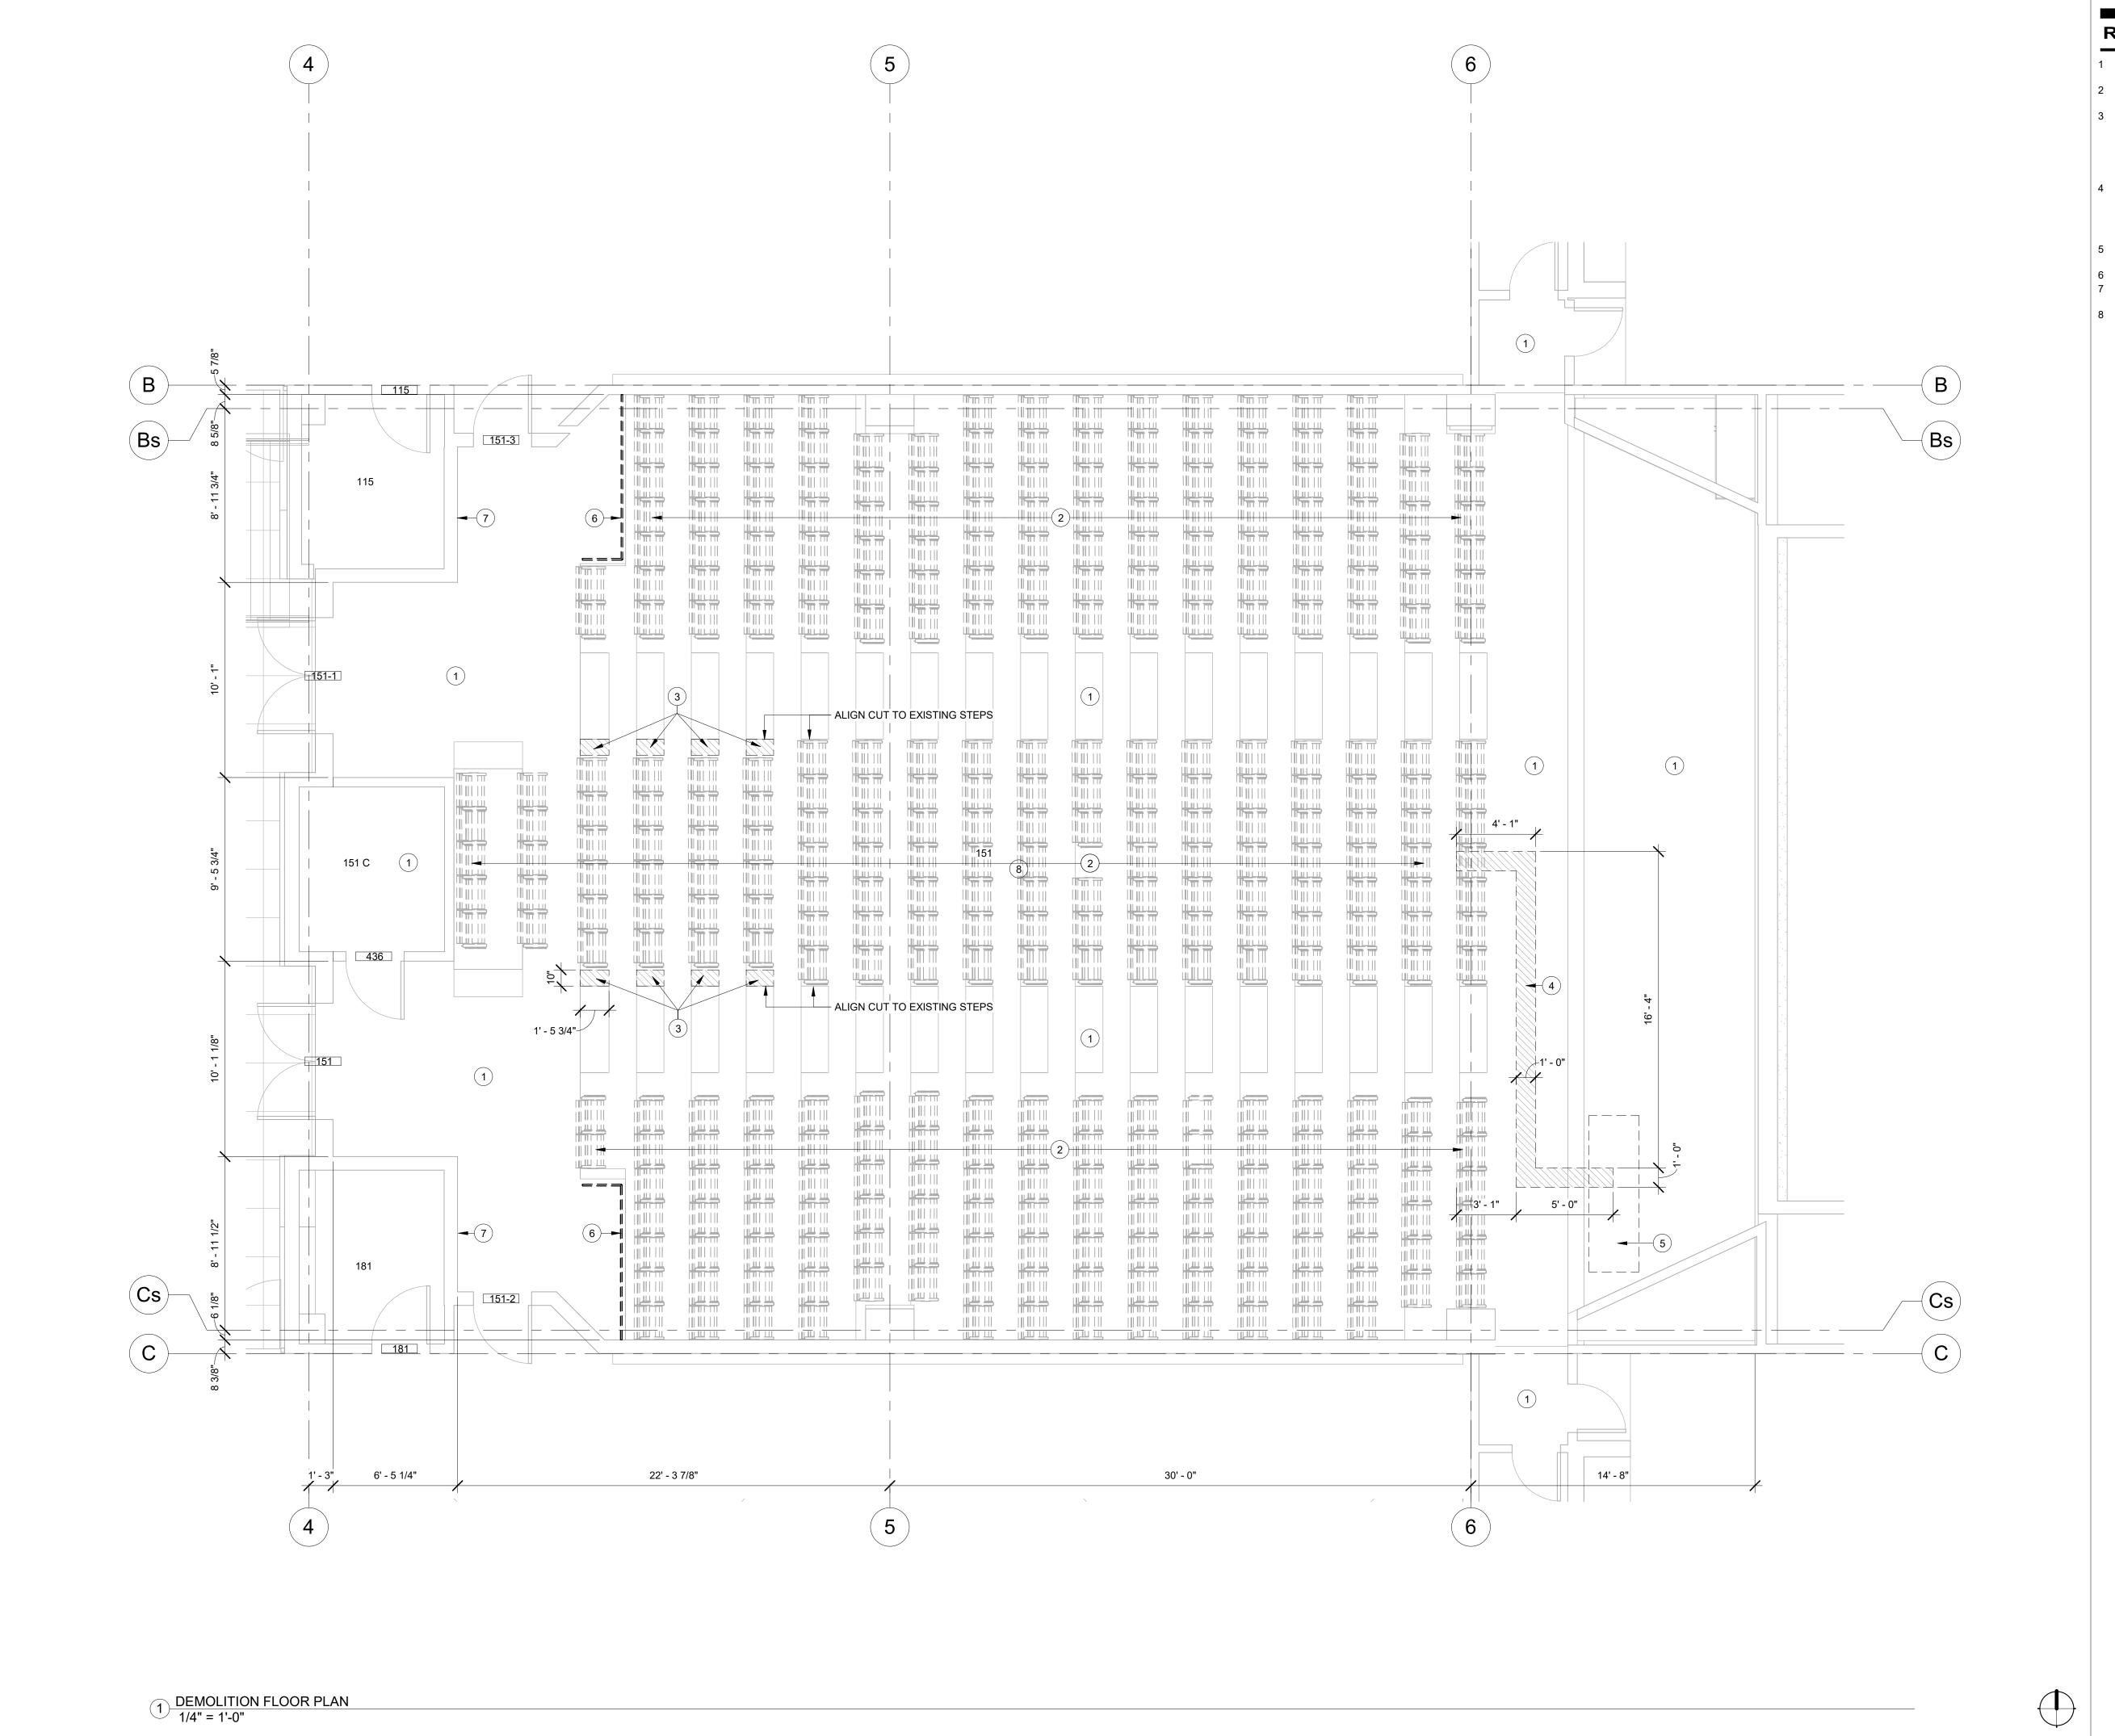

- 1 CONTRACTOR TO REMOVE & DISPOSE OF
- EXISTING CARPET
- CONTRACTOR TO REMOVE & DISPOSE OF EXISTING FIXED THEATER SEATING
- 3 SAWCUT & DEMO SECTION OF CONCRETE STEP. STEPS TO BE THE SAME WIDTH AS LOWER STEPS IN AISLE. SMOOTH/PATCH/GRIND DEMO AREA AS NEEDED TO PROVIDE ACCEPTABLE CARPET
- SUBSTRATE 4 SAWCUT & DEMO SECTION OF CONCRETE FLOOR & STEPS FOR NEW POWER & DATA CONDUITS. SEE ELECTRICAL AND OIT PLANS FOR CONDUIT SIZING, CONNECTIONS, AND TERMINATIONS. FILL IN WITH NEW CONCRETE
- 5 EXISTING PODIUM & TABLE TO BE REMOVED BY OWNER PRIOR TO DEMOLITION
- 6 REMOVE EXISTING ALUMINUM RAILING 7 REMOVE EXISTING ACOUSTIC PANEL, PATCH & PAINT WALL

BYU

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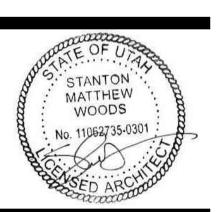
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**CLIENT APPROVAL** 


**REVISIONS** 

2



LEVEL 1 **DEMOLITION PLAN** 

WORK ORDER & SHEET NO.

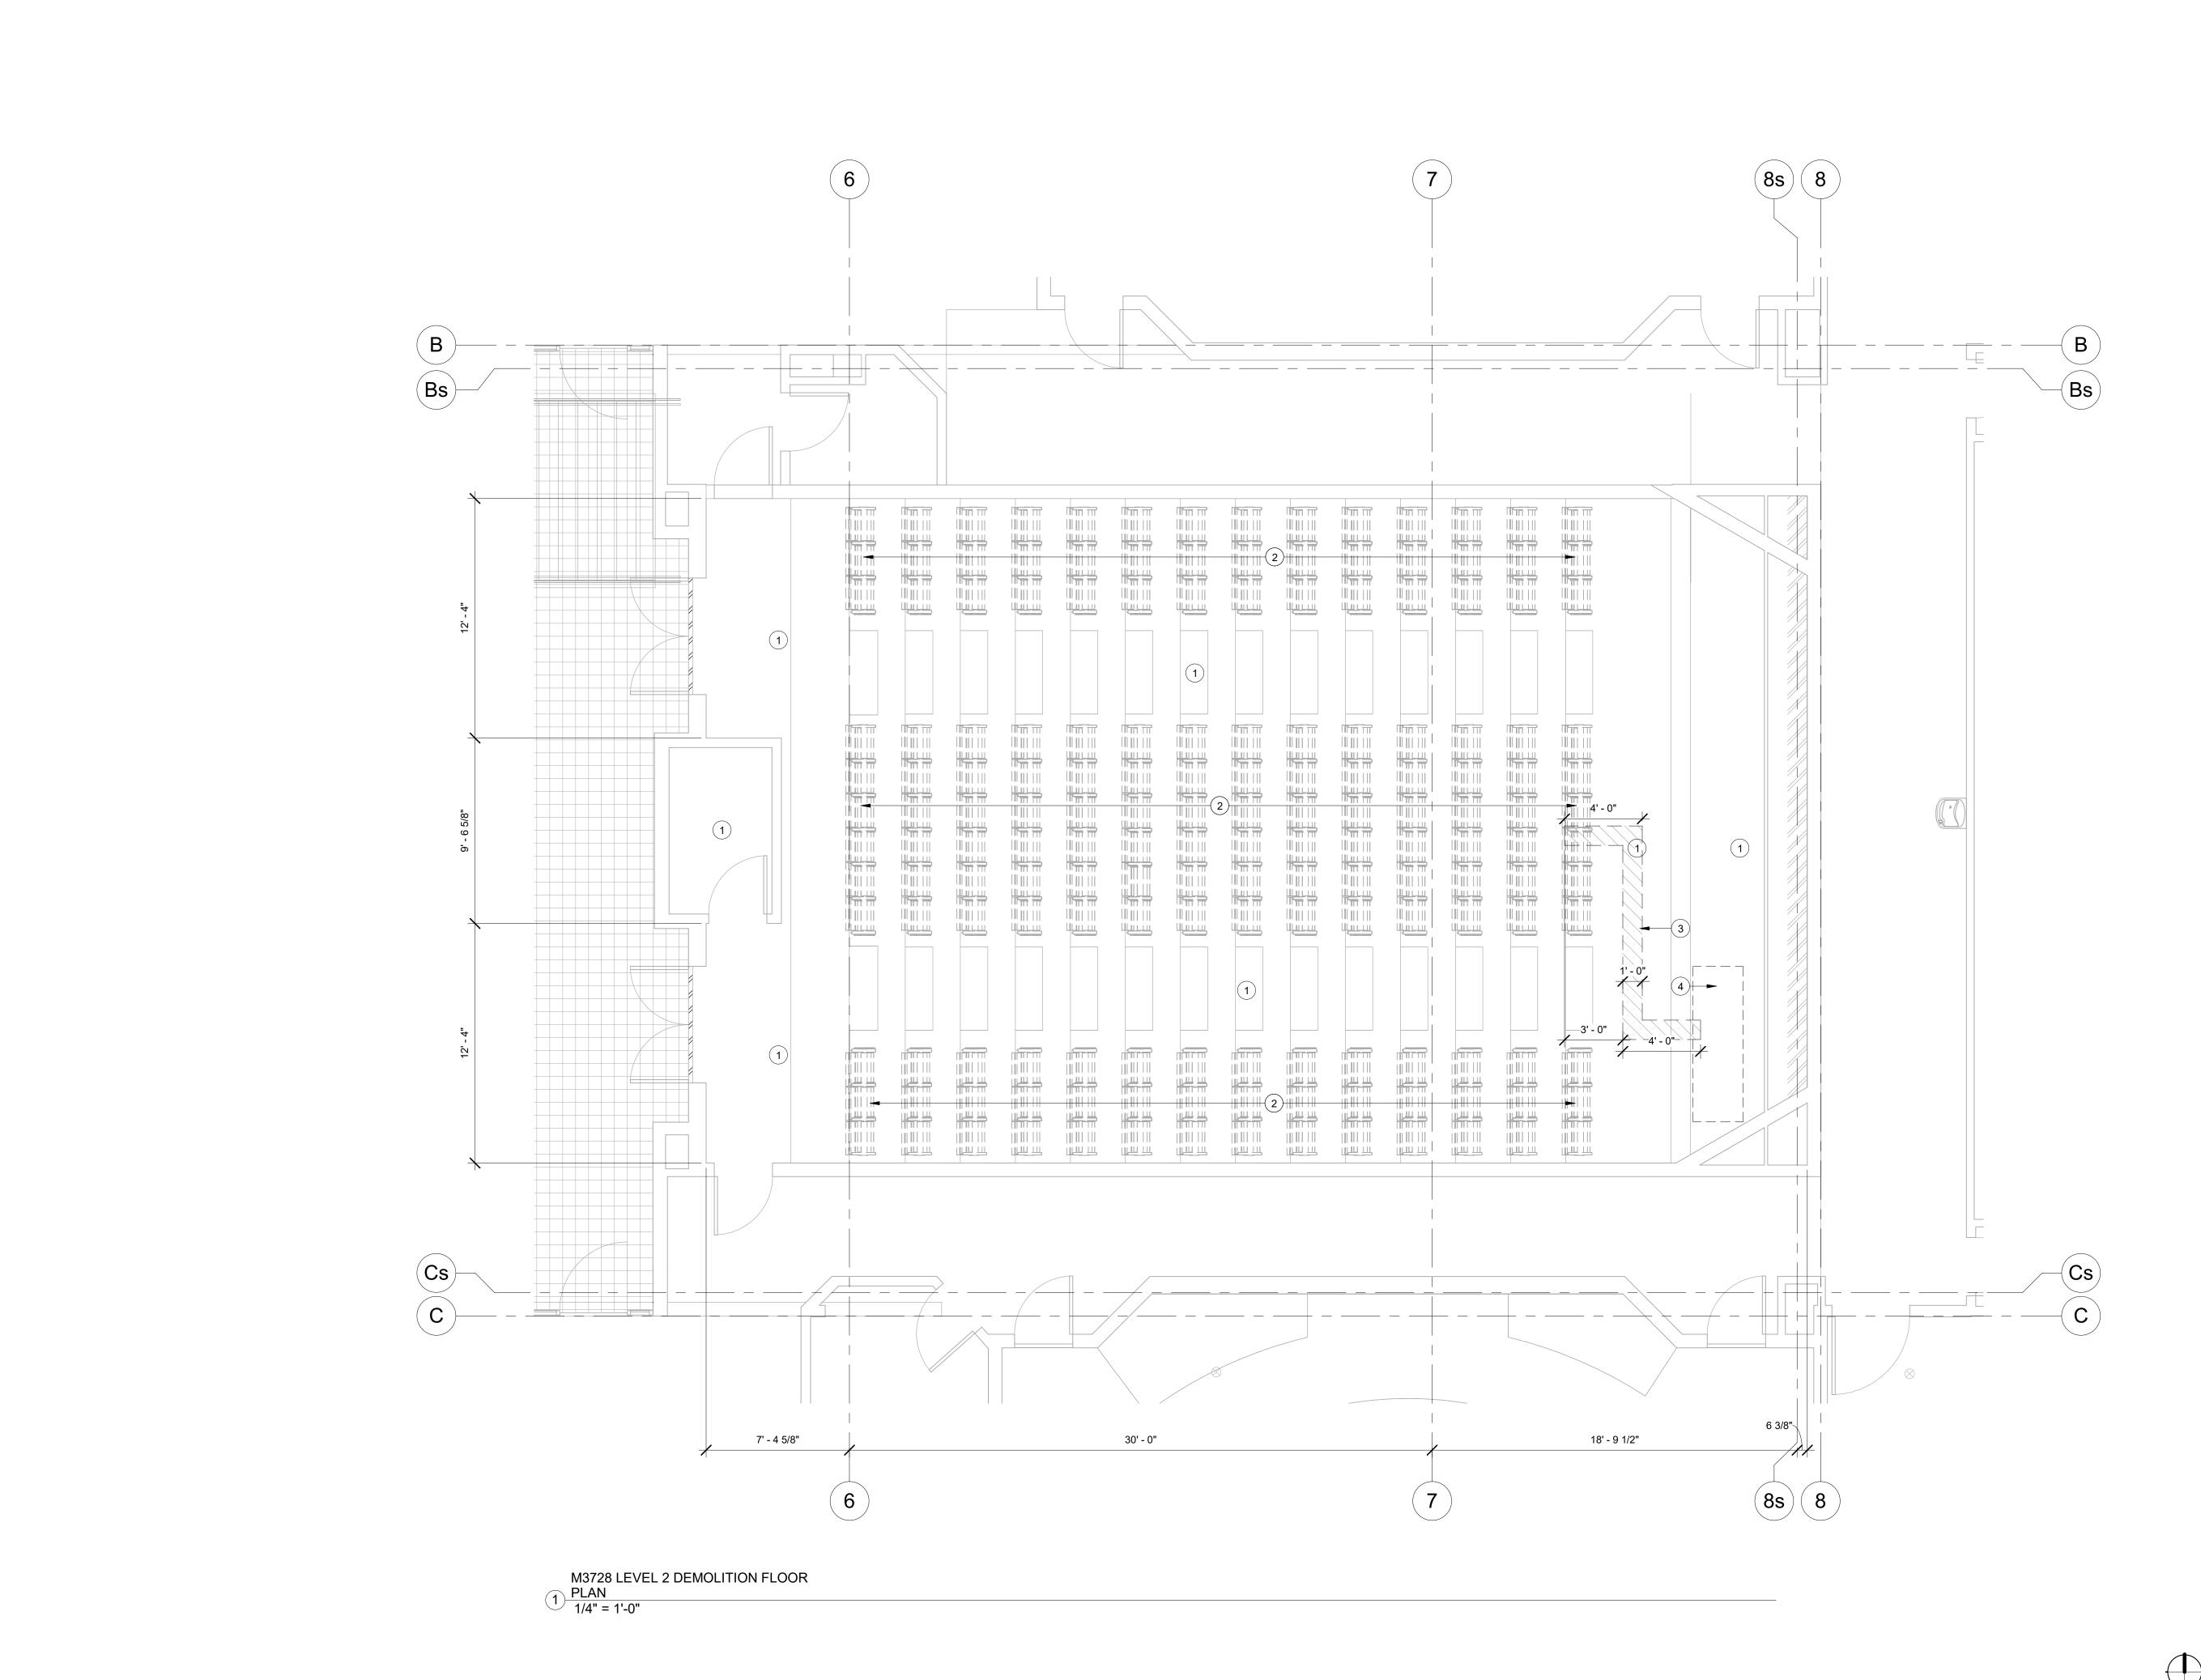

- 1 CONTRACTOR TO REMOVE & DISPOSE OF
- EXISTING CARPET
- 2 CONTRACTOR TO REMOVE & DISPOSE OF EXISTING FIXED THEATER SEATING 3 SAWCUT & DEMO SECTION OF CONCRETE
- FLOOR & STEPS FOR NEW POWER & DATA CONDUITS. SEE ELECTRICAL AND OIT PLANS FOR CONDUIT SIZING, CONNECTIONS, AND
- TERMINATIONS. FILL IN WITH NEW CONCRETE 4 EXISTING PODIUM & TABLE TO BE REMOVED BY OWNER PRIOR TO DEMOLITION



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DESIGNER:	SW
DAMN DV.	CW


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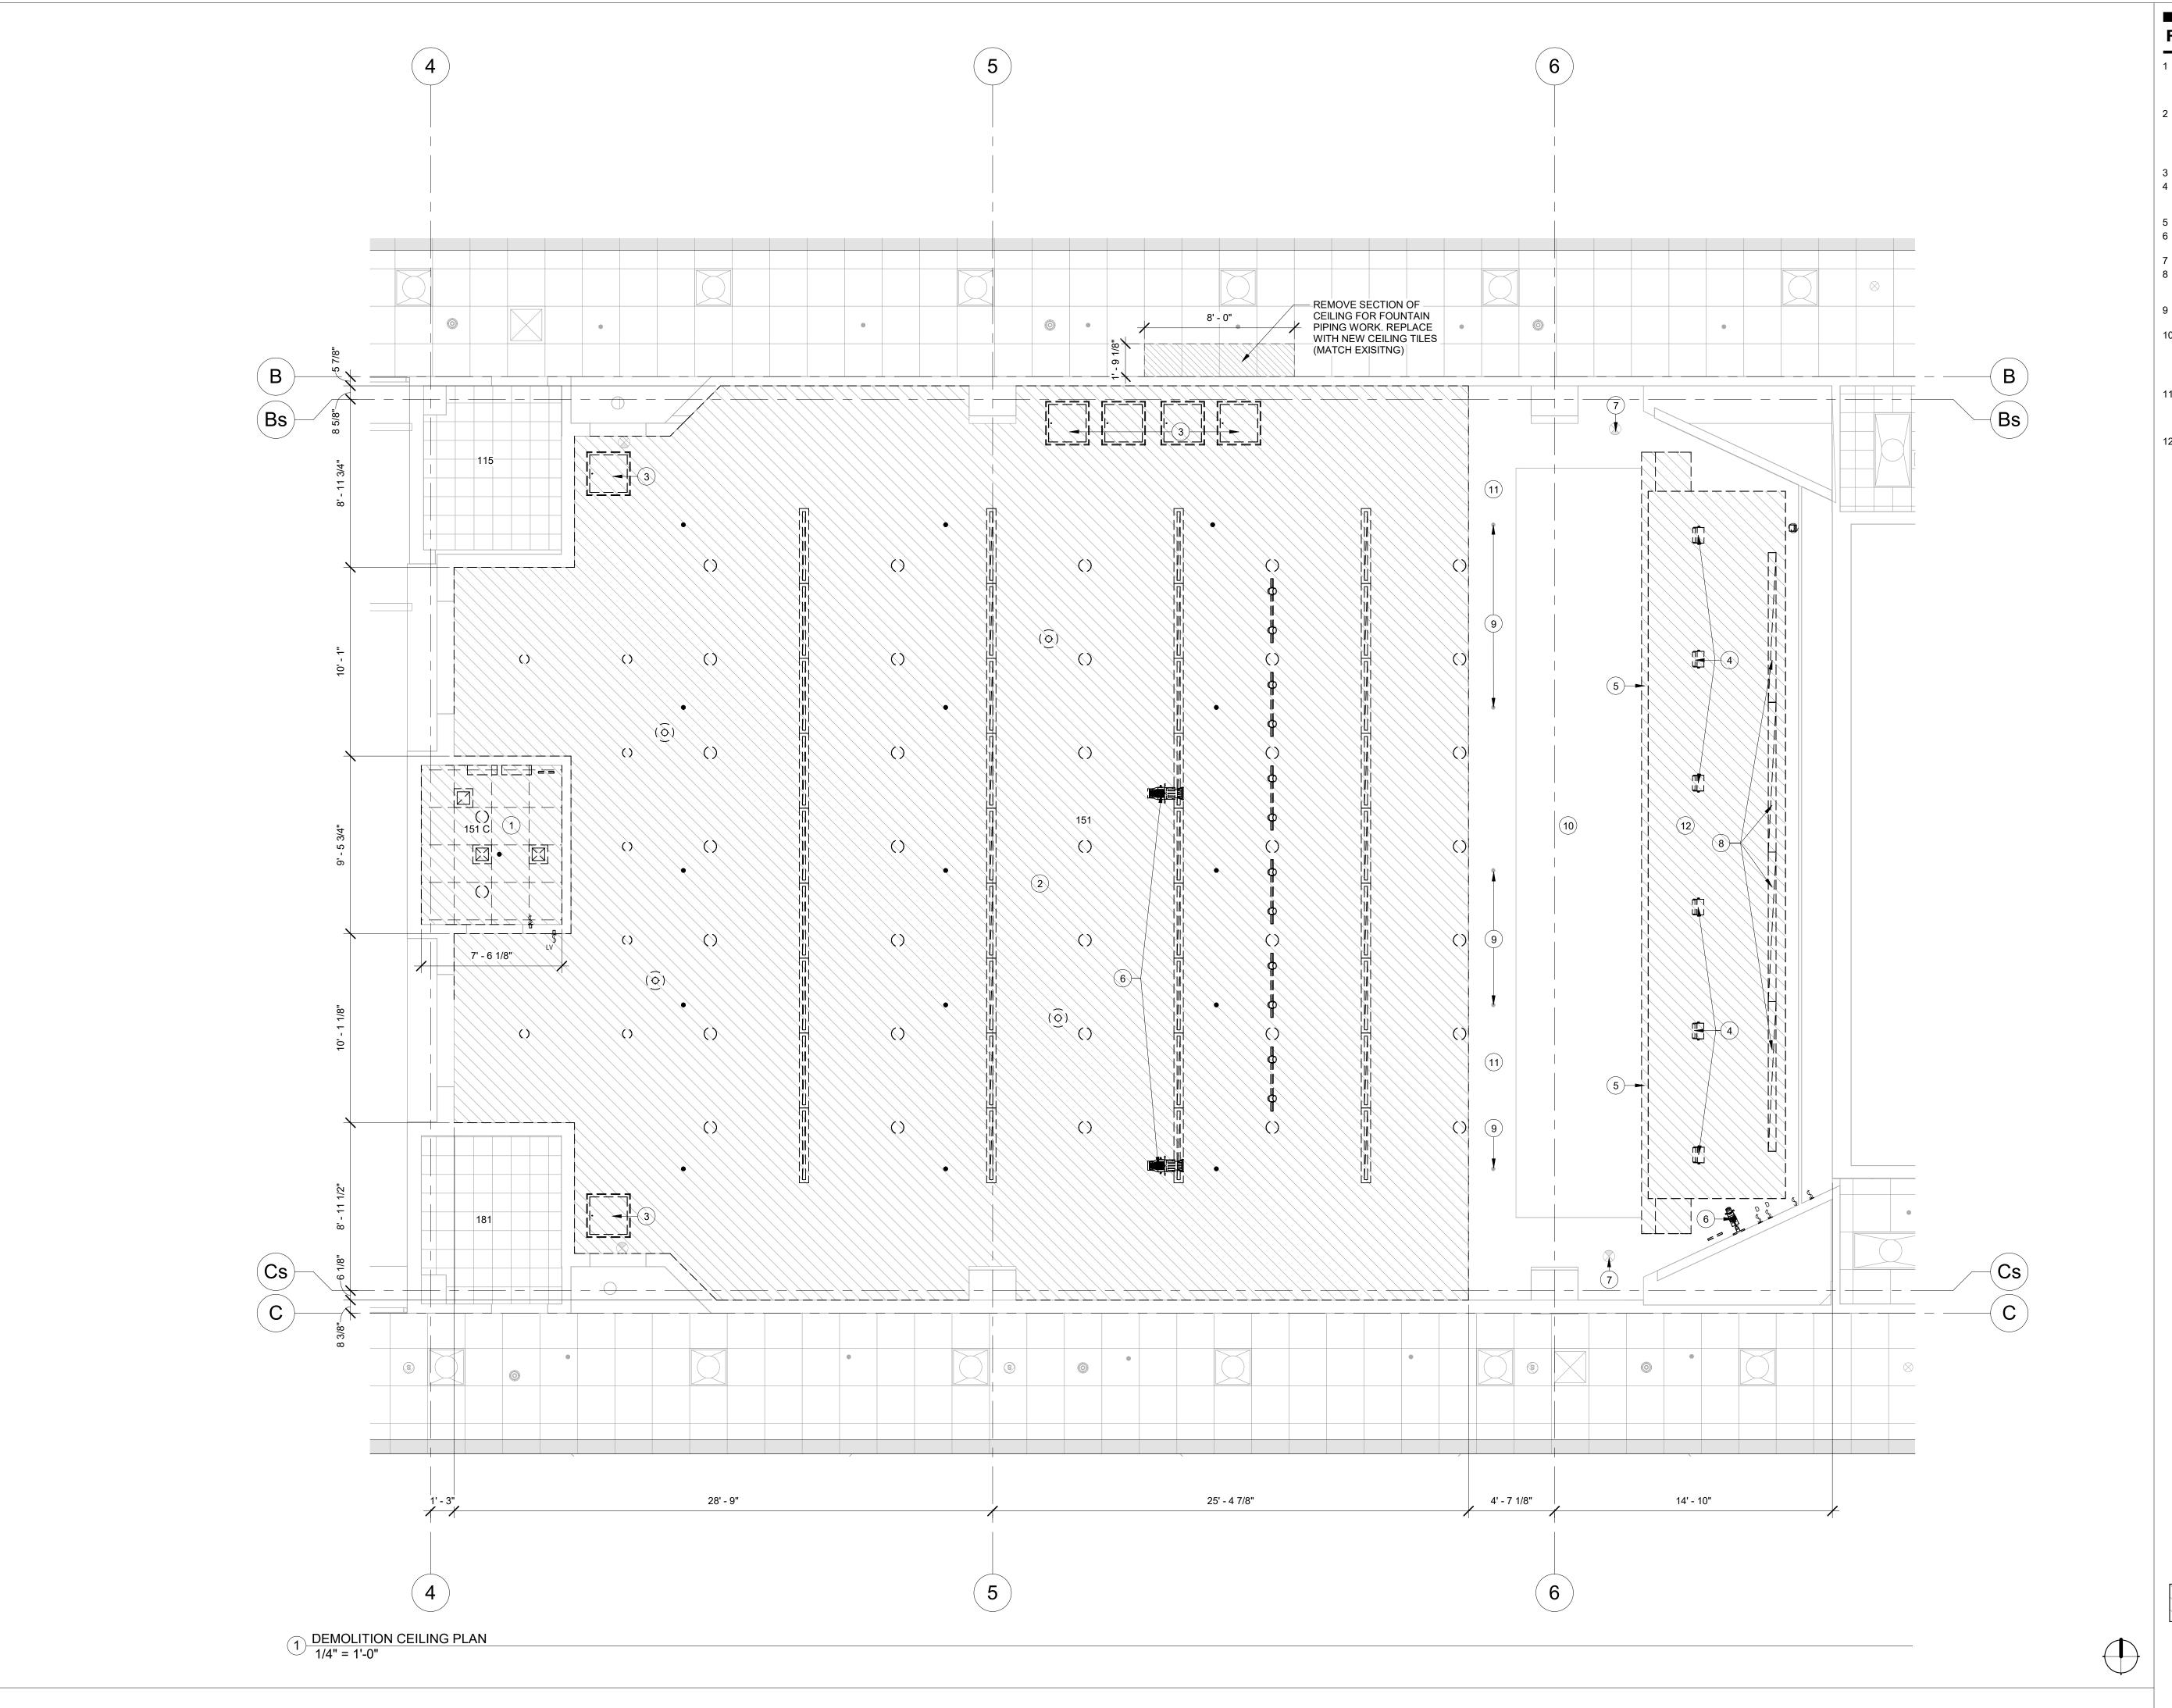
**REVISIONS** 

2



LEVEL 2 **DEMOLITION PLAN** 

WORK ORDER & SHEET NO.

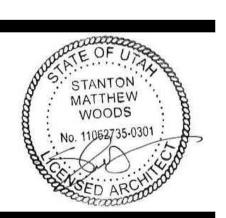

- 1 DEMO EXISTING ACT CEILING, INCLUDING LIGHTING, HVAC GRILLES. FIRE SPRINKLER SYSTEM TO REMAIN AND INSTALL NEW HEADS W/ FLEX CONNECTOR (SEE PLUMBING PLAN) 2 DEMO EXISTING GYPSUM BOARD CEILING, INCLUDING LIGHTING, HVAC GRILLES. FIRE SPRINKLER SYSTEM TO REMAIN AND INSTALL
- NEW HEADS W/ FLEX CONNECTOR (SEE PLUMBING PLAN) 3 CEILING ACCESS DOORS TO BE REMOVED 4 BYU OIT CREWS TO REMOVE SURFACE
- MOUNTED SPEAKERS, USING CONTRACTOR PROVIDED SCAFFOLDING 5 REMOVE EXISTING SPEAKER ARRAY
- 6 REMOVE EXISTING STAGE LIGHTING. BYU TO SURPLUS 7 EXISTING LIGHT FIXTURE TO REMAIN
- 8 REMOVE/DEMO SURFACE MOUNTED LINEAR LIGHT FIXTURE. REFER TO ELECTRICAL DEMO
- 9 EXISTING FIRE SPRINKLER SYSTEM WITHIN SLOPED CEILING TO REMAIN AS-IS
- 10 EXISTING UPPER GYPSUM BOARD CEILING CLOUD TO REMAIN IN PLACE. PATCH AND REPAIR ANY EXISTING & NEW DAMAGE. PAINT ENTIRE CLOUD, SEE FINISH SCHEDULE FOR PAINT COLOR
- 11 EXISTING SLOPED SECTION OF CEILING TO REMAIN. PATCH AND REPAIR ANY EXISTING & NEW DAMAGE. PAINT ENTIRE CEILING, SEE FINISH SCHEDULE FOR PAINT COLOR
- 12 MODIFY EXISTING GYPSUM BOARD CEILING CLOUD. CUT OUT MIDDLE SECTION FOR NEW OVERHEAD PROJECTOR. PATCH & REPAIR ALL SIDES AND CORNERS. MODIFY EXISTING SUPPORTS TO INSTALL CLOUDS TO HEIGHT SHOWN ON SHEET A351. SLOPE OF CLOUD TO REMAIN THE SAME. PATCH AND REPAIR CLOUD ONCE IN FINAL RAISED POSITION. SEE FINISH SCHEDULE FOR PAINT COLOR



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**UTILITIES DIR:** 

**REVISIONS** 

2

WOODS

CONTRACTOR TO PROVIDE & INSTALL SCAFFOLDING AND 'DANCE FLOOR' TYPE WORKING PLATFORM FOR DEMOLITION AND NEW CONSTRUCTION.

CONTRACTOR TO PROVIDE ACCESS TO BYU OIT INSTALLERS TO REMOVE EXISTING OIT ITEMS SUCH AS SPEAKERS, PROJECTORS, DISPLAYS ETC.


CONTRACTOR TO ALSO PROVIDE ACCESS TO BYU OIT INSTALLERS TO INSTALL NEW OIT SPEAKERS, PROJECTORS, ETC. THIS IS TO HAPPEN BEFORE SCAFFOLDING IS TAKEN DOWN.

DIAGONAL HATCH AREA INDICATES SECTION OF CEILING TO BE REMOVED OR ALTERED

LEVEL 1 **DEMOLITION** REFLECTED

**CEILING PLAN** 

WORK ORDER & SHEET NO.

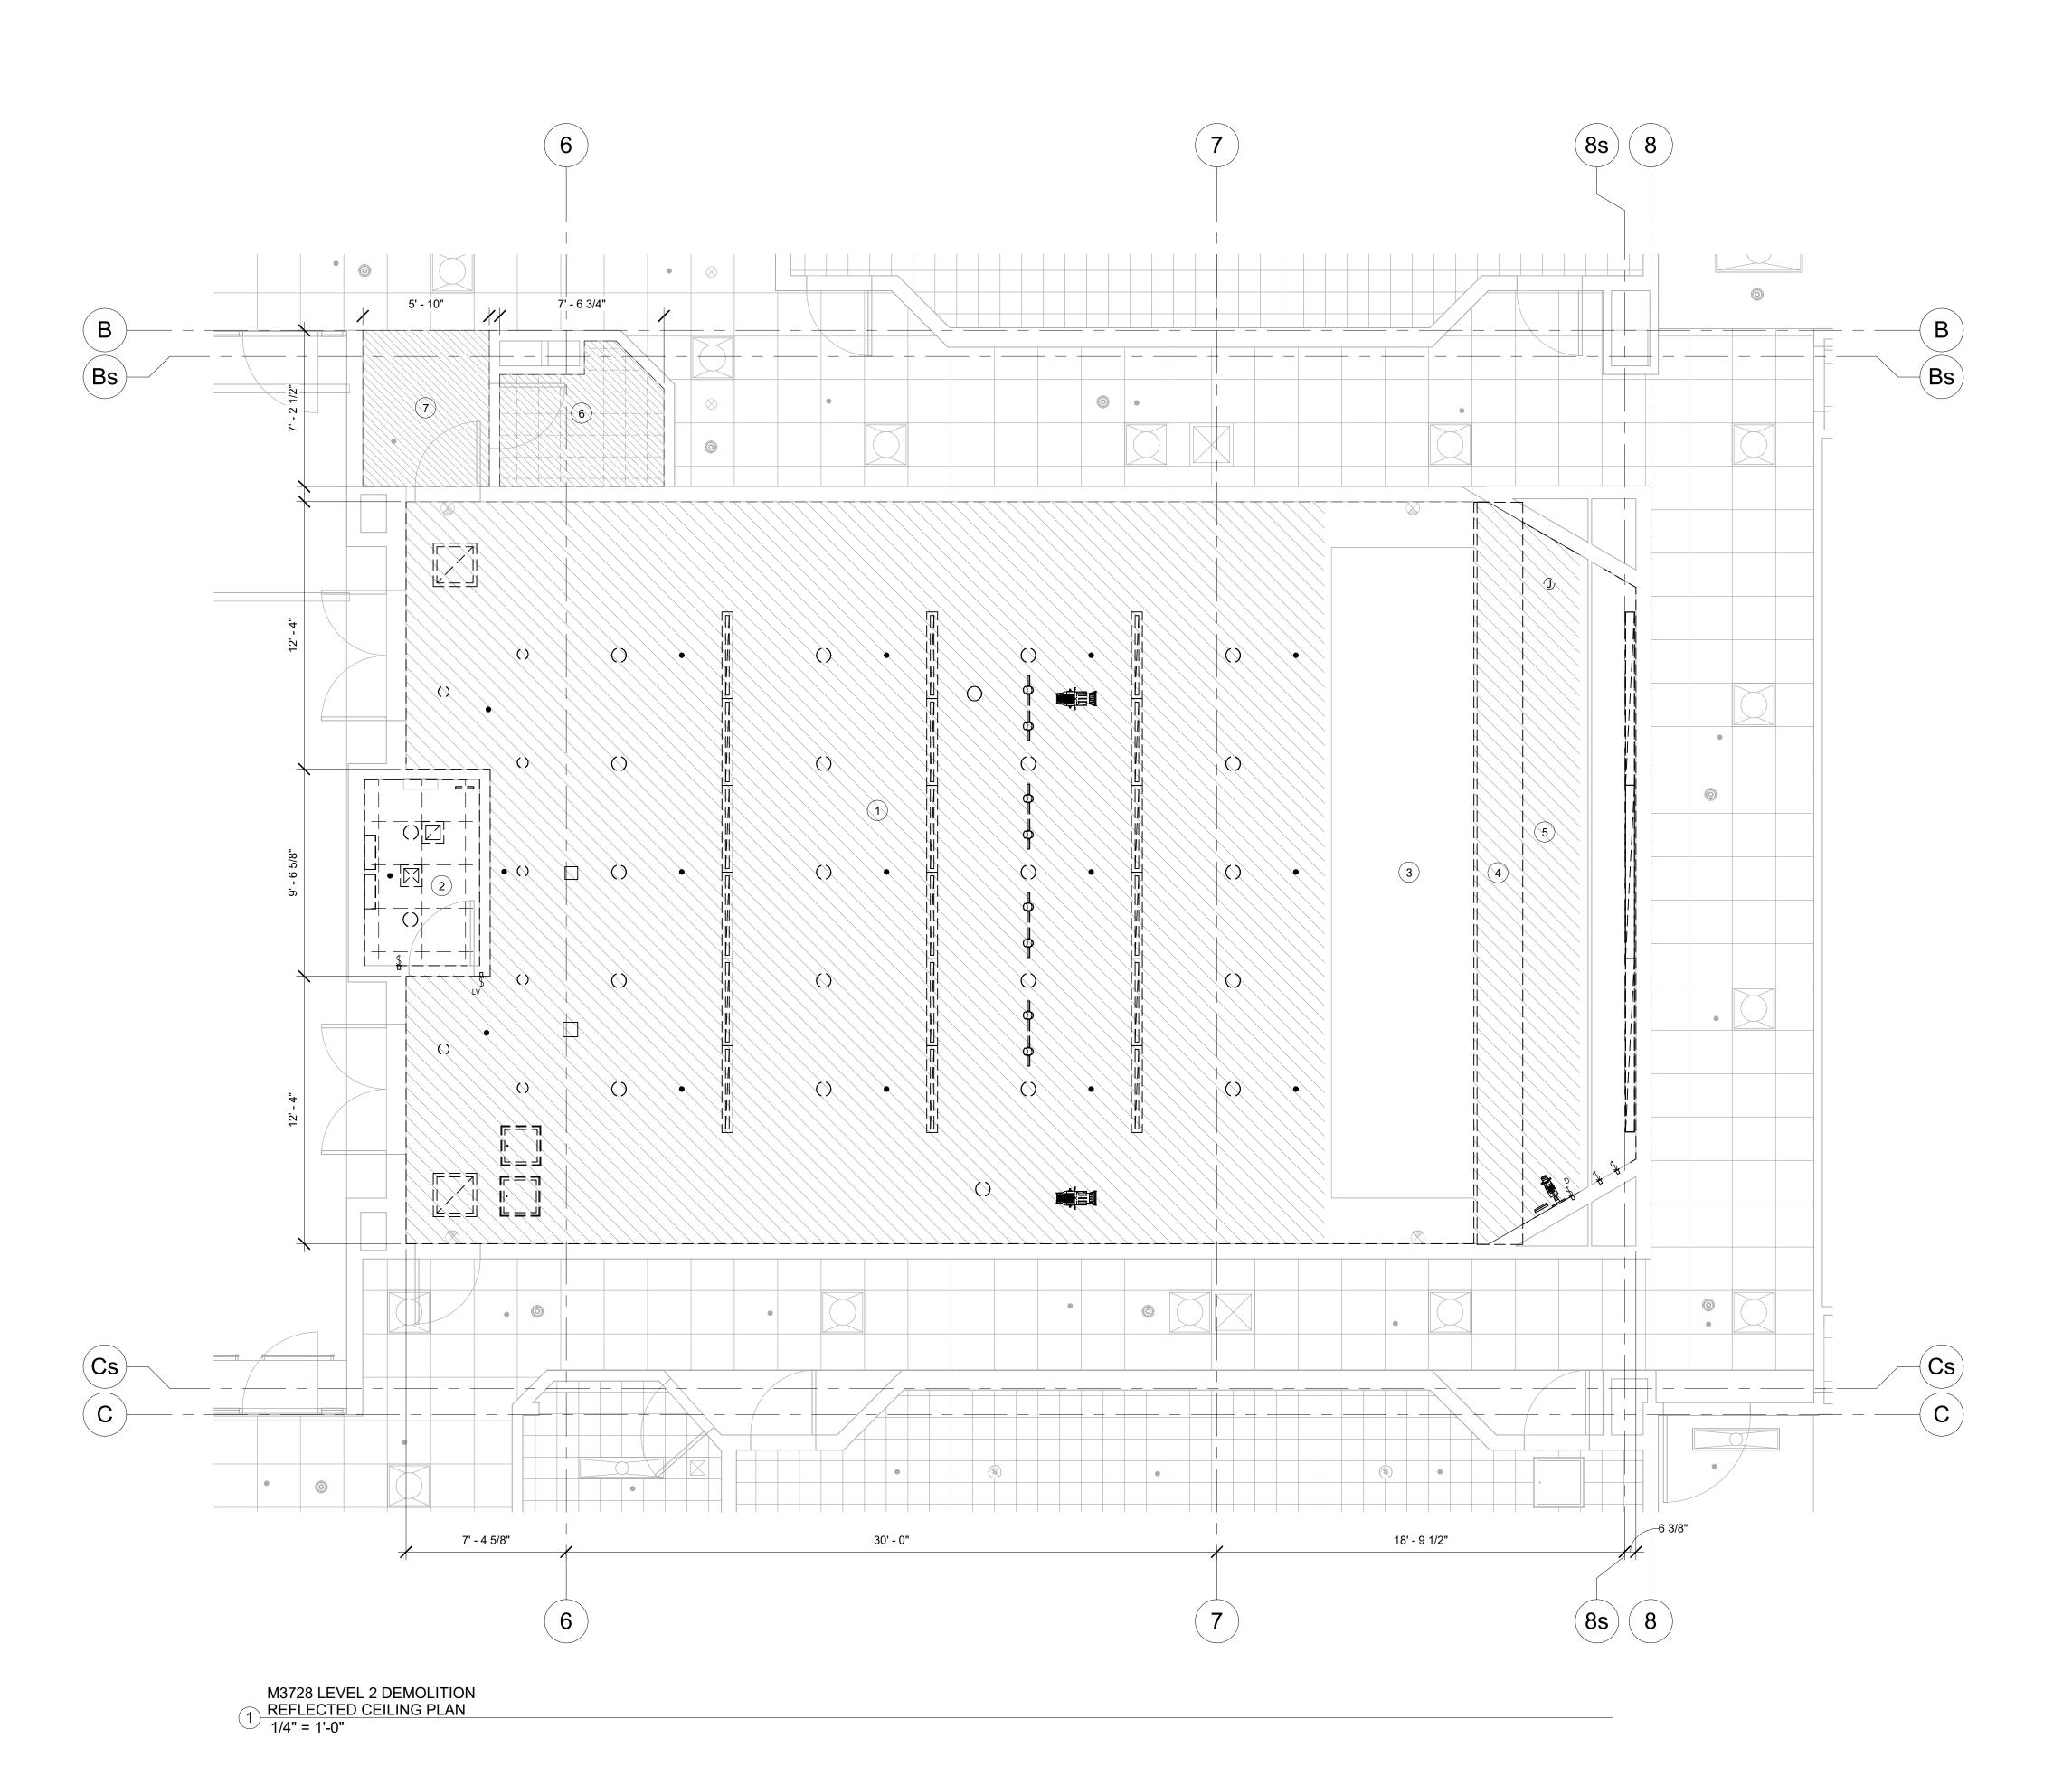

- 1 DEMO EXISTING GYPSUM BOARD CEILING, INCLUDING LIGHTING, HVAC GRILLES. FIRE SPRINKLER SYSTEM TO REMAIN AND INSTALL NEW HEADS W/ FLEX CONNECTOR (SEE PLUMBING PLAN)
- 2 DEMO EXISTING ACT CEILING, INCLUDING LIGHTING, HVAC GRILLES. FIRE SPRINKLER SYSTEM TO REMAIN AND INSTALL NEW HEADS W/ FLEX CONNECTOR (SEE PLUMBING
- 3 EXISTING UPPER GYPSUM BOARD CEILING CLOUD TO REMAIN IN PLACE. PATCH AND REPAIR ANY EXISTING & NEW DAMAGE. PAINT ENTIRE CLOUD, SEE FINISH SCHEDULE FOR
- PAINT COLOR
- 4 REMOVE EXISTING SPEAKER ARRAY 5 MODIFY EXISTING GYPSUM BOARD CEILING CLOUD. CUT OUT MIDDLE SECTION FOR NEW OVERHEAD PROJECTOR. PATCH & REPAIR ALL SIDES AND CORNERS. MODIFY EXISTING SUPPORTS TO INSTALL CLOUDS TO HEIGHT SHOWN ON SHEET A351. SLOPE OF CLOUD TO ADA CHECK: REMAIN THE SAME. PATCH AND REPAIR CLOUD ONCE IN FINAL RAISED POSITION. SEE FINISH SCHEDULE FOR PAINT COLOR
- 6 ALTERNATE #1 SCOPE: DEMO 1x1 CEILING SYSTEM FOR ACCESS TO FOUNTAIN PIPE WORK. REPLACE WITH NEW 2x2 ACT CEILING SYSTEM
- 7 ALTERNATE #1 SCOPE: DEMO HARD LID GYPSUM BOARD CEILING SYSTEM FOR ACCESS TO FOUNTAIN PIPE WORK. REPLACE WITH NEW 2x2 ACT CEILING SYSTEM



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**CLIENT APPROVAL** 

**REVISIONS** 

2

CONTRACTOR TO PROVIDE & INSTALL SCAFFOLDING AND 'DANCE FLOOR' TYPE WORKING PLATFORM FOR DEMOLITION AND NEW CONSTRUCTION.

CONTRACTOR TO PROVIDE ACCESS TO BYU OIT INSTALLERS TO REMOVE EXISTING OIT ITEMS SUCH AS SPEAKERS, PROJECTORS, DISPLAYS ETC.

CONTRACTOR TO ALSO PROVIDE ACCESS TO BYU OIT INSTALLERS TO INSTALL NEW OIT SPEAKERS, PROJECTORS, ETC. THIS IS TO HAPPEN BEFORE SCAFFOLDING IS TAKEN DOWN.


LEVEL 2 **DEMOLITION** REFLECTED **CEILING PLAN** 

WORK ORDER & SHEET NO.

M3728 **AD152** 



DIAGONAL HATCH AREA INDICATES SECTION OF CEILING TO BE REMOVED OR ALTERED

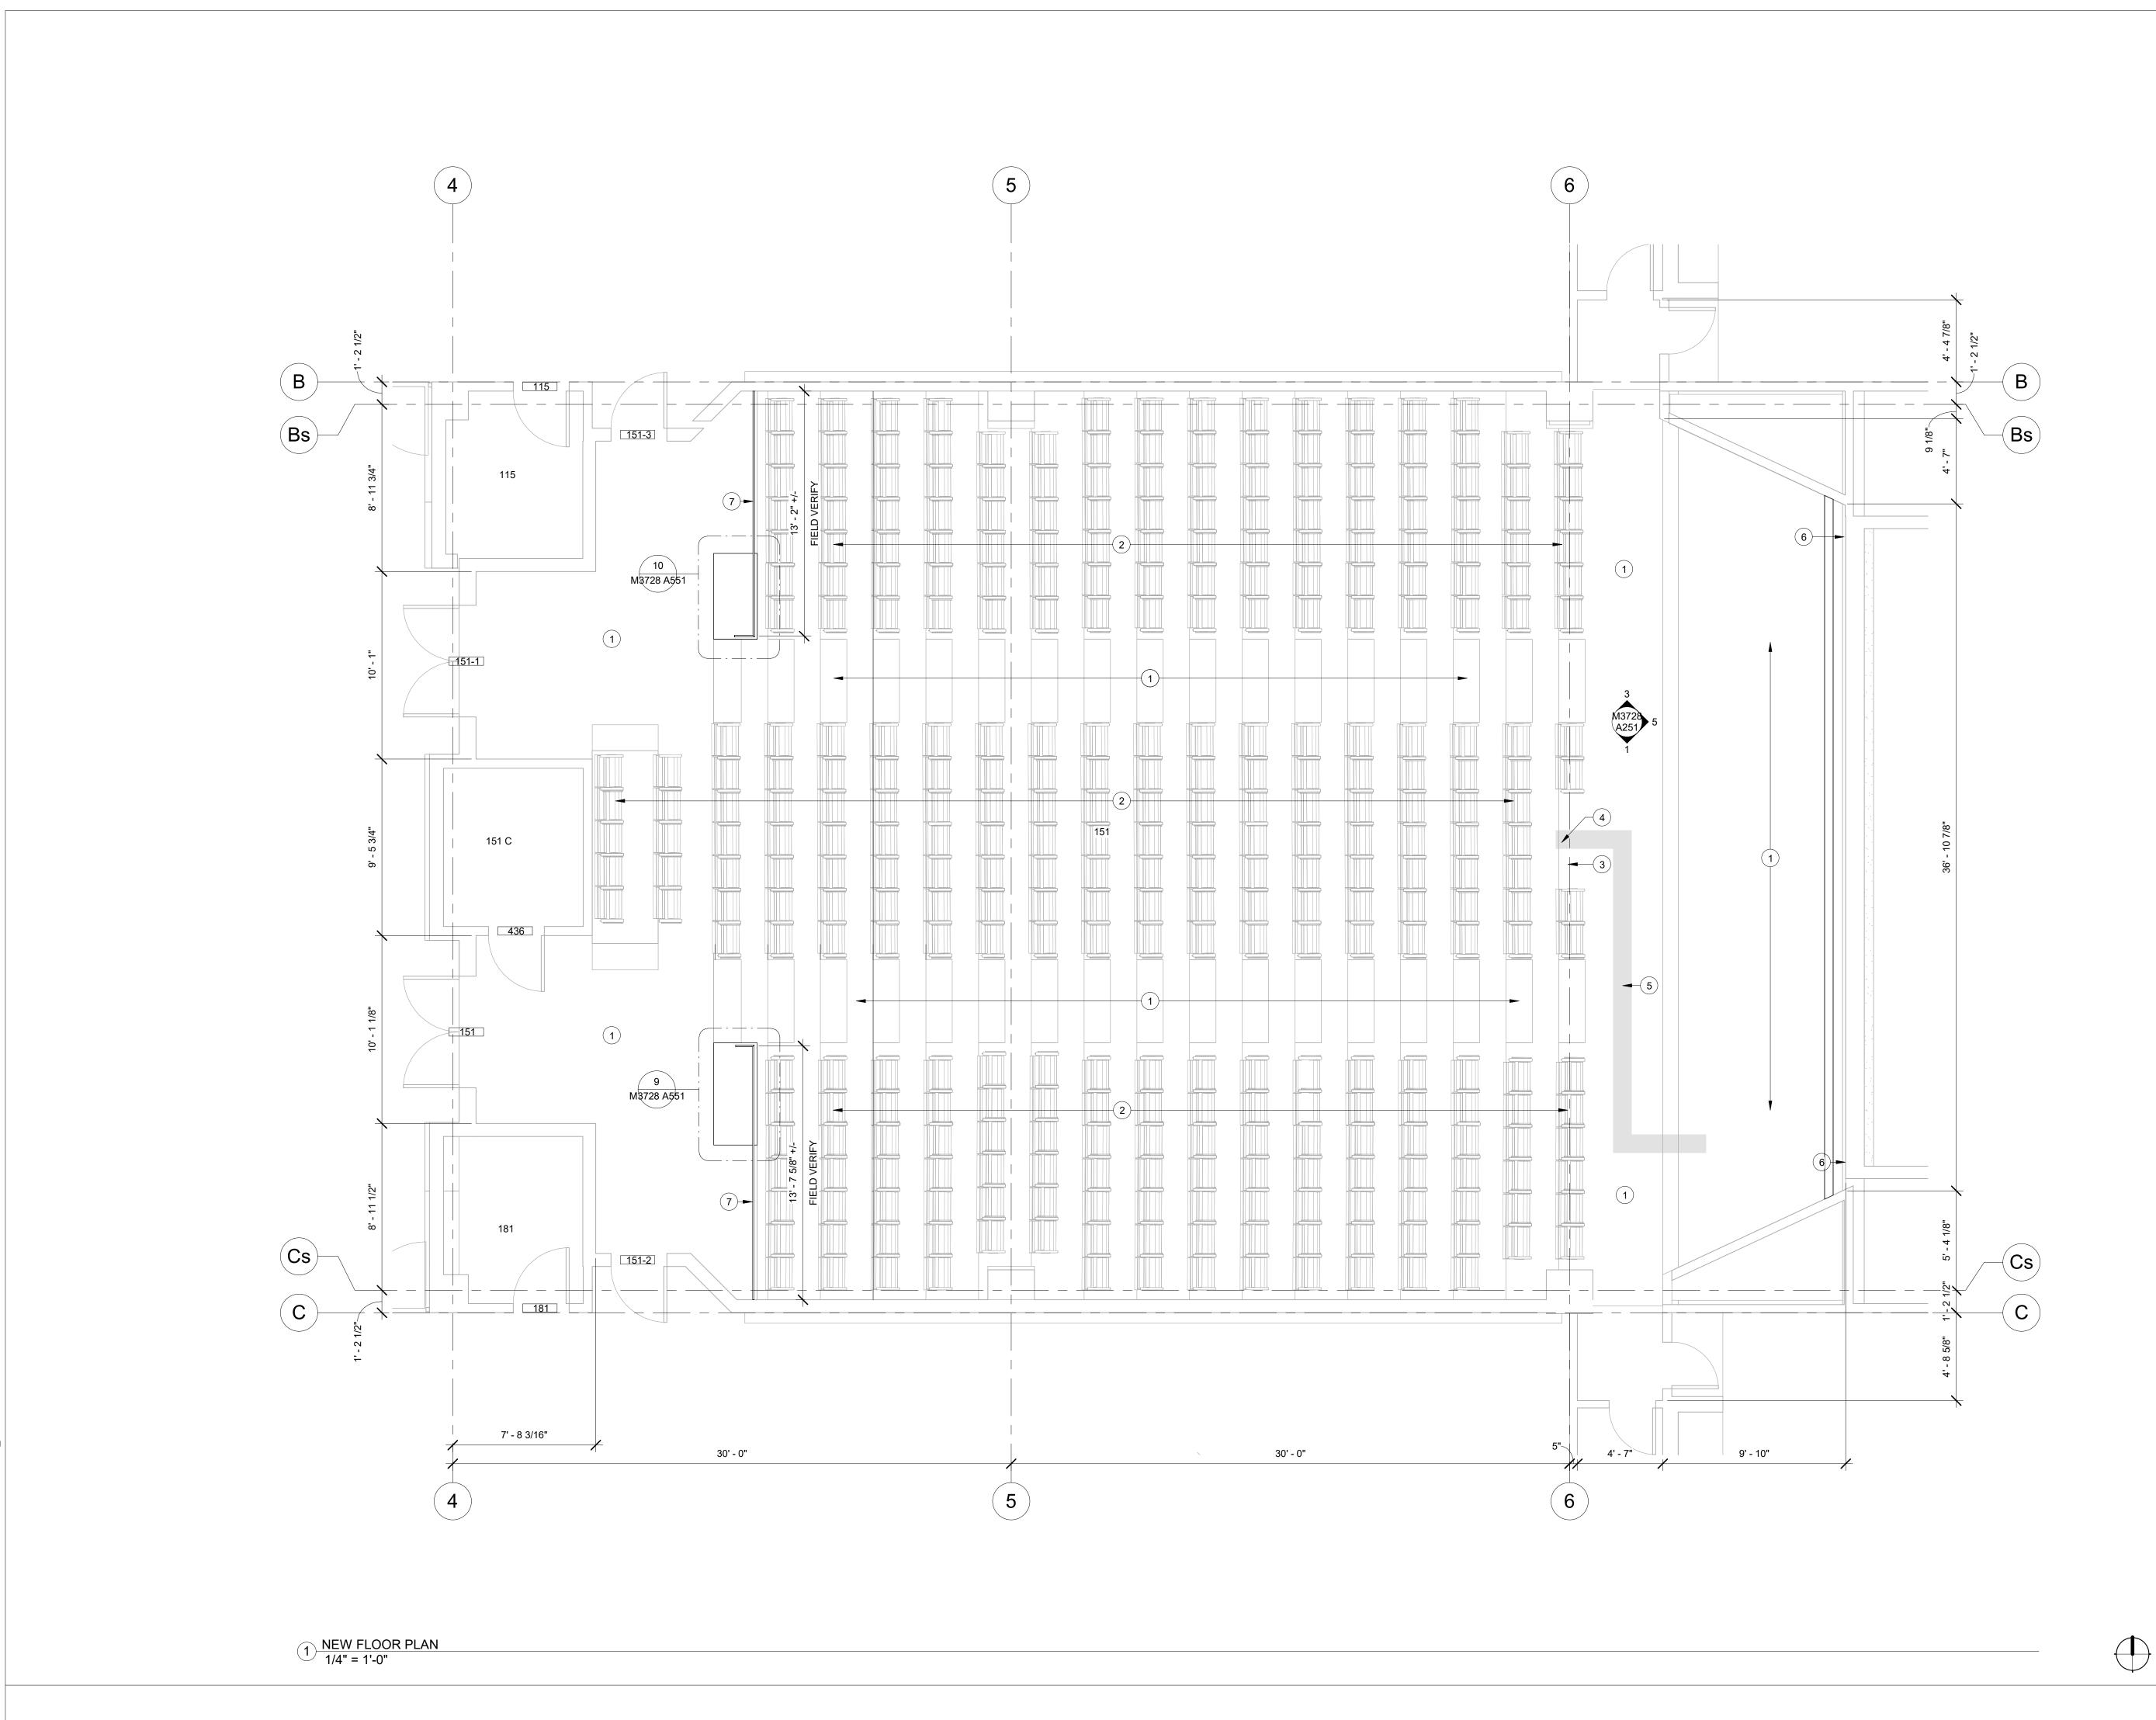

- 1 BYU TO PROVIDE AND INSTALL NEW CARPET
- 2 BYU TO PROVIDE AND INSTALL NEW THEATER
- SEATING (NIC) 3 SECTION OF SEATING TO REMAIN OPEN FOR A/V EQUIPMENT. SEE OIT & ELECTRICAL PLANS
- FOR EQUIPMENT INFORMATION 4 PROVIDE/INSTALL NEW SURFACE MOUNTED
- DATA AND ELECTRICAL BOXES. CENTER WITHIN CHAIR OPENING. SEE OIT & ELECTRICAL PLANS FOR ADDITIONAL INFO
- 5 FILL SAW CUT TRENCH WITH STANDARD SPECIFIED CAST-IN-PLACE CONCRETE. SMOOTH
- 6 PATCH & REPAIR EXISTING HOLES IN WALL, HOLES APPROXIMATELY 7' UP FROM FINISH
- 7 NEW ALUMINUM RAILING (BASIS OF DESIGN, IDEAL SHIELD ALUMINUM HANDRAILS)



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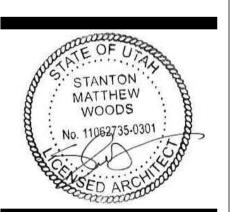
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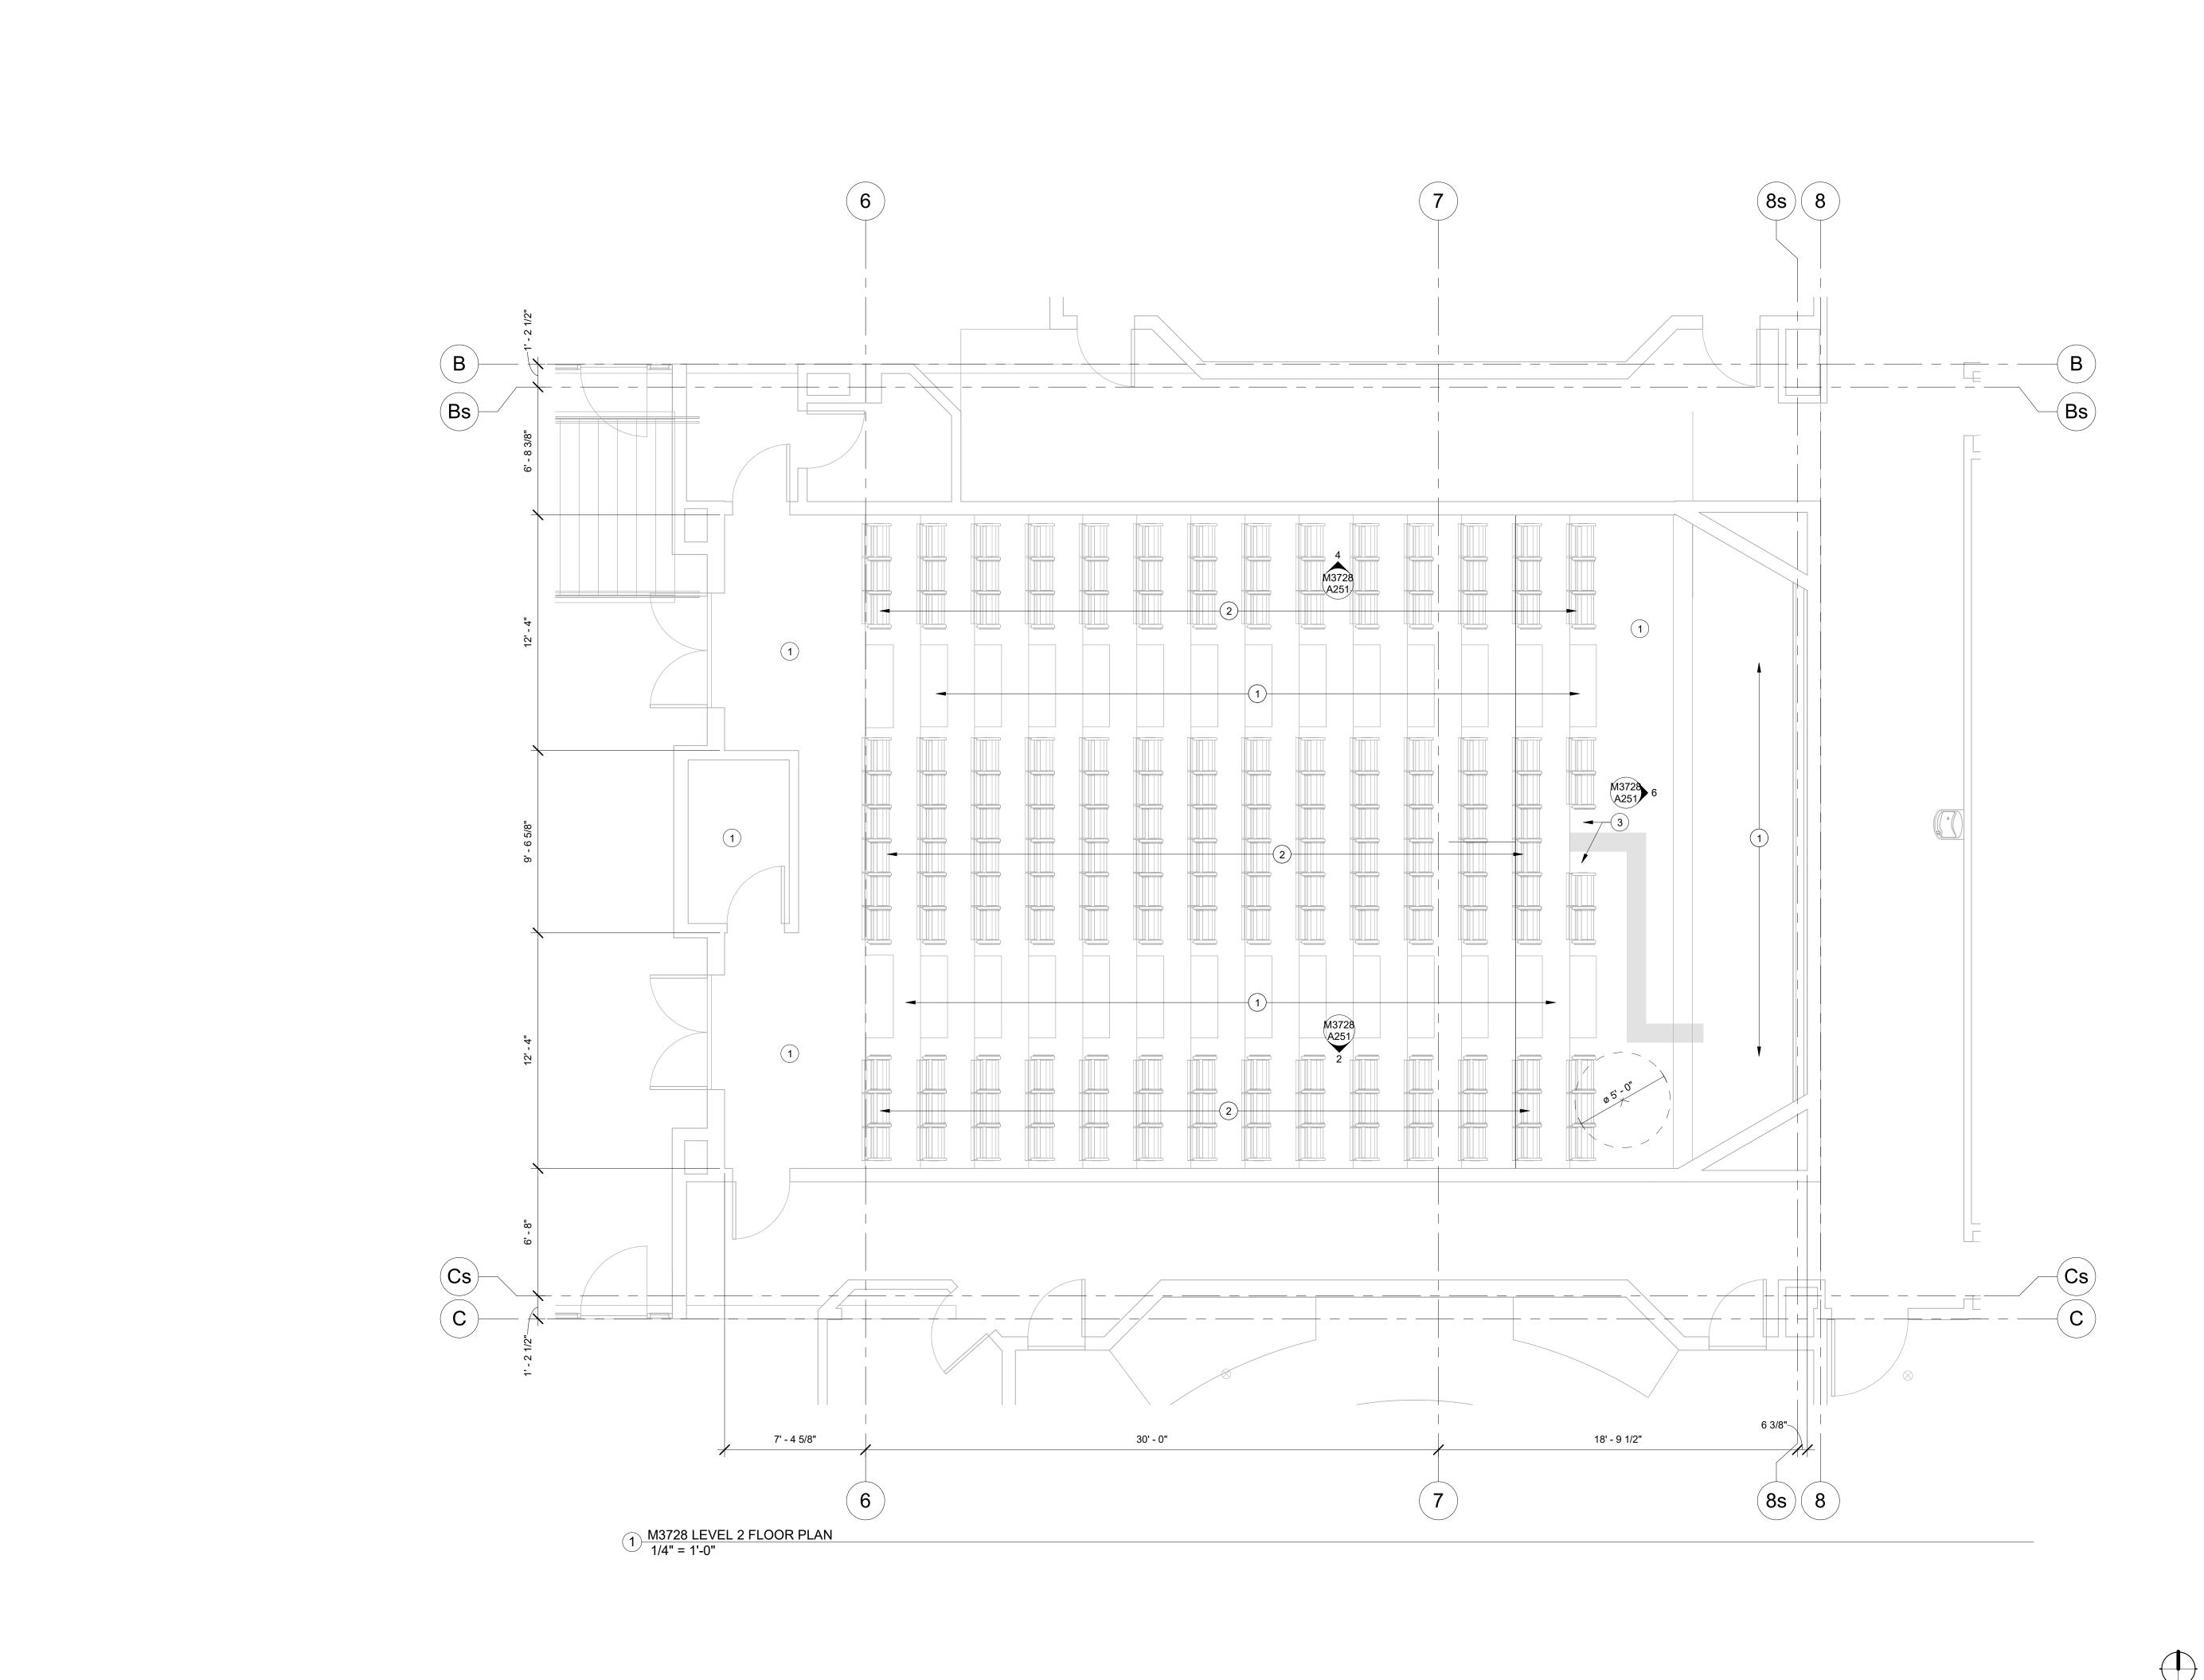
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LEVEL 1 FLOOR PLAN

WORK ORDER & SHEET NO.



1 BYU TO PROVIDE AND INSTALL NEW CARPET

2 BYU TO PROVIDE AND INSTALL NEW
THEATER SEATING (NIC)
3 SECTION OF SEATING TO REMAIN OPEN FOR
A/V EQUIPMENT. SEE OIT & ELECTRICAL
PLANS FOR EQUIPMENT INFORMATION



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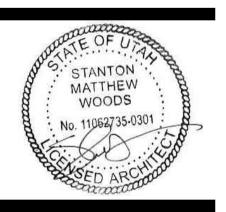
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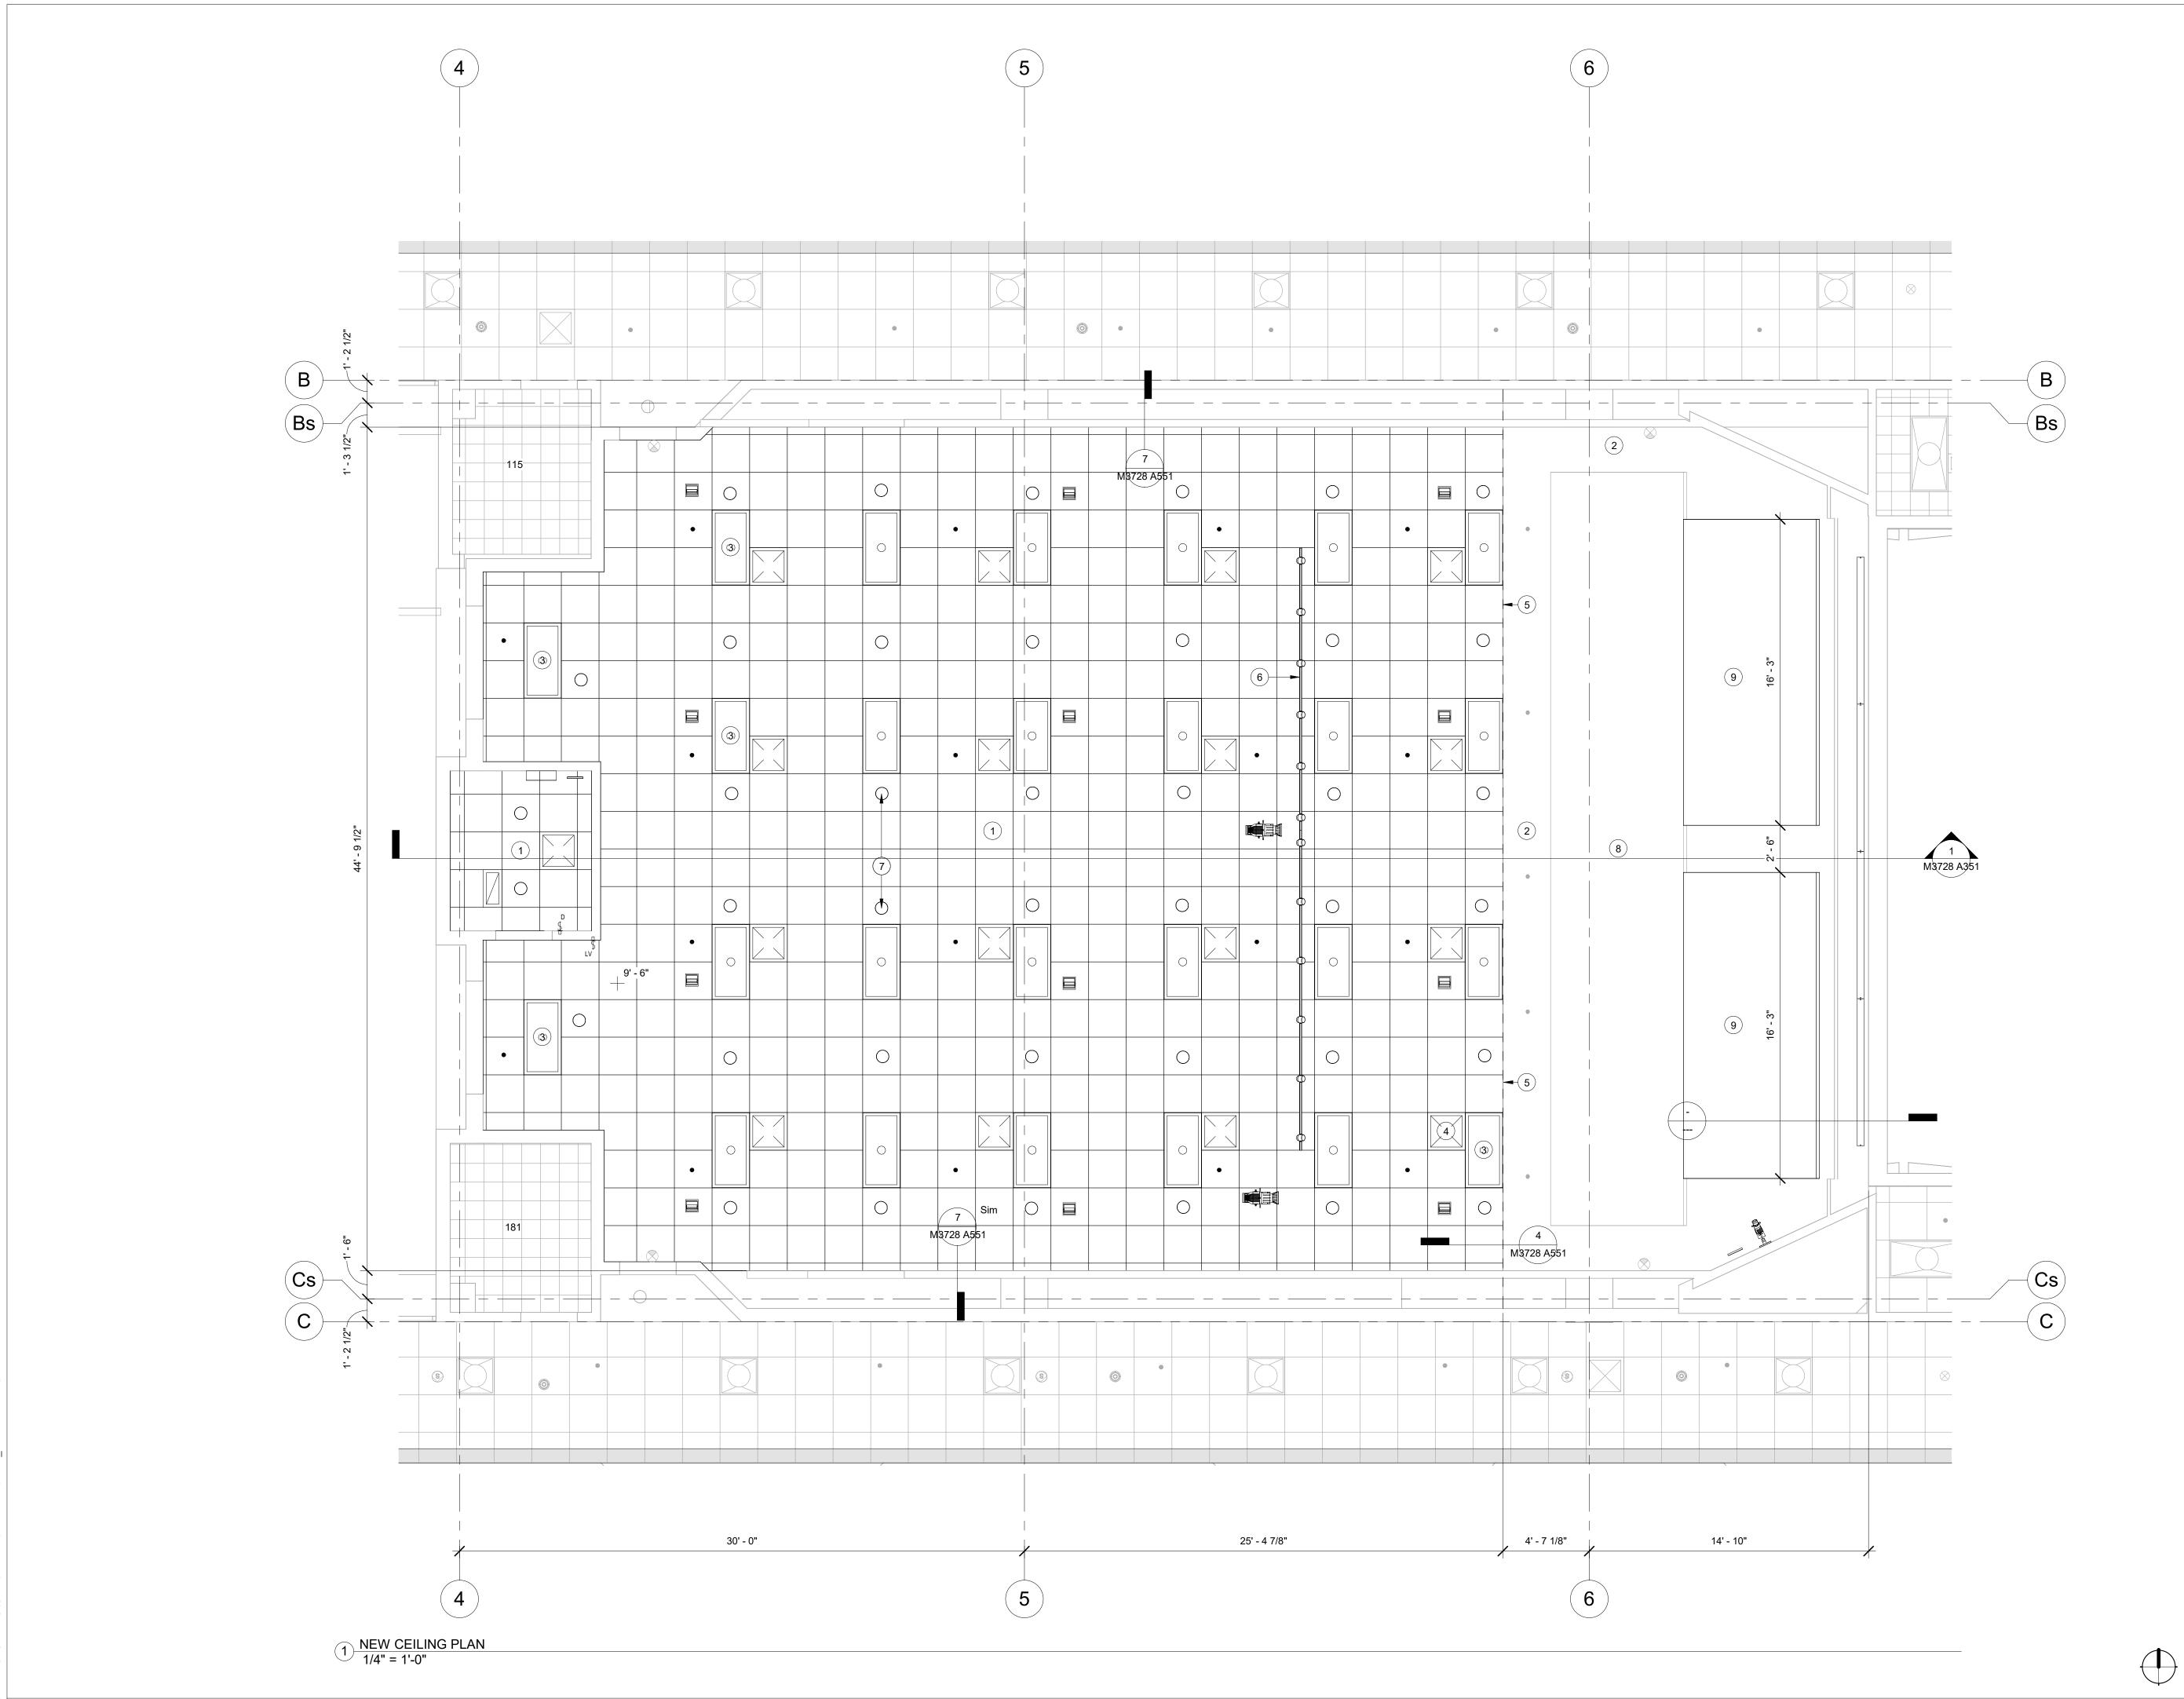
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LEVEL 2 FLOOR PLAN

WORK ORDER & SHEET NO.



1 NEW ACT CEILING SYSTEM, CEILING TILE TO

BE USG FROST 490

2 EXISTING SLOPED SECTION OF CEILING TO REMAIN. PATCH AND REPAIR ANY EXISTING & NEW DAMAGE. PAINT ENTIRE CEILING, SEE FINISH SCHEDULE FOR PAINT COLOR

3 NEW 2X4 LED PANEL LIGHTING, SEE ELECTRICAL PLANS FOR ADDITIONAL INFORMATION

UP TO EDGE. SEE DETAIL 7/A551

4 NEW HVAC GRILLES, REFER TO MECHANICAL PLANS FOR ADDITIONAL INFORMATION 5 REPAIR EDGE OF EXISTING ANGLED GYP. BD. CEILING SO THAT NEW ACT CEILING CAN BUTT

6 NEW STAGE LIGHTING & SUPPORT, SEE ELECTRICAL PLANS FOR ADDITIONAL INFORMATION

7 NEW CAN LIGHTING, SEE ELECTRICAL PLANS FOR ADDITIONAL INFORMATION

8 EXISTING UPPER GYPSUM BOARD CEILING CLOUD TO REMAIN IN PLACE. PATCH AND REPAIR ANY EXISTING & NEW DAMAGE. PAINT ENTIRE CLOUD, SEE FINISH SCHEDULE FOR PAINT COLOR

9 MODIFY EXISTING GYPSUM BOARD CEILING CLOUD. CUT OUT MIDDLE SECTION FOR NEW OVERHEAD PROJECTOR. PATCH & REPAIR ALL SIDES AND CORNERS. MODIFY EXISTING SUPPORTS TO INSTALL CLOUDS TO HEIGHT SHOWN ON SHEET A351. SLOPE OF CLOUD TO REMAIN THE SAME. PATCH AND REPAIR CLOUD ONCE IN FINAL RAISED POSITION. SEE FINISH SCHEDULE FOR PAINT COLOR



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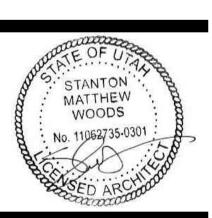
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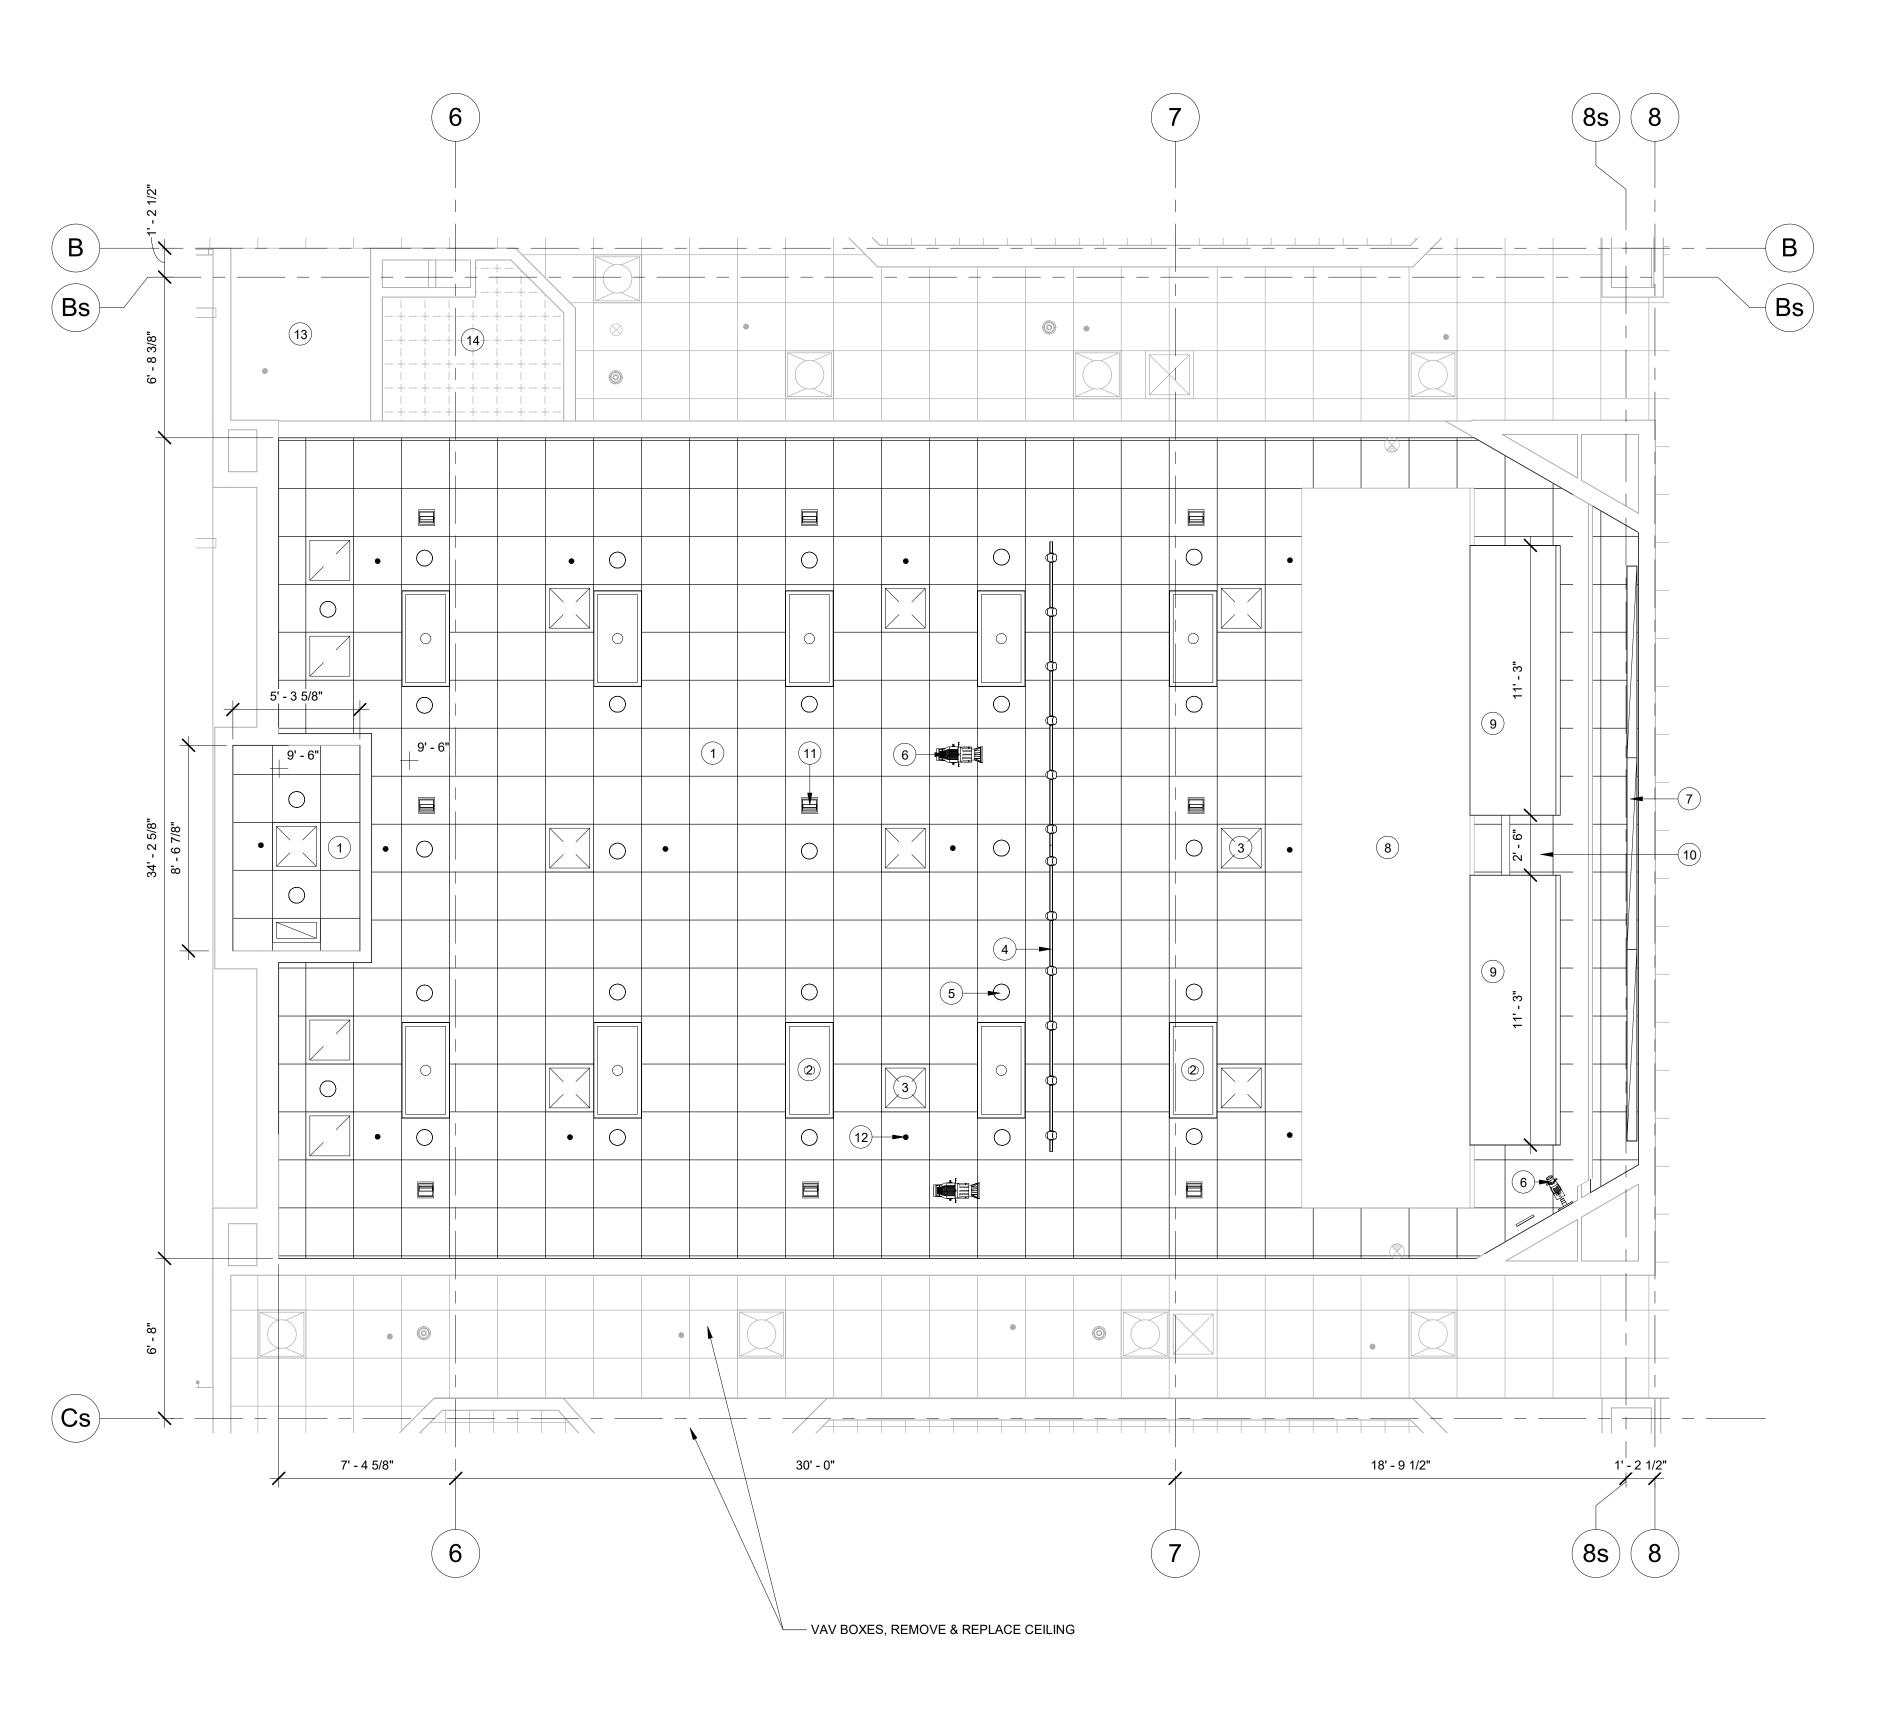
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LEVEL 1 REFLECTED **CEILING PLAN** 

WORK ORDER & SHEET NO.



M3728 LEVEL 2 REFLECTED CEILING
PLAN
1/4" = 1'-0"

#### REFERENCE NOTES

- 1 NEW ACT CEILING SYSTEM, CEILING TILE TO BE USG FROST 490
- 2 NEW 2X4 LED PANEL LIGHTING, SEE ELECTRICAL PLANS FOR ADDITIONAL
- INFORMATION
- 3 NEW HVAC GRILLES, REFER TO MECHANICAL PLANS FOR ADDITIONAL INFORMATION 4 NEW STAGE LIGHTING & SUPPORT, SEE
- ELECTRICAL PLANS FOR ADDITIONAL INFORMATION 5 NEW CAN LIGHTING, SEE ELECTRICAL PLANS
- FOR ADDITIONAL INFORMATION
- 6 NEW SPOTLIGHT FIXTURE, SEE ELECTRICAL PLANS FOR ADDITIONAL INFORMATION
- 7 NEW LIGHT FIXTURE ABOVE WHITEBOARDS, SEE ELEC. PLANS
- 8 EXISTING UPPER GYPSUM BOARD CEILING CLOUD TO REMAIN IN PLACE. PATCH AND REPAIR ANY EXISTING & NEW DAMAGE. PAINT
- ENTIRE CLOUD, SEE FINISH SCHEDULE FOR PAINT COLOR 9 MODIFY EXISTING GYPSUM BOARD CEILING
- CLOUD. CUT OUT MIDDLE SECTION FOR NEW OVERHEAD PROJECTOR. PATCH & REPAIR ALL SIDES AND CORNERS. MODIFY EXISTING SUPPORTS TO INSTALL CLOUDS TO HEIGHT SHOWN ON SHEET A351. SLOPE OF CLOUD TO REMAIN THE SAME. PATCH AND REPAIR CLOUD ONCE IN FINAL RAISED POSITION. SEE FINISH SCHEDULE FOR PAINT COLOR
- 10 OVERHEAD CAST PROJECTOR, PROVIDE DATA & POWER CONNECTION. BYU OIT TO INSTALL. SEE ELECTRICAL & OIT PLANS FOR ADDITIONAL INFORMATION
- 11 NEW EMERGENCY LIGHT FIXTURE, SEE ELEC. PLANS 12 MODIFY FIRESPRINKLER SYSTEM TO NEW
- CEILING LAYOUT. REFER TO MECHANICAL 13 ALTERNATE #1 SCOPE: DEMO HARD LID

SYSTEM FOR ACCESS TO FOUNTAIN PIPE WORK. REPLACE WITH NEW 2x2 ACT CEILING

GYPSUM BOARD CEILING SYSTEM FOR ACCESS TO FOUNTAIN PIPE WORK. REPLACE WITH NEW 2x2 ACT CEILING SYSTEM 14 ALTERNATE #1 SCOPE: DEMO 1x1 CEILING

SYSTEM

FOUNDED BYU

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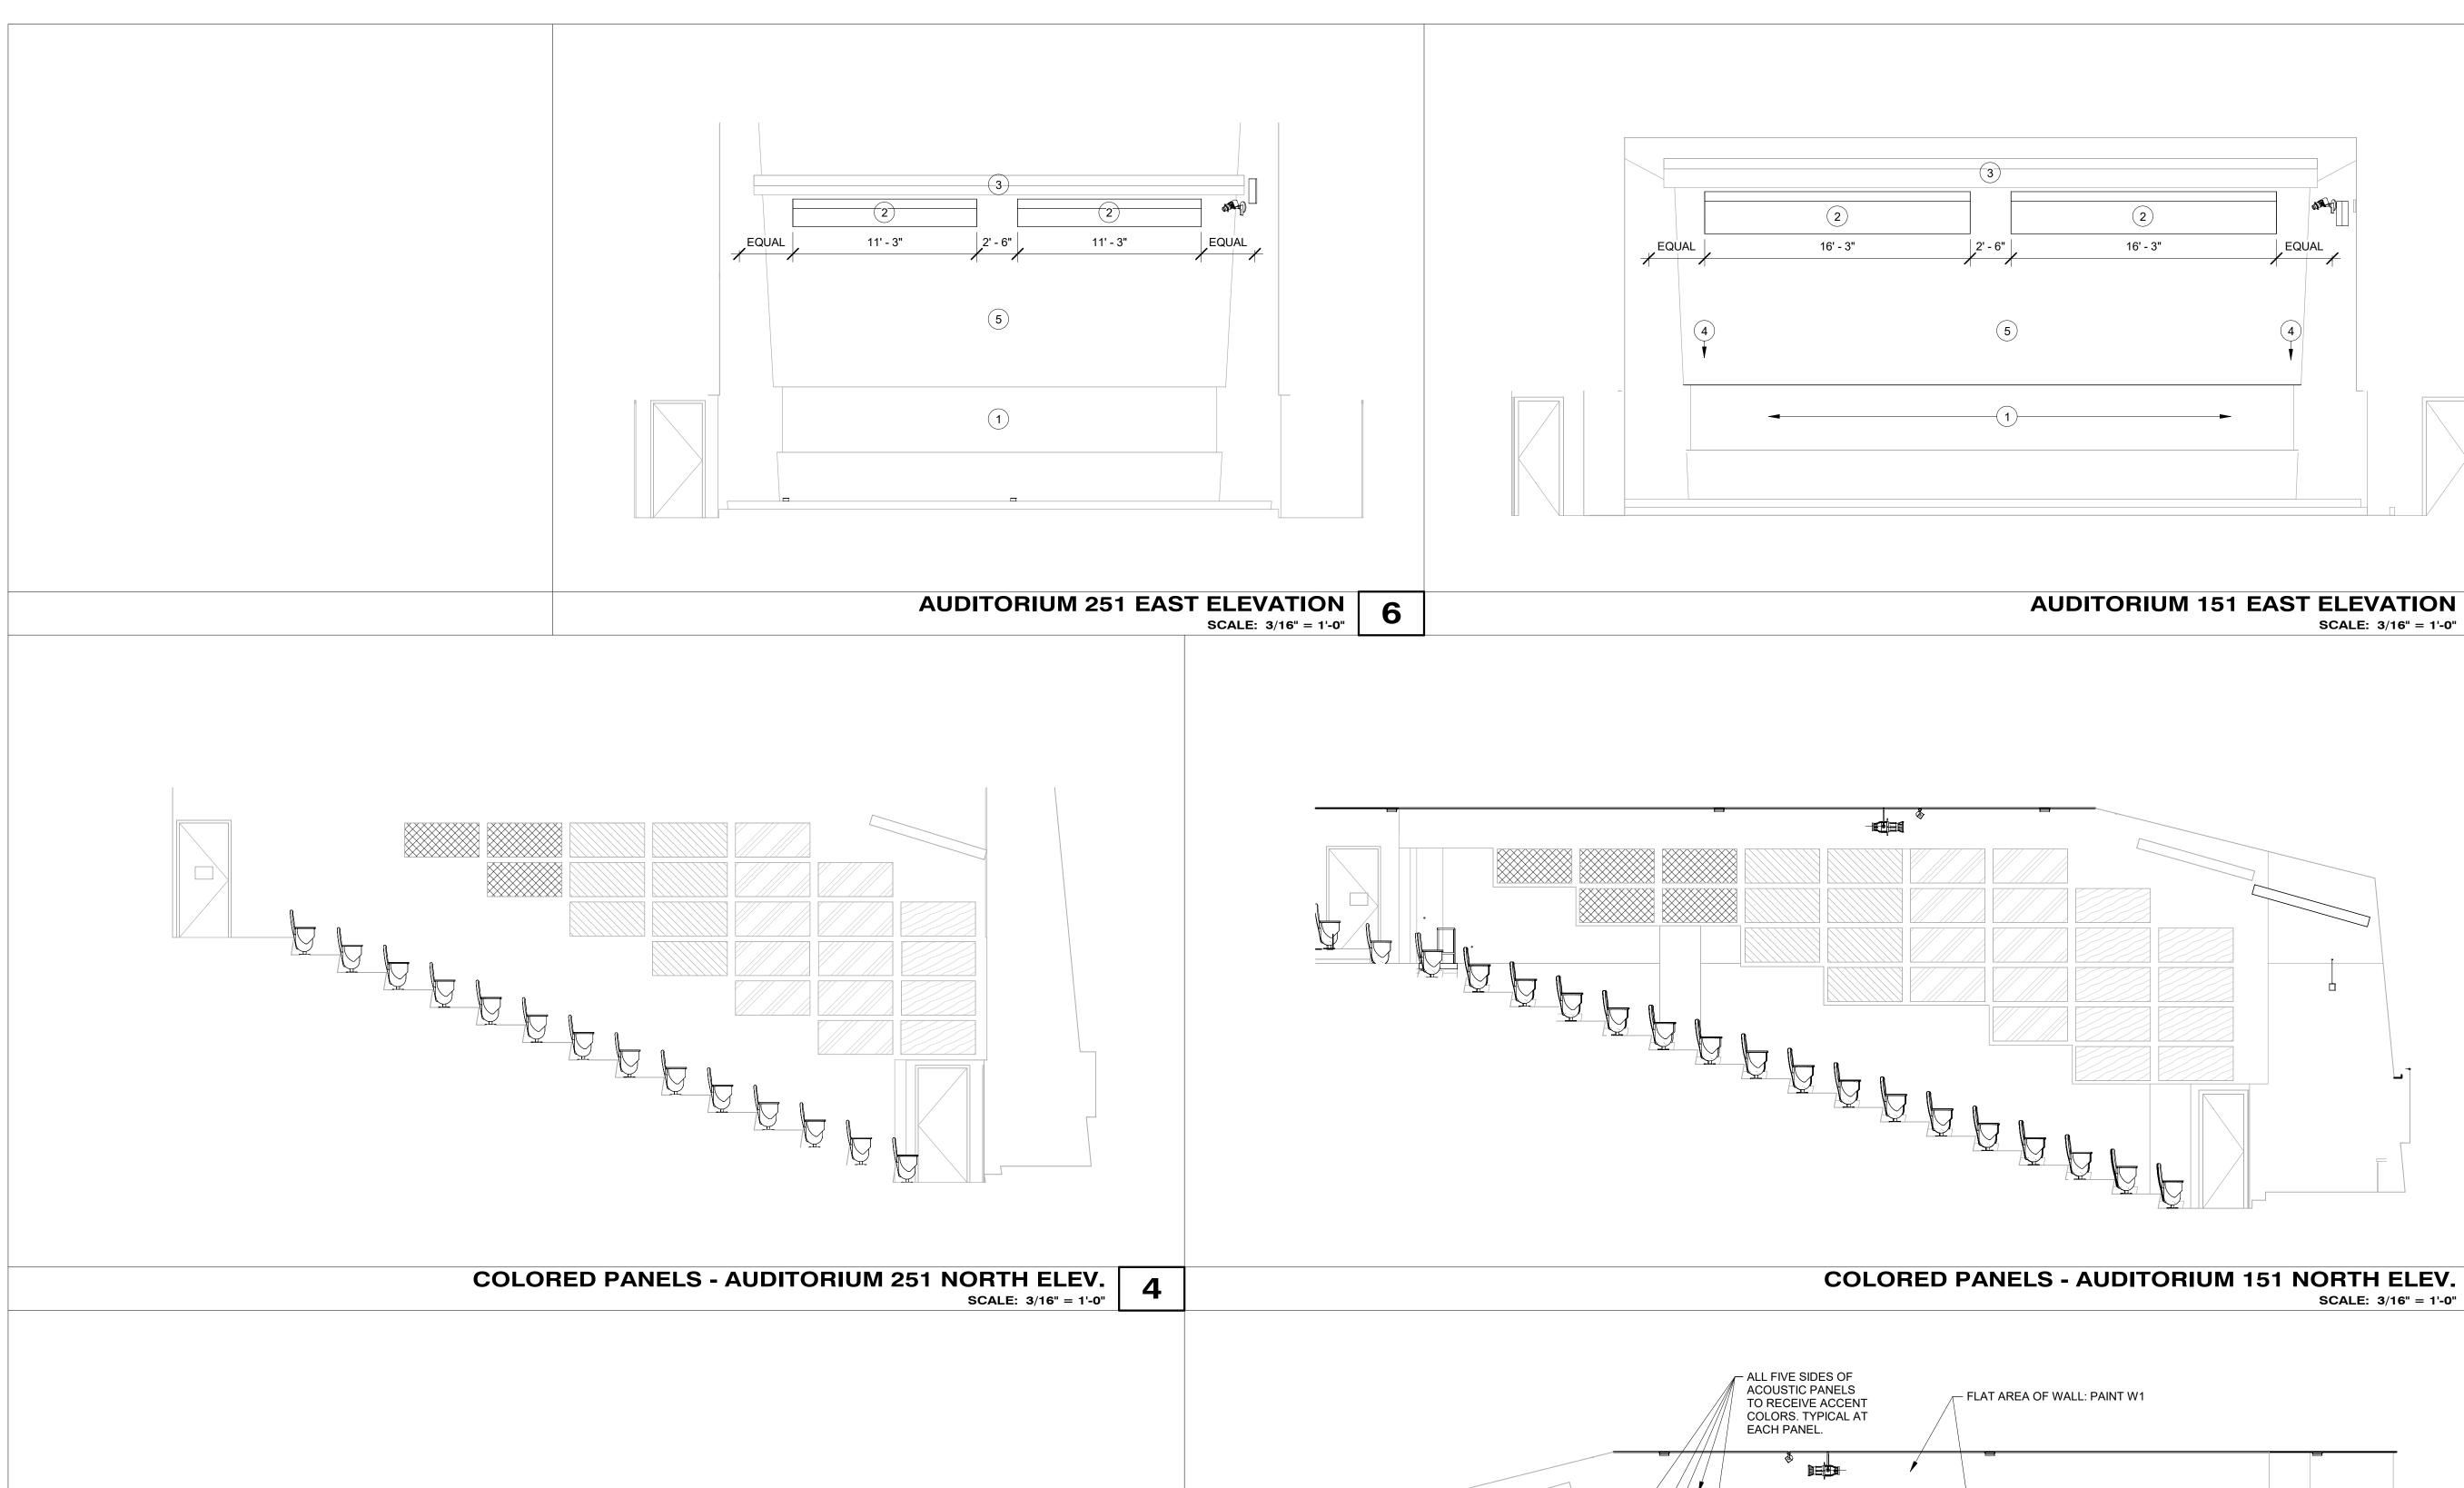
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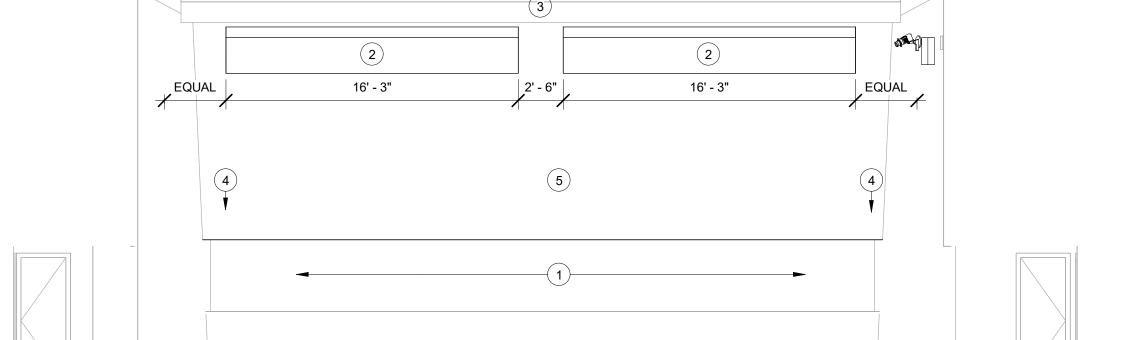
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2 S

LEVEL 2 REFLECTED **CEILING PLAN** 

WORK ORDER & SHEET NO.





**SCALE:** 3/16" = 1'-0"

AUDITORIUM 151 EAST ELEVATION

LOCATION: ALL WALLS, GYP. BOARD CEILINGS, AND HARD ACOUSTIC PANELS ABOVE STAGE AREA

REFERENCE NOTES

SCHEDULE FOR PAINT COLOR

FINISH SCHEDULE ON A251

**FINISH SCHEDULE** 

W1: BYU MOUNTAIN HAZE, SEMI-GLOSS,

BENJAMIN MOORE, ULTRA SPEC 500

T545-1X, Y3-18, S1-2, S2-17, M1-2.5, R3-0.75

MIX CODE (JONES PAINT& GLASS):

PAINT COLOR

**WALLS** 

1 EXISTING WHITEBOARDS AND CURTAINS TO REMAIN. PROTECT FROM CONSTRUCTION

2 MODIFY EXISTING GYPSUM BOARD CEILING CLOUD. CUT OUT MIDDLE SECTION FOR NEW OVERHEAD PROJECTOR. PATCH & REPAIR ALL SIDES AND CORNERS. MODIFY EXISTING SUPPORTS TO INSTALL CLOUDS TO HEIGHT SHOWN ON SHEET A351. SLOPE OF CLOUD TO

3 EXISTING UPPER GYPSUM BOARD CEILING

4 PATCH & REPAIR EXISTING HOLES IN WALL,

HOLES APPROXIMATELY 7' UP FROM FINISH

5 ALL WALLS WITHIN 151 & 251 TO BE PAINTED WITH BYU 'MOUNTAIN HAZE' COLOR. SEE

CLOUD TO REMAIN IN PLACE. PATCH AND REPAIR ANY EXISTING & NEW DAMAGE. PAINT ENTIRE CLOUD, SEE FINISH SCHEDULE FOR

REMAIN THE SAME. PATCH AND REPAIR CLOUD ONCE IN FINAL RAISED POSITION. SEE FINISH

BYU

**FACILITIES PLANNING** 

**240 BRWB PROVO, UTAH 84602** 

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03/14/24

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**DESIGNER:** 

DRAWN BY:

ADA CHECK:

**CODE CHECK:** 

STRUCTURAL: **UTILITIES DIR:** PLANNING DIR:

CLIENT APPROVAL

**REVISIONS** 

W2: SHERWIN-WILLIAMS SW 7036 ACCESS BEIGE

W4: SHERWIN-WILLIAMS

GENX/GAL

W3: SHERWIN-WILLIAMS SW 7037 BALANCED BEIGE

SW 6243 DISTANCE

W5: SHERWIN-WILLIAMS SW 6244 NAVAL

> LOCATION: ACOUSTIC PANELS ON NORTH & SOUTH WALLS OF 151 & 251 SEE ELEVATIONS ON THIS SHEET FOR LOCATIONS

F1: AUDITORIUM CARPET TARKETT, LONGITUDE BYU CUSTOM BLUE

F2: STAGE/LECTURE AREA CARPET TARKETT, PIATRA CUSTOM

#1018365-003 NAVY F3: STEP WARNING STRIP TARKETT, BLACK


B1: TARKETT CARPET BASE, LONGITUDE BYU CUSTOM BLUE (MATCH ADJACENT AUDITORIUM CARPET)

B2: TARKET CARPET BASE, PIATRA CUSTOM (MATCH ADJACENT STAGE/LECTURE CARPET)

C1: ACT SUSPENDED CEILING CEILING TILE: USG FROST 490

C2: PAINTED GYP. BOARD CEILING BYU MOUNTAIN HAZE (SAME AS W1 LISTED ABOVE)

#### WALL PANEL COLOR LEGEND

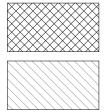


SW 6244 NAVAL SHERWIN-WILLIAMS

SW 6243 DISTANCE

SW 7037 BALANCED BEIGE SHERWIN-WILLIAMS

SW 7036 ACCESSIBLE BEIGE

NOTE: PANEL ACCENT COLORS TO BE APPLIED TO ALL FIVE SIDES OF ANGLED/ACOUSTIC WALL

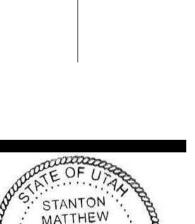

REMODEL

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B

**ELEVATIONS &** FINISH SCHEDULE

WORK ORDER & SHEET NO.

**A251** 

SHERWIN-WILLIAMS SHERWIN-WILLIAMS

**COLORED PANELS - AUDITORIUM 251 SOUTH ELEV.** 2 SCALE: 3/16" = 1'-0"

**COLORED PANELS - AUDITORIUM 151 SOUTH ELEV.** 

SCALE: 3/16" = 1'-0"

STANTON MATTHEW WOODS

**INTERIOR FINISH** 

M3728

NOTE: CONTRACTOR TO PROVIDE & INSTALL


SCAFFOLDING AND 'DANCE FLOOR' TYPE WORKING PLATFORM FOR DEMOLITION AND NEW CONSTRUCTION.

CONTRACTOR TO PROVIDE ACCESS TO BYU OIT INSTALLERS TO REMOVE EXISTING OIT ITEMS SUCH AS SPEAKERS, PROJECTORS, DISPLAYS ETC.

CONTRACTOR TO ALSO PROVIDE ACCESS TO BYU OIT INSTALLERS TO INSTALL NEW OIT SPEAKERS, PROJECTORS, ETC. THIS IS TO HAPPEN BEFORE SCAFFOLDING IS TAKEN DOWN.

#### REFERENCE NOTES

- 1 EXISTING WHITEBOARDS AND CURTAINS TO REMAIN. PROTECT FROM CONSTRUCTION
- 2 EXISTING SLOPED SECTION OF CEILING TO REMAIN. PATCH AND REPAIR ANY EXISTING & NEW DAMAGE. PAINT ENTIRE CEILING, SEE FINISH SCHEDULE FOR PAINT COLOR
- 3 EXISTING UPPER GYPSUM BOARD CEILING CLOUD TO REMAIN IN PLACE. PATCH AND REPAIR ANY EXISTING & NEW DAMAGE. PAINT ENTIRE CLOUD, SEE FINISH SCHEDULE FOR PAINT COLOR
- 4 NEW LIGHT FIXTURE ABOVE WHITEBOARDS, SEE ELEC. PLANS
- 5 NEW ACT CEILING SYSTEM, CEILING TILE TO BE USG FROST 490
- 6 PAINT AREA OF WALL OVERHANG, BOTH NORTH & SOUTH WALLS IN ROOM 151. COLOR W1 (SEE FINISH SCHEDULE, SHEET
- 7 EXISTING ANGLED WALL SECTIONS TO RECEIVE ALTERNATING COLORS. SEE SHEET A251 FOR LAYOUT AND COLORS
- 8 MODIFY EXISTING GYPSUM BOARD CEILING CLOUD. CUT OUT MIDDLE SECTION FOR NEW OVERHEAD PROJECTOR. PATCH & REPAIR ALL SIDES AND CORNERS. MODIFY EXISTING SUPPORTS TO INSTALL CLOUDS TO HEIGHT SHOWN ON SHEET A351. SLOPE OF CLOUD TO REMAIN THE SAME. PATCH AND REPAIR CLOUD ONCE IN FINAL RAISED POSITION. SEE FINISH SCHEDULE FOR PAINT COLOR

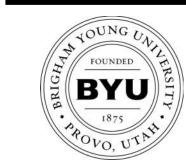

FACILITIES PLANNING **240 BRWB PROVO, UTAH 84602** PHONE: (801) 422-5504 FAX: (801) 422-0566

DATE:	03/14/24
DESIGNER:	SW
DRAWN BY:	SW

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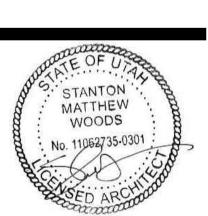
**UTILITIES DIR:** 

PLANNING DIR:

**CLIENT APPROVAL** 

**REVISIONS** 


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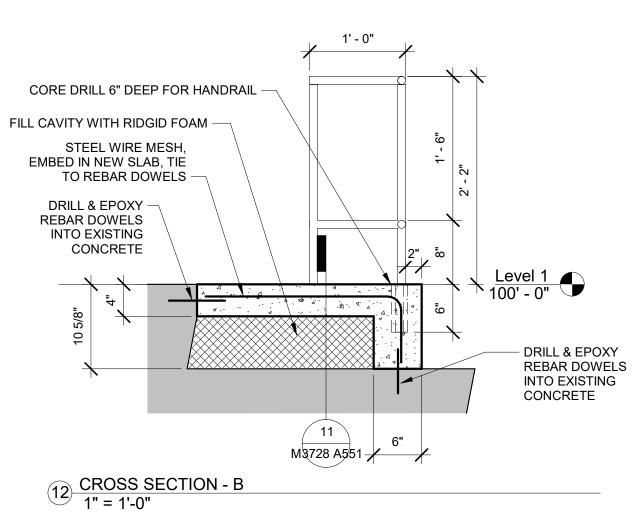
**AUDITORIUMS -SECTION VIEWS** 


WORK ORDER & SHEET NO.


M3728 **A351** 





1 AUDITORIUMS 151 & 251 SECTION VIEW 1/4" = 1'-0"

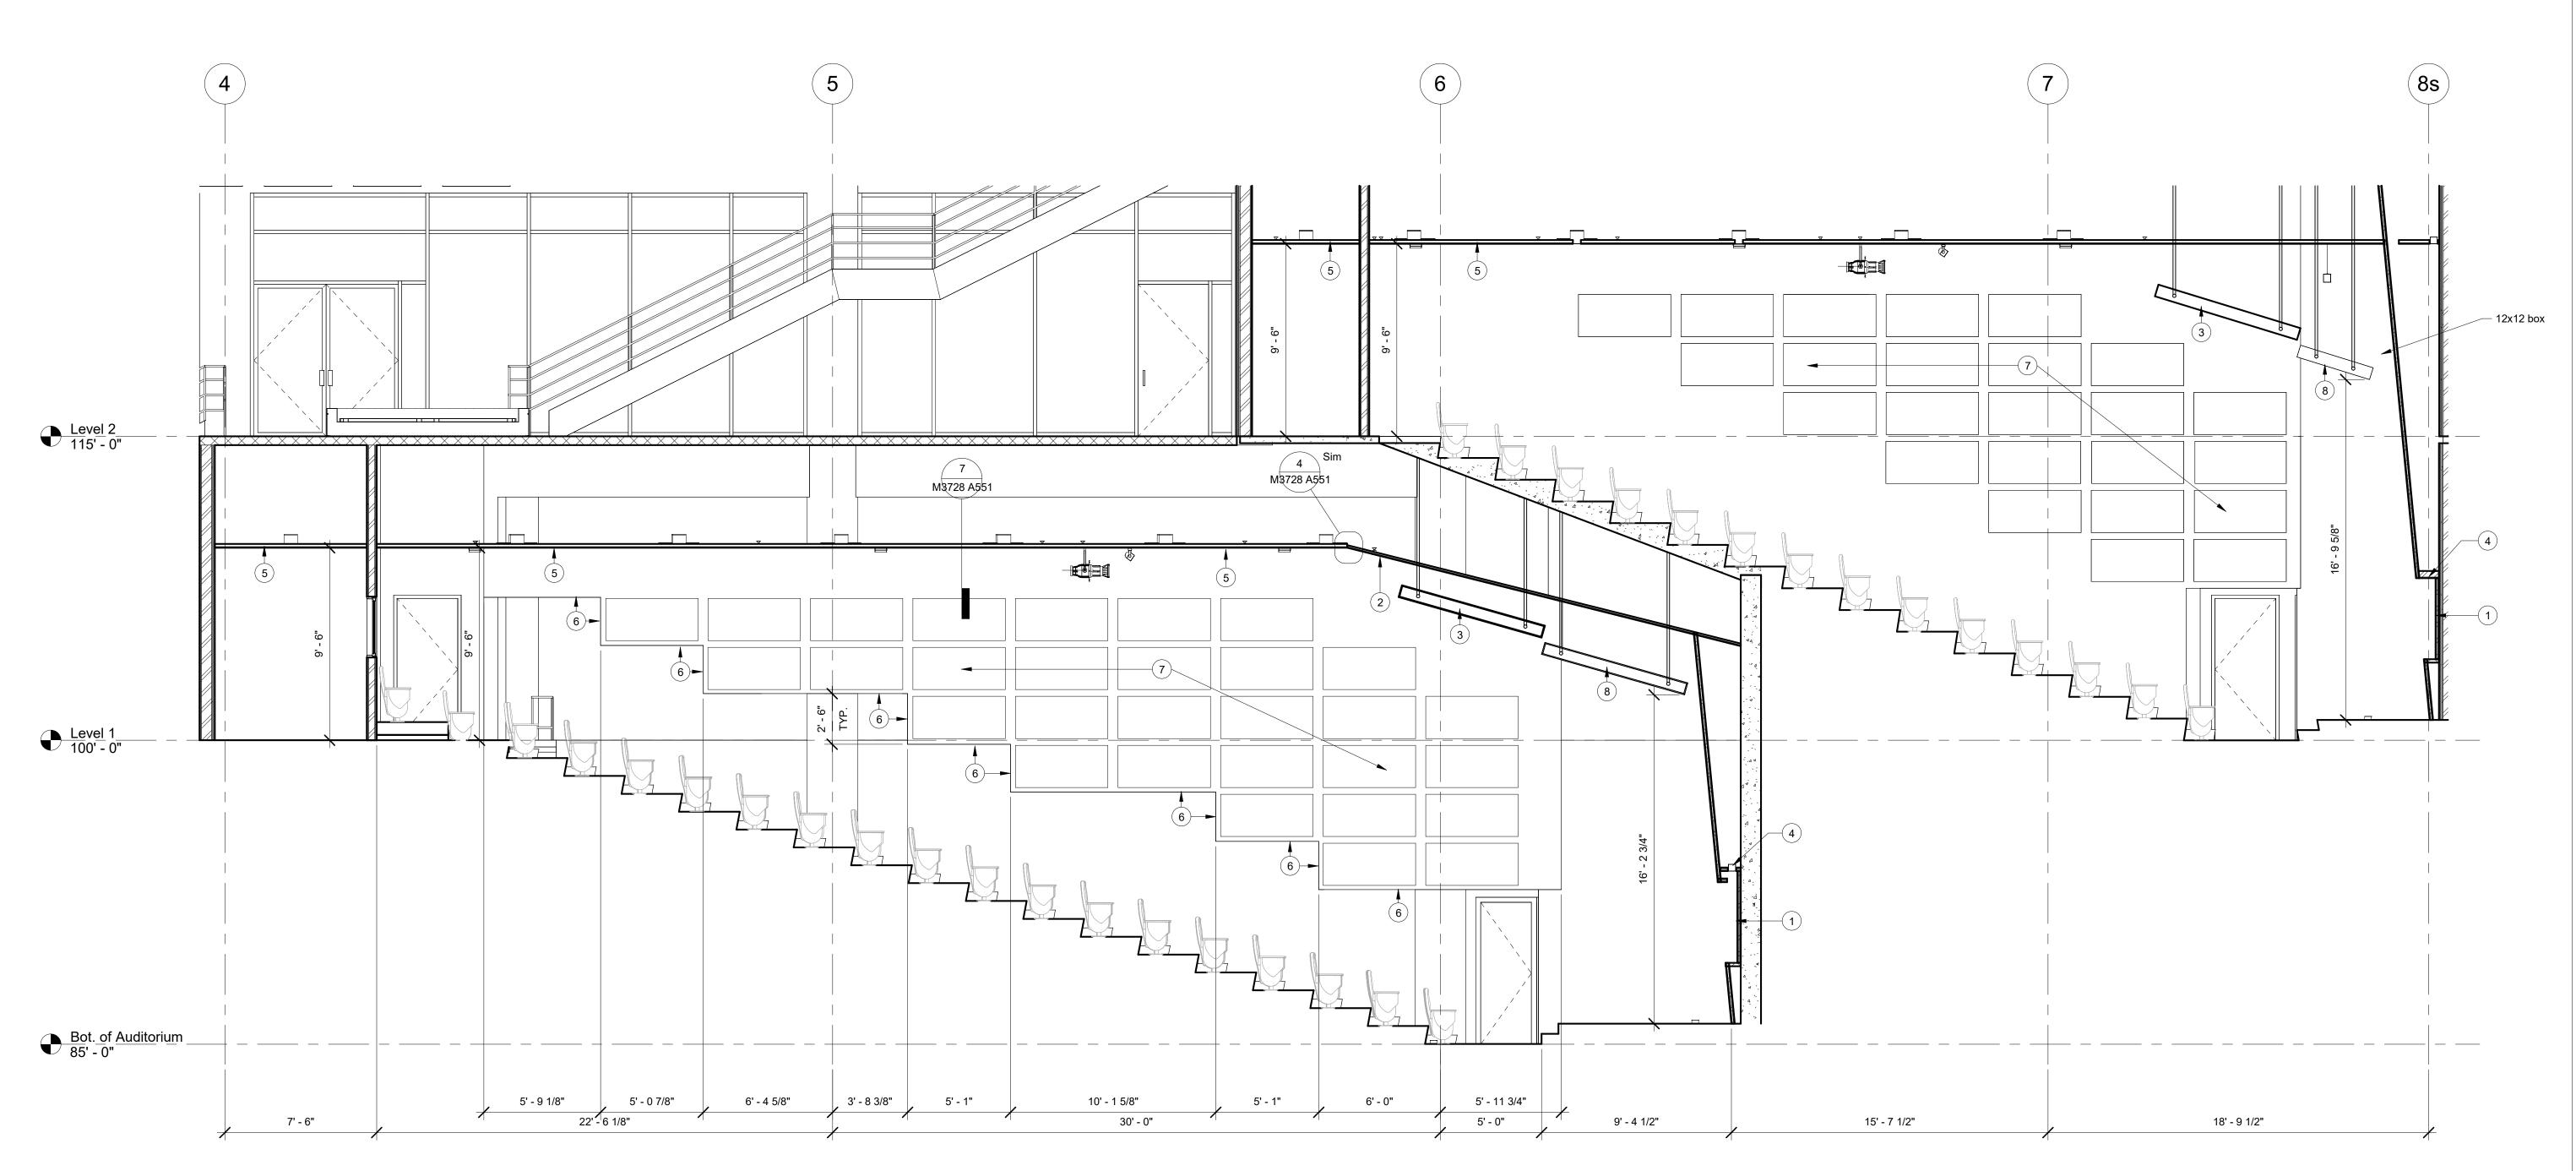

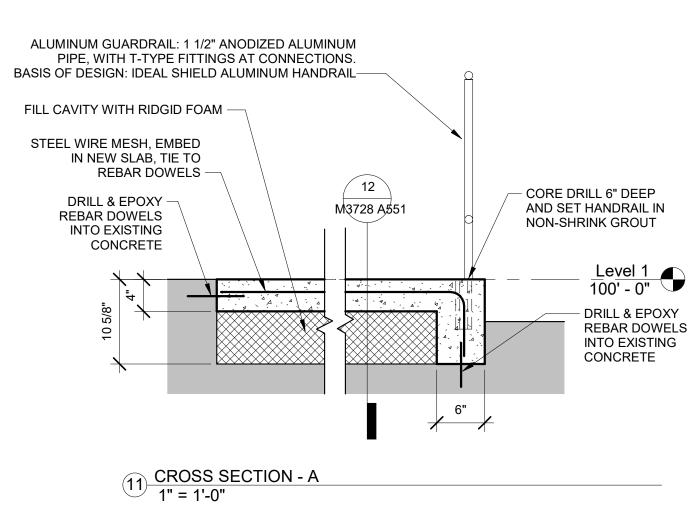

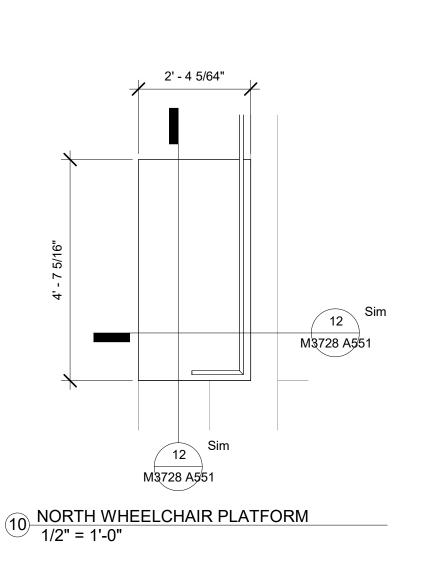


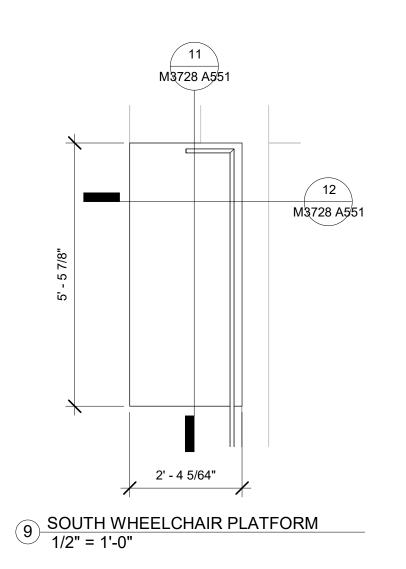


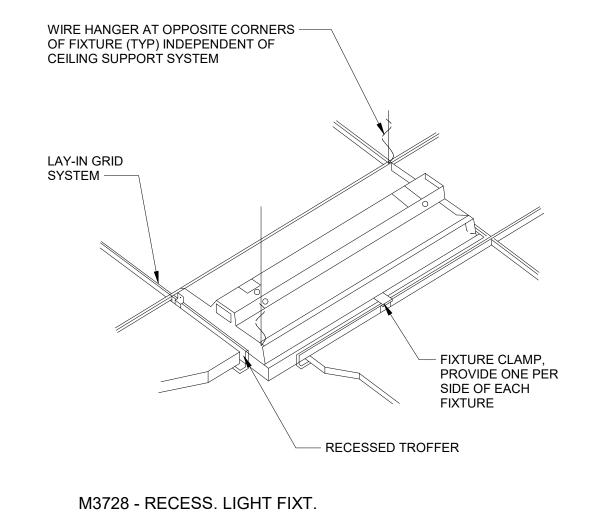


1" = 1'-0"



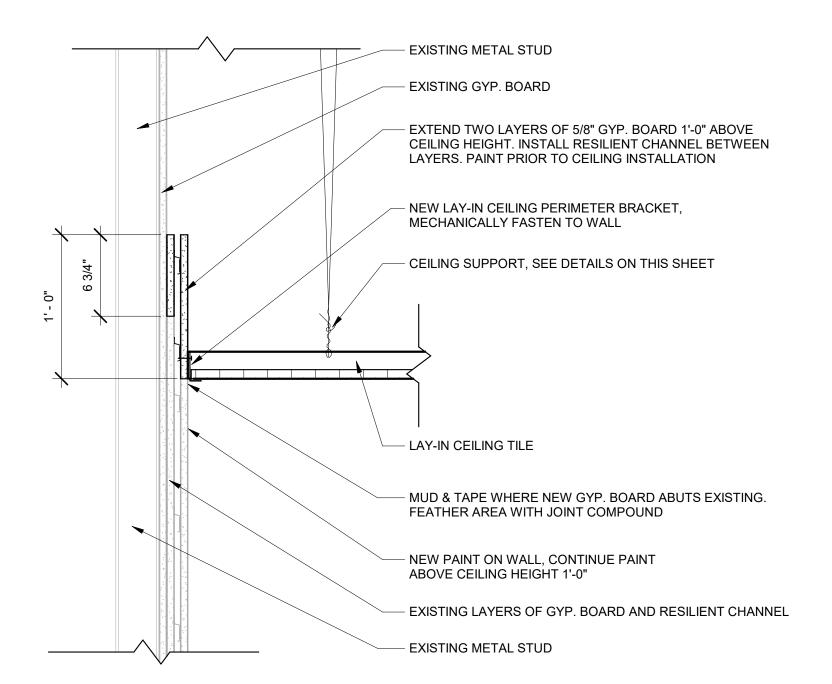

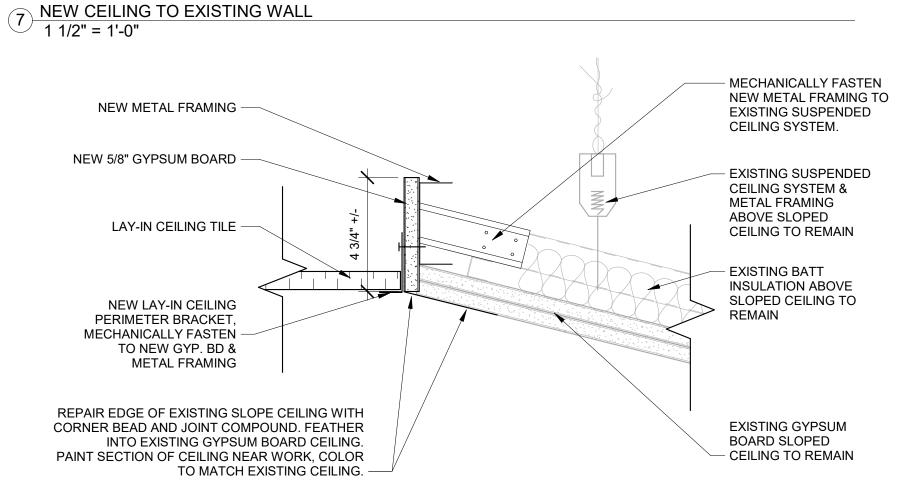


4 EXISTING TO NEW CEILING TRANSITION 3" = 1'-0"

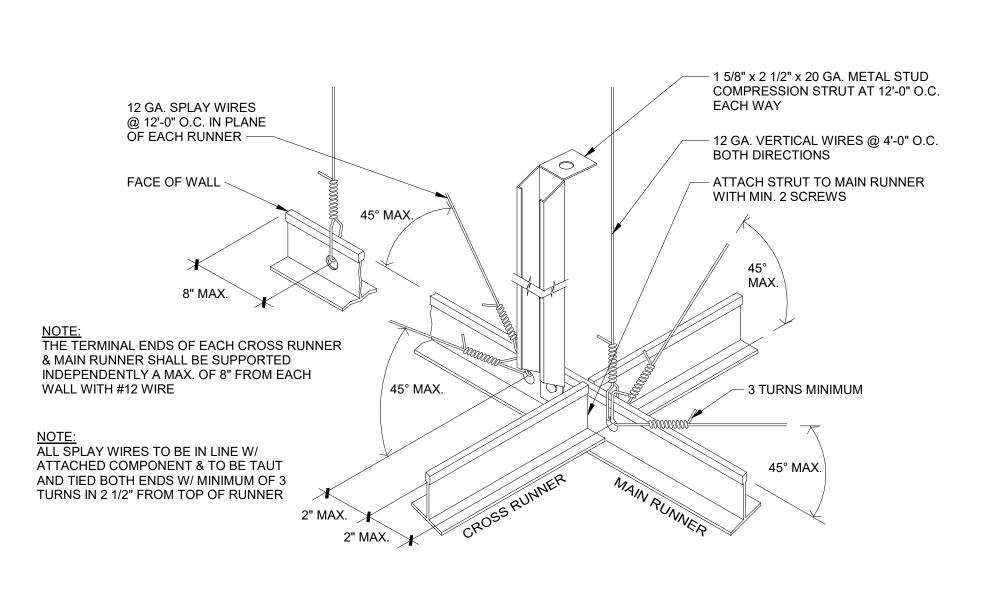


6 M3728 - SEISMIC BRACING 1" = 1'-0"


3 WALL 1" = 1'-0"

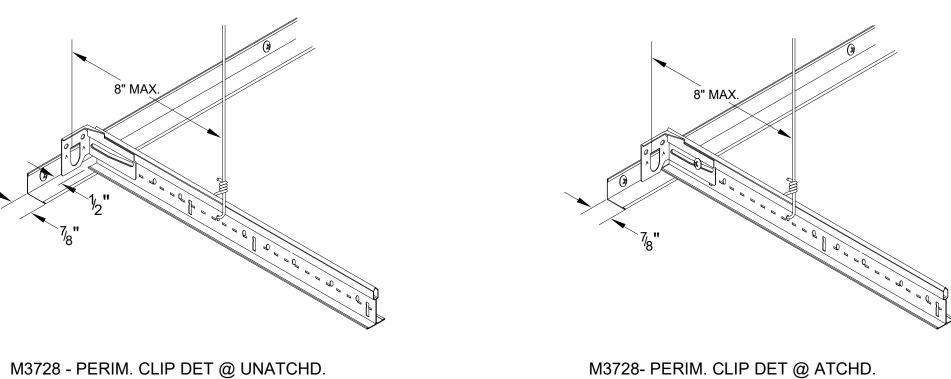

M3728- PERIM. CLIP DET @ ATCHD.

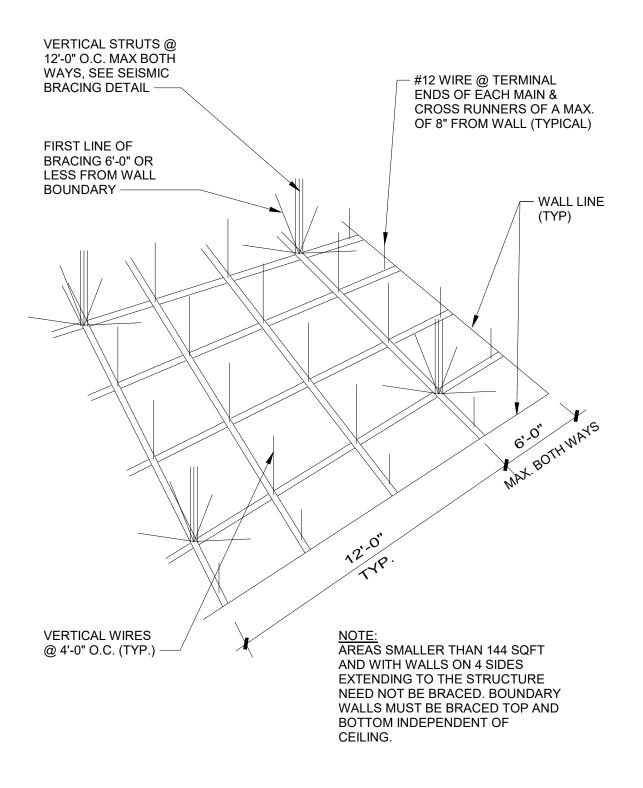

5 M3728 - SEISMIC BRACING LAYOUT 1" = 1'-0"

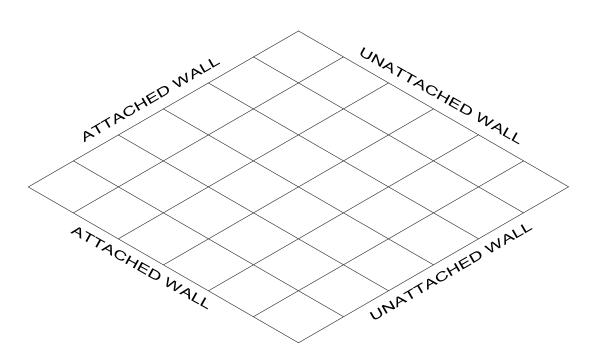

1 M3728 - PERIM. CLIP LAYOUT 1" = 1'-0"



**FACILITIES PLANNING 240 BRWB PROVO, UTAH 84602** PHONE: (801) 422-5504 FAX: (801) 422-0566

		_
DATE:	03/14/24	
DESIGNER:	SW	
DRAWN BY:	SW	_


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**CLIENT APPROVAL** 

PLANNING DIR:

**REVISIONS** 


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**CEILING & FLOOR DETAILS** 

WORK ORDER & SHEET NO.

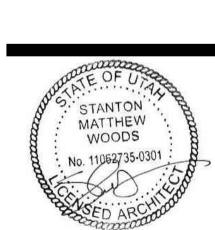M3728



#### **KEYED REFERENCE NOTES**

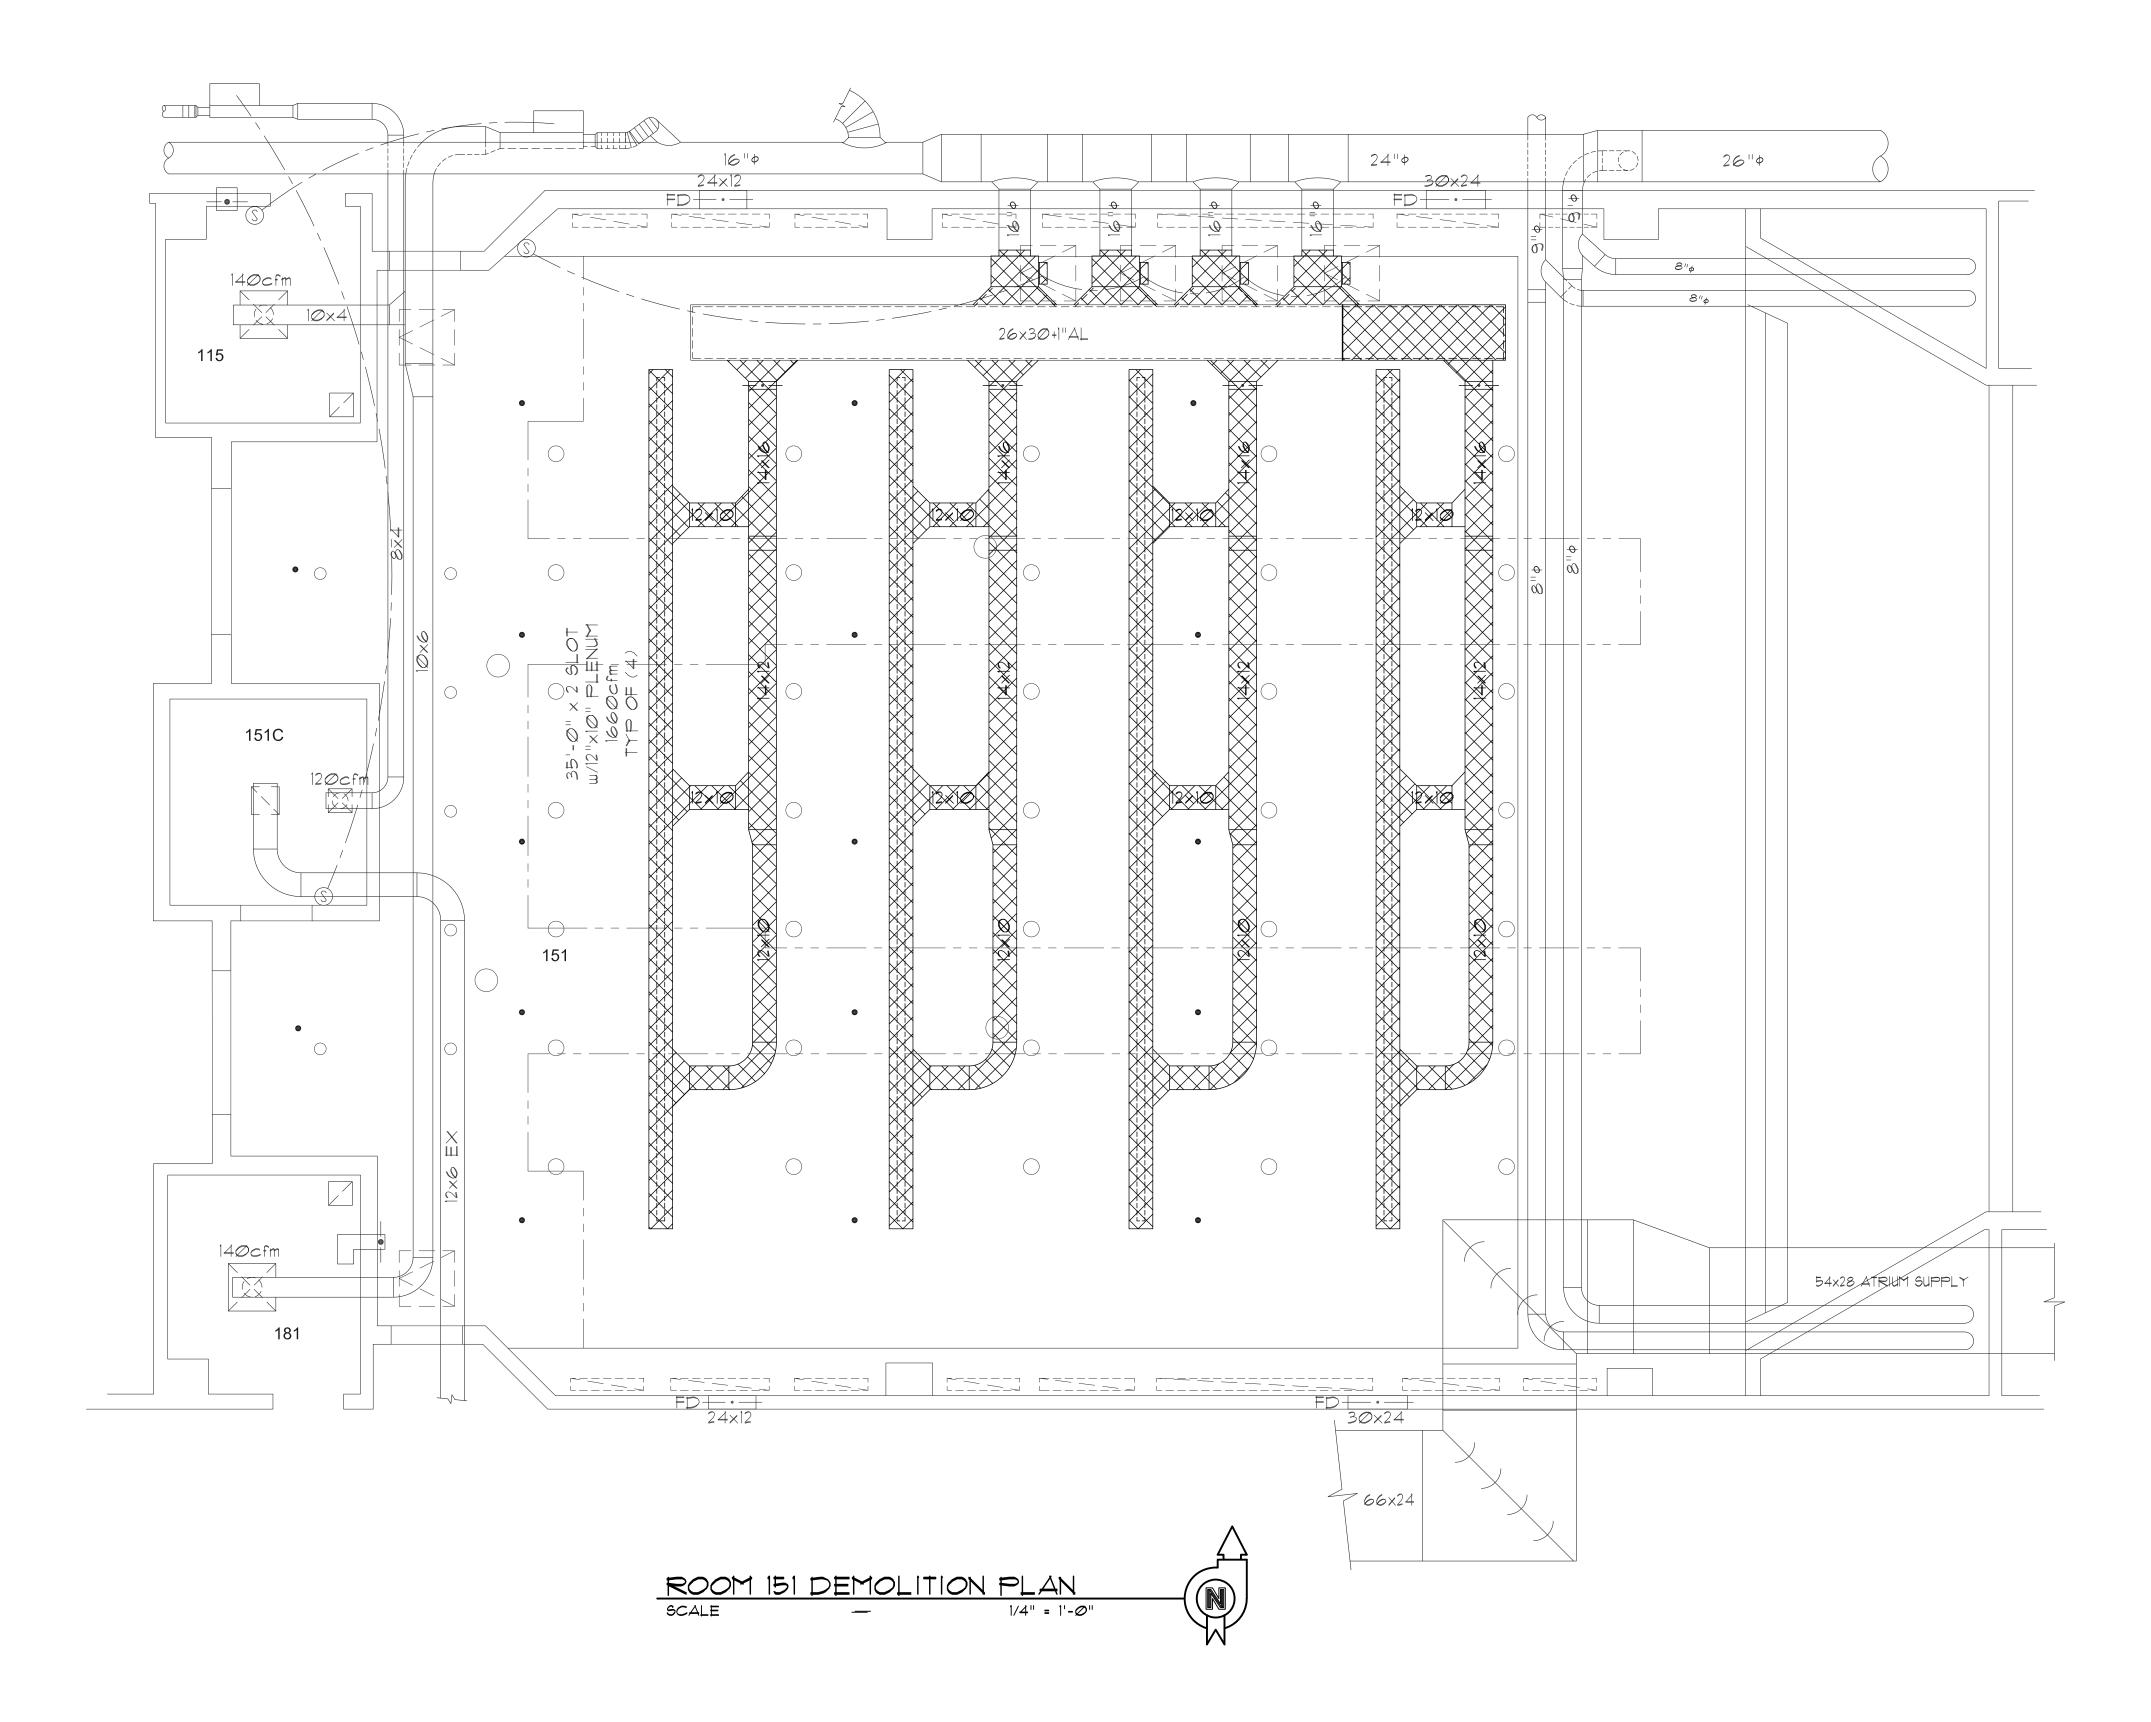DEMO ALL EXISTING DUCTWORK AND COMPONENTS SHOWN AS HATCHED. PATCH AND SEAL REMAINING DUCTWORK TO MAINTAIN A VIABLE AIR DISTRIBUTION

### **GENERAL MECHANICAL NOTES**

- INSULATE ALL NEW OR REPAIRED AND UNLINED SUPPLY AIR DUCTWORK WITH 1" THICK FIBERGLASS INSULATION W/ALUMINUM FOIL SCRIM KRAFT FACING AND A DENSITY OF  $1\frac{1}{2}$  lb/ft $^3$ .
- COORDINATE ALL DIFFUSER LOCATIONS WITH LIGHTING LAYOUT.
- LAY OUT ALL DUCTWORK SUCH THAT DUCT RUN-OUTS or DROPS TO DIFFUSERS ARE ALIGNED TO AVOID UNNECESSARY OFFSETS. USE FLEXIBLE DUCT ONLY WHERE HARD DUCTING IS NOT POSSIBLE. FLEXIBLE DUCT SHALL BE INSTALLED SUCH THAT THE CENTER LINE OF THE DIFFUSER NECK SHALL NOT BE OFFSET FROM THE CENTER LINE OF THE DUCT ELBOW BY MORE THAN ONE DUCT RADIUS. NO MORE THAN 24" MAXIMUM LENGTH OF FLEX DUCT AND NO FLEX DUCT ELBOWS ALLOWED.
- THE JOINTS AND SEAMS OF ALL SUPPLY AIR DUCTWORK SHALL BE SEALED. MASTIC SEALING COMPOUND SHALL BE DURODYNE S-2, 3M EC-750,
- IRON GRIP 601 or HARDCAST TWO-PART SYSTEM II 5. AIR BALANCE ALL DIFFUSERS AND VAY BOXES TO AIR VOLUMES NOTED ON PLANS.
- 6. REFER TO THE ARCHITECTURAL REFLECTED CEILING PLANS FOR THE EXACT LOCATION OF ALL DIFFUSERS, GRILLES, FIRE SPRINKLERS, etc.

VO, UTI **FACILITIES PLANNING** 

240 BRWB PROVO, UTAH 84602 PHONE: (801) 422-5504 FAX: (801) 422-0565

DATE: January 2024 **DESIGNER:** B. Holman DRAWN BY: B. Holman

ADA CHECK:

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**MECHANICAL:** STRUCTURAL: PLANNING DIR:


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**REVISIONS** 

REMODEL AUDITORIUMS 151 PHYSICAL FACILITIES

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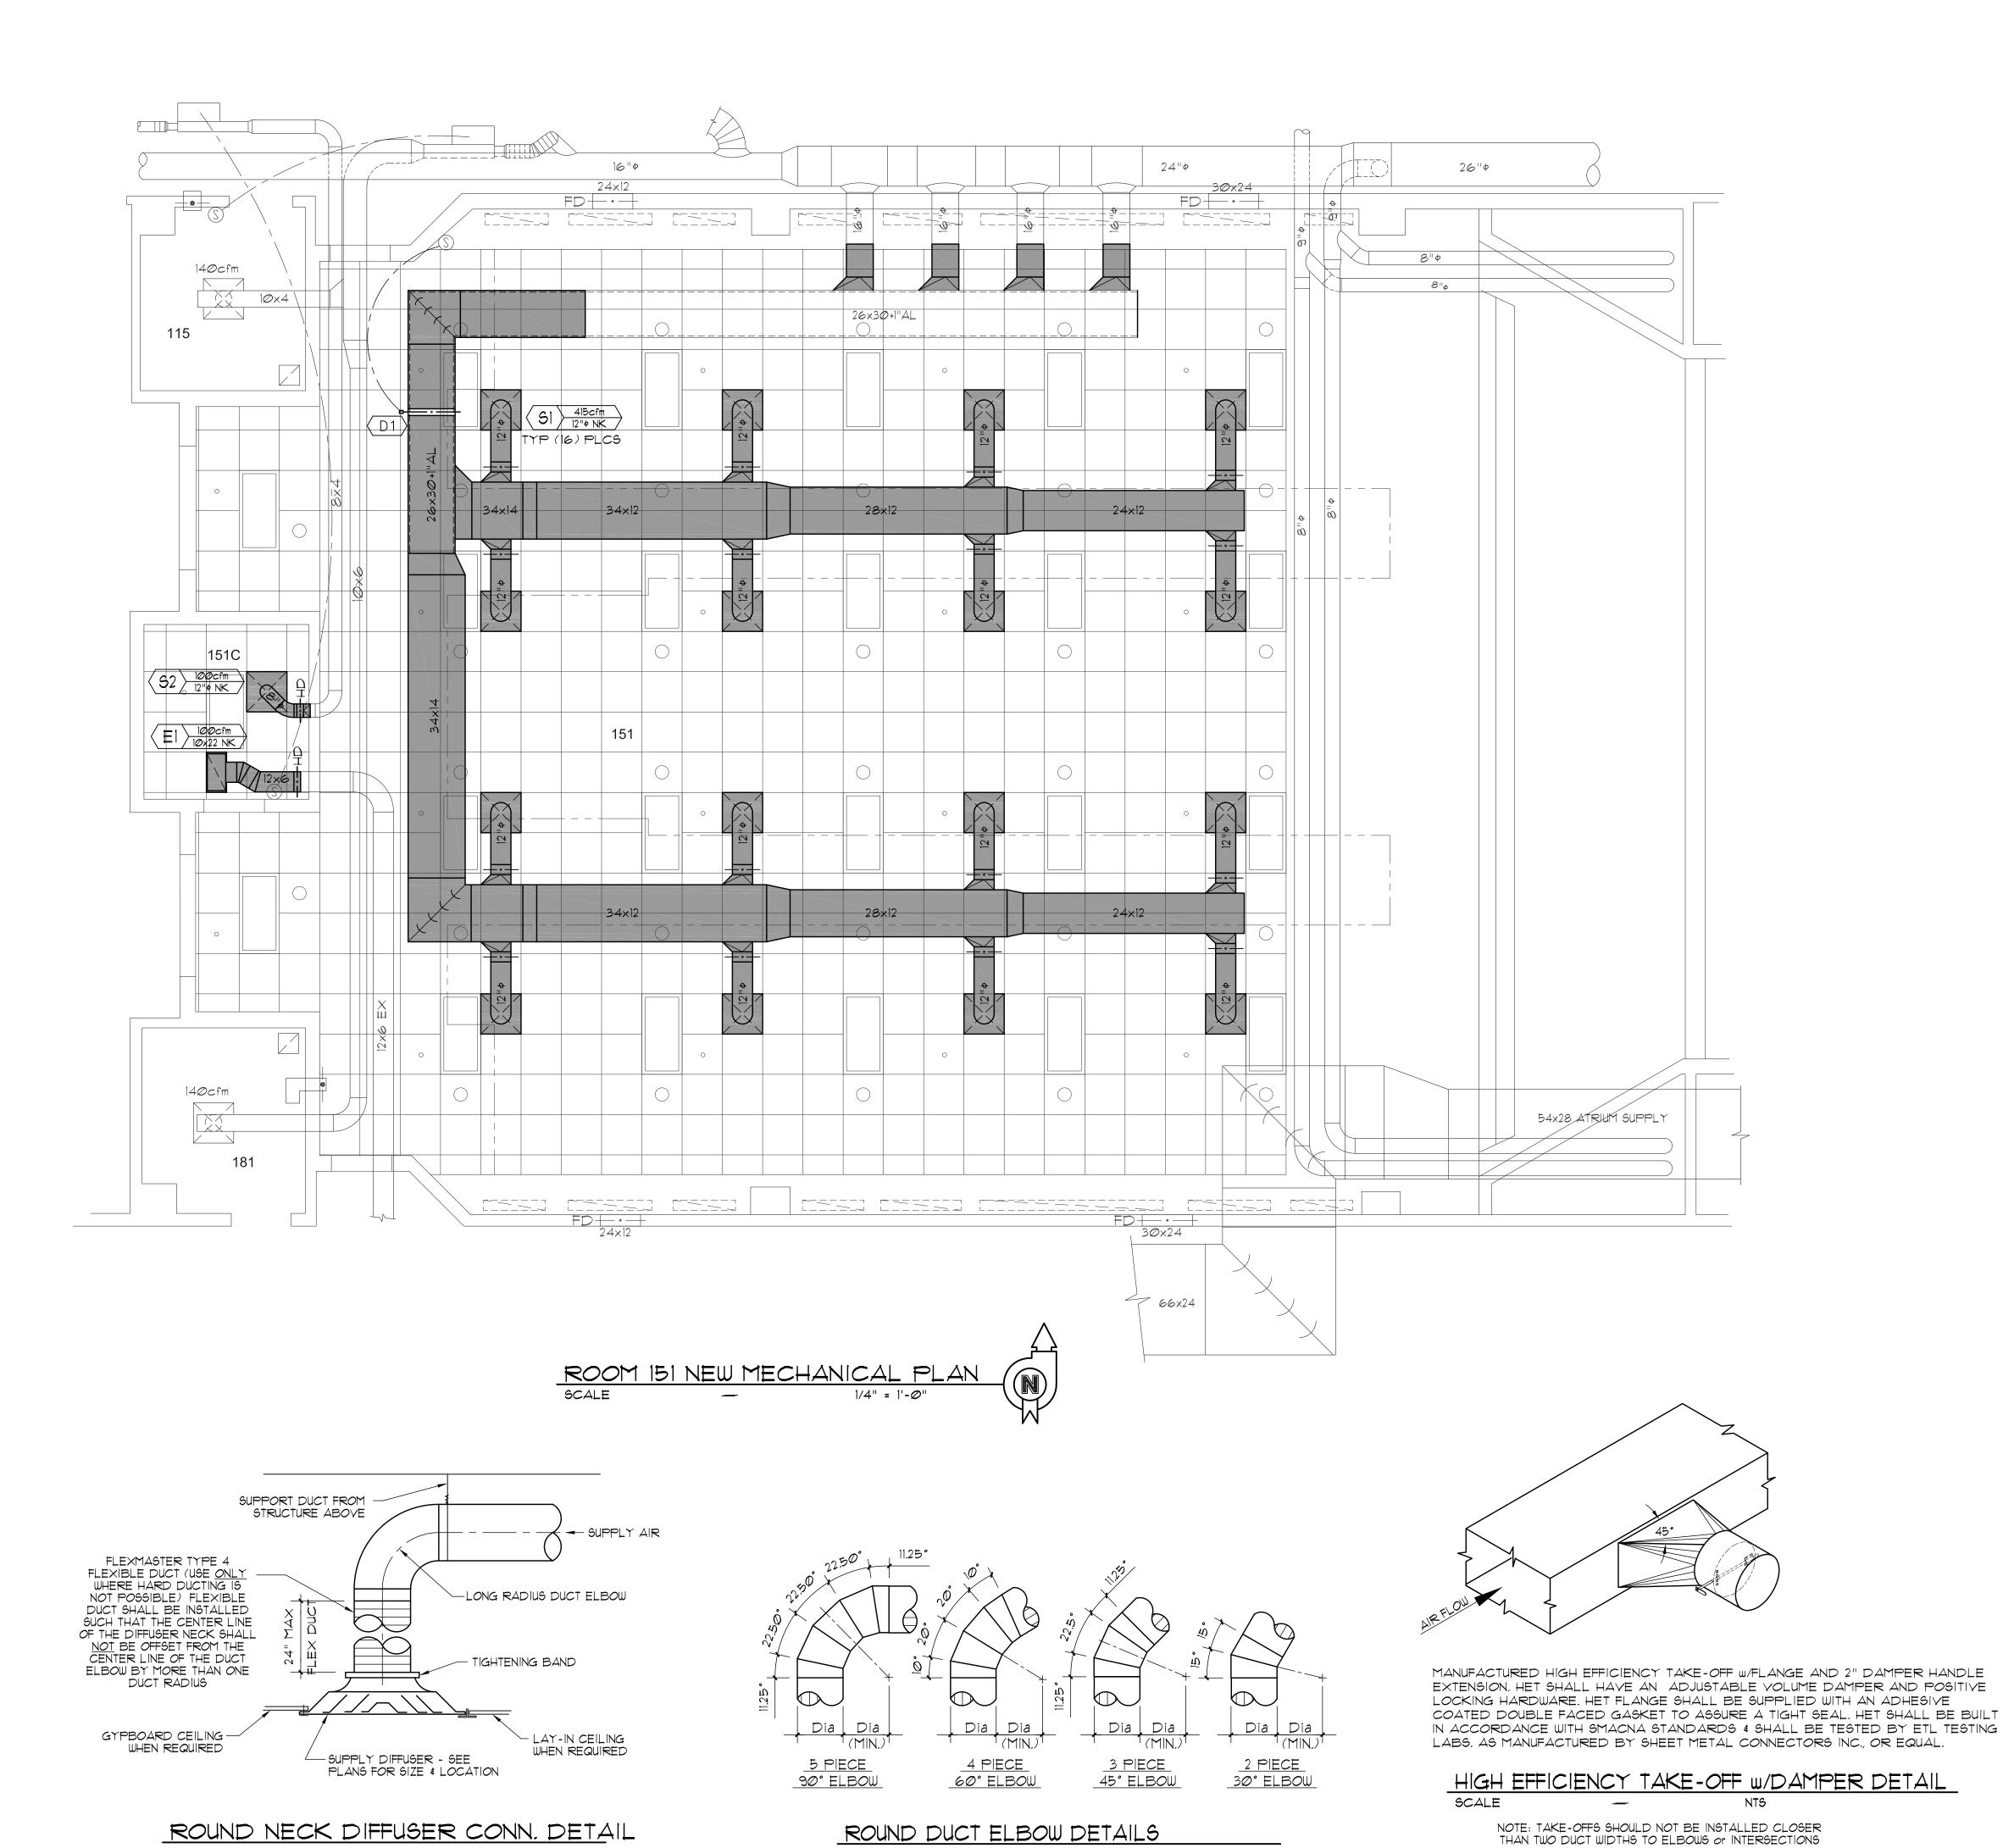
MECHANICAL EQUIPMENT SCHEDULE			
SYM	DESCRIPTION	MFG	CATALOG No.
(S1)	SQUARE SUPPLY DIFFUSER  24" x 24" SQUARE FACE, FRAME TYPE 3 FOR LAY-IN CEILING, ALL STEEL  CONSTRUCTION, WHITE FINISH, ADJUSTABLE VERTICAL-TO-HORIZONTAL  PATTERN CONTROL VANES - NECK SIZE AS PER DRAWINGS	TITUS OR KRUEGER OR PRICE	TMSA 1400A SCDA
S2 >	SQUARE SUPPLY DIFFUSER  24" x 24" SQUARE PLAQUE FACE, FRAME TYPE 3 FOR LAY-IN CEILING,  ALL STEEL CONSTRUCTION, WHITE FINISH NECK SIZE AND DIFFUSER  LOCATION AS PER DRAWINGS	TITUS or KRUEGER or PRICE	OMNI PLQ SPD
E1		TITUS or KRUEGER or PRICE	5ØF EGC5 8Ø SERIES
R1	RETURN AIR GRILLE 24" x 24" or 12" x 24" FACE, FRAME TYPE 3 FOR LAY-IN CEILING, ALL STEEL CONSTRUCTION, WHITE FINISH - NECK SIZE AND GRILLE LOCATION AS PER THIS DRAWING SOUND BOOT DUCTBOARD CAN WITH BAFFLE - 22"x22" or 10"x22" TO MATCH GRILLE	TITUS OR PRICE HERCULES INDUSTRIES	PAR PFRF 5B2222 or 5B2210
(D1)	VARIABLE CONTROL DAMPER  28"w x 32"h (TO FIT IN 26"x30"+1"AL DUCT), OPPOSED BLADE, ALUMINUM  CONSTRUCTION, LOW LEAKAGE, AIRFOIL BLADES w/SEALS	GREENHECK or RUSKIN or TAMCO	VCD 43 CD-50 SERIES 1000
D2	VARIABLE CONTROL DAMPER  28"w x 20"h (TO FIT IN 26"x16"+1"AL DUCT), OPPOSED BLADE, ALUMINUM  CONSTRUCTION, LOW LEAKAGE, AIRFOIL BLADES w/SEALS	GREENHECK OR RUSKIN OR TAMCO	VCD 43 CD-50 SERIES 1000
(3)	TEMPERATURE CONTROL EXISTING STAEFA SMART II	STAEFA	



**DEMOLITION PLAN** AND DETAILS

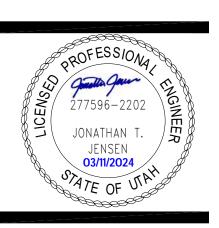WORK ORDER & SHEET NO.

M3728



SCALE

NTS

#### **KEYED REFERENCE NOTES**

RELOCATE EXISTING STAEFA SENSORS TO NEW LOCATIONS AND CONNECT TO NEW OR RELOCATED ) KAMBRASISTING STAEFA PARTS AND SAVE FOR

FUTURE USE.

**GENERAL MECHANICAL NOTES** 

INSULATE ALL NEW OR REPAIRED AND UNLINED

COORDINATE ALL DIFFUSER LOCATIONS WITH

AND A DENSITY OF  $1\frac{1}{2}$  lb/ft<sup>3</sup>.

LIGHTING LAYOUT.

ELBOWS ALLOWED.

SUPPLY AIR DUCTWORK WITH I" THICK FIBERGLASS

INSULATION W/ALUMINUM FOIL SCRIM KRAFT FACING

LAY OUT ALL DUCTWORK SUCH THAT DUCT RUN-OUTS

or DROPS TO DIFFUSERS ARE ALIGNED TO AVOID

UNNECESSARY OFFSETS. USE FLEXIBLE DUCT ONLY WHERE HARD DUCTING IS NOT POSSIBLE. FLEXIBLE

DUCT SHALL BE INSTALLED SUCH THAT THE CENTER

MAXIMUM LENGTH OF FLEX DUCT AND NO FLEX DUCT

LINE OF THE DIFFUSER NECK SHALL NOT BE OFFSET FROM THE CENTER LINE OF THE DUCT ELBOW BY MORE THAN ONE DUCT RADIUS, NO MORE THAN 24"



**FACILITIES PLANNING** 240 BRWB PROVO, UTAH 84602 PHONE: (801) 422-5504

FAX: (801) 422-0565

January 2024 DESIGNER: B. Holman

**DRAWN BY:** B. Holman ADA CHECK:

CODE CHECK: **MECHANICAL:** STRUCTURAL: PLANNING DIR:

CLIENT APPROVAL

4. THE JOINTS AND SEAMS OF ALL SUPPLY AIR DUCTWORK SHALL BE SEALED. MASTIC SEALING COMPOUND SHALL BE DURODYNE S-2, 3M EC-750, IRON GRIP 601 or HARDCAST TWO-PART SYSTEM II.

5. AIR BALANCE ALL DIFFUSERS AND VAY BOXES TO AIR VOLUMES NOTED ON PLANS. 6. REFER TO THE ARCHITECTURAL REFLECTED CEILING

PLANS FOR THE EXACT LOCATION OF ALL DIFFUSERS GRILLES, FIRE SPRINKLERS, etc.

**REVISIONS** 


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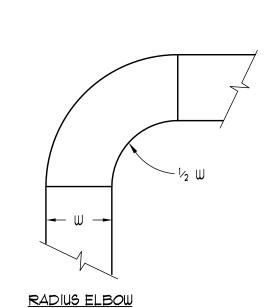
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REMODEL AUDITORIUMS 151 PHYSICAL FACILITIES





ALL DUCTS (SUPPLY, RETURN, AND EXHAUST) SHALL HAVE TURNING VANES IN SQUARE ELBOWS

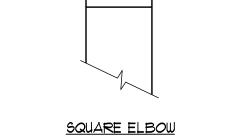

ONE SIDE

RADIUS ELBOW INSIDE SQUARE-OUTSIDE RADIUS ELBOWS SHALL NOT BE ALLOWED


RECTANGULAR DUCT FITTINGS




**NEW MECHANICAL PLAN AND SCHEDULE** 

WORK ORDER & SHEET NO.

M3728

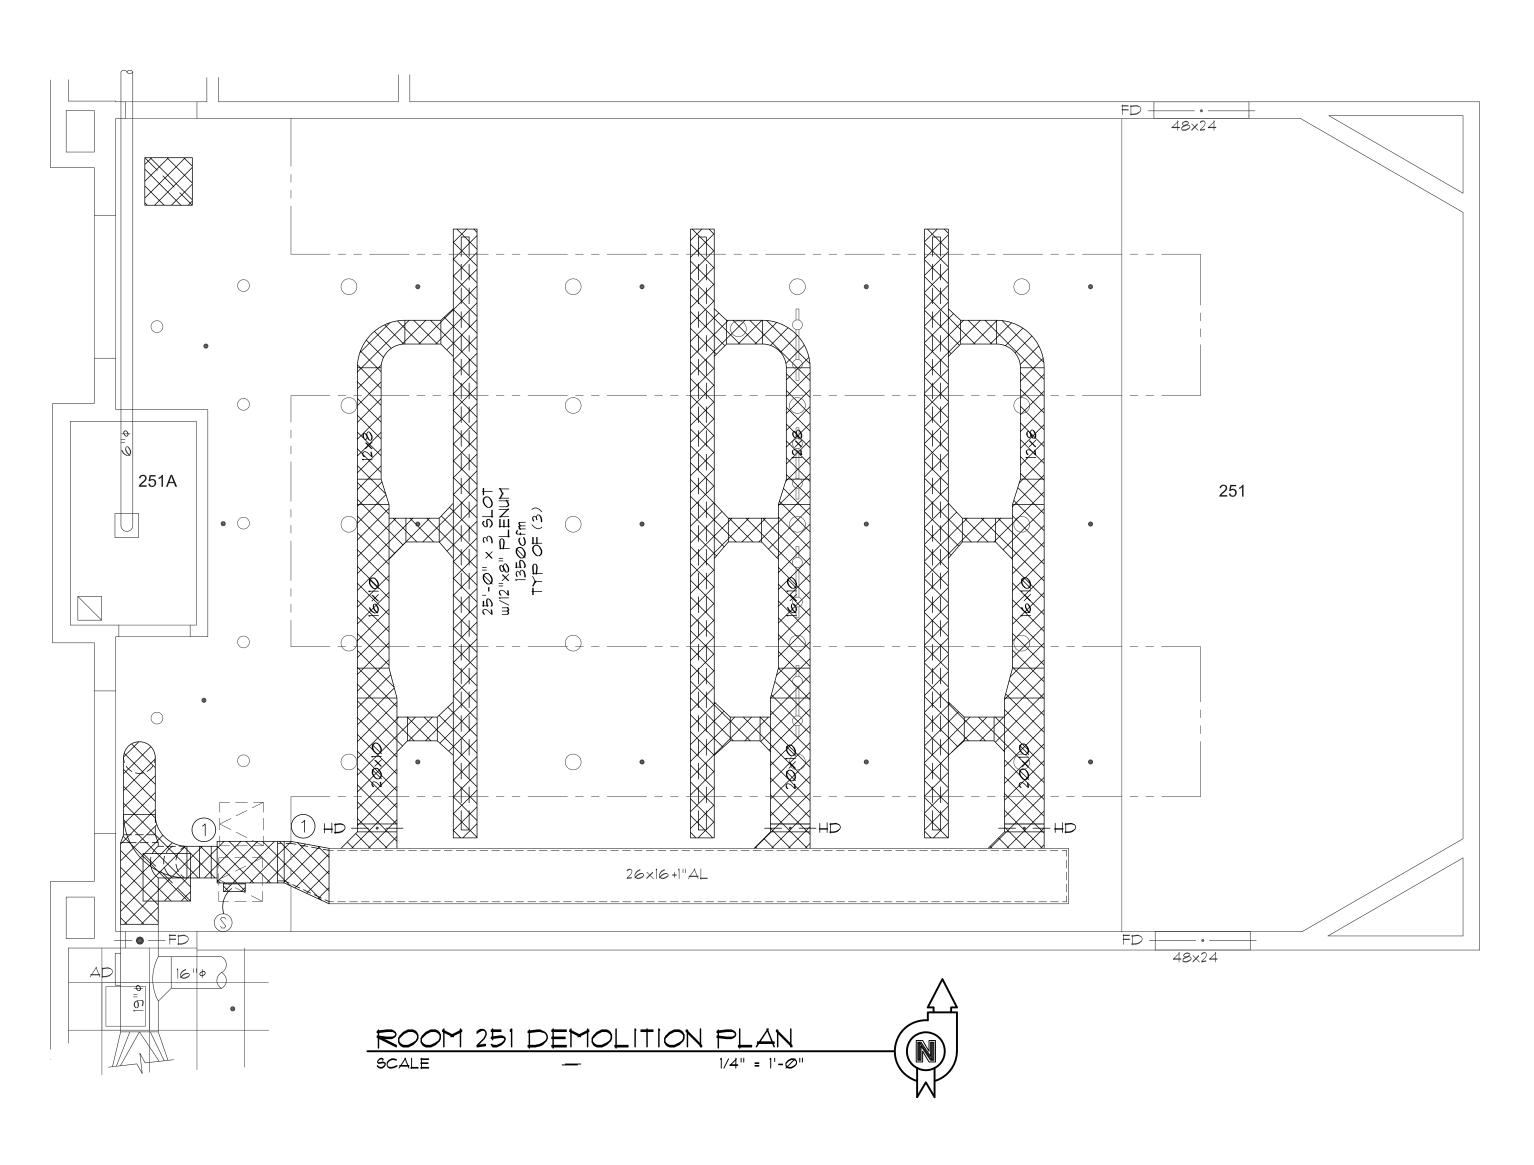

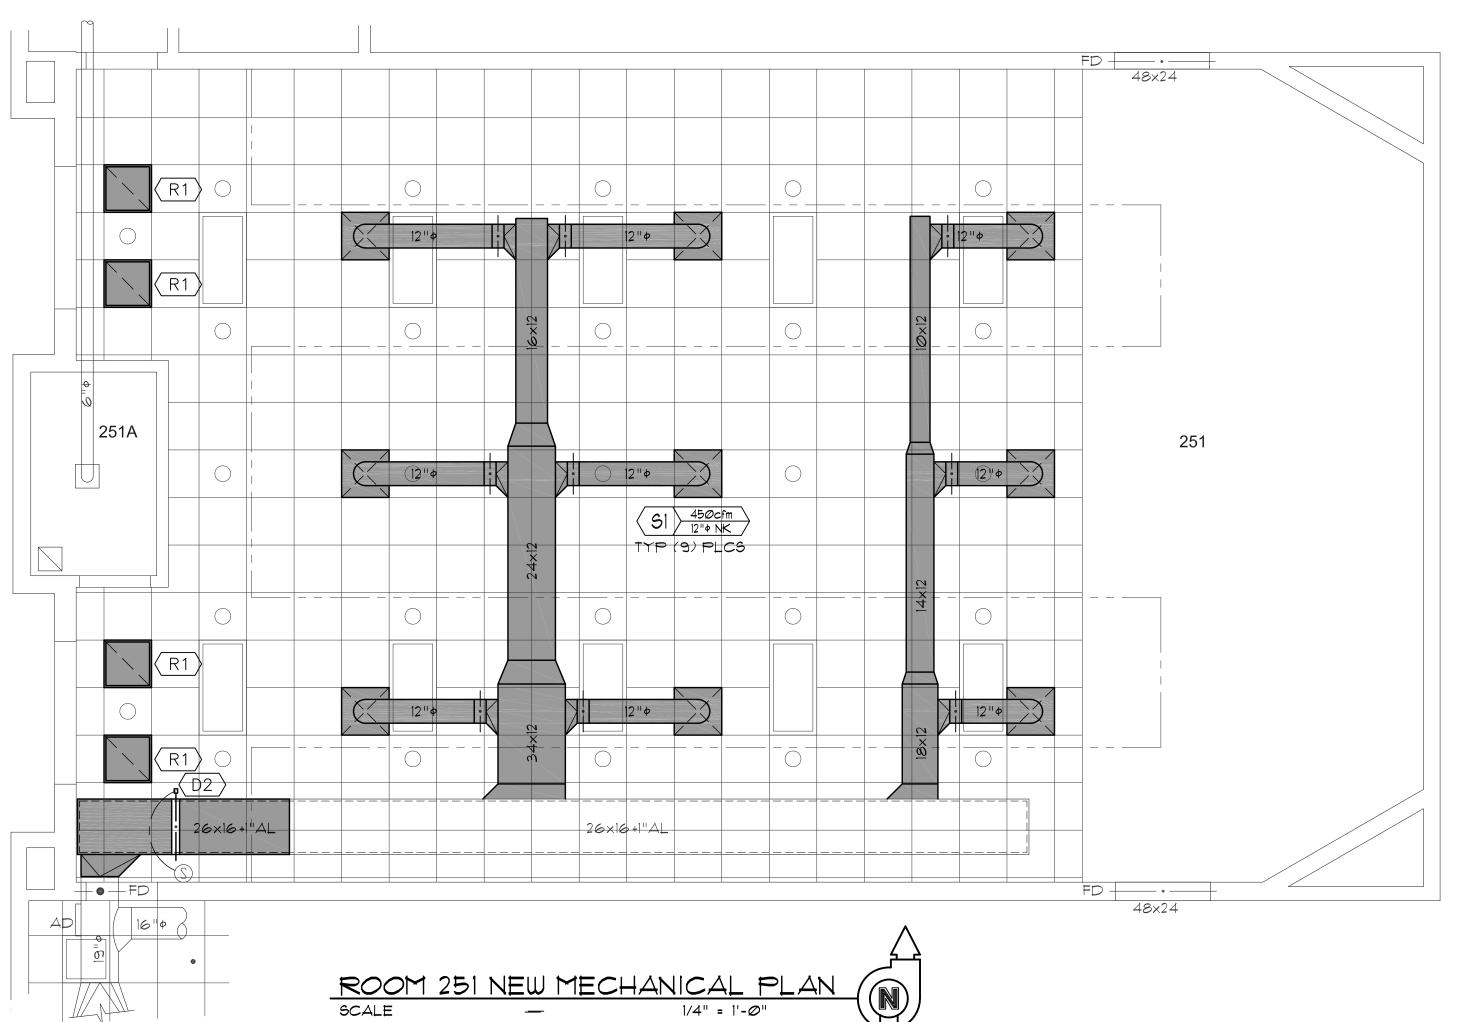

#### **KEYED REFERENCE NOTES**

- 1) STACKED 16" + INLET ANEMOSTAT VAV BOXES TRANSITIONED TO 26" X16" DUCT. DEMO VAV BOXES, TRANSITION, AND SUPPLY DUCTWORK SHOWN AS HATCHED.
- 2 DEMO ALL EXISTING DUCTWORK AND COMPONENTS SHOWN AS HATCHED. PATCH AND SEAL REMAINING DUCTWORK TO MAINTAIN A VIABLE AIR DISTRIBUTION SYSTEM.

**GENERAL MECHANICAL NOTES** 

INSULATE ALL NEW OR REPAIRED AND UNLINED

COORDINATE ALL DIFFUSER LOCATIONS WITH

AND A DENSITY OF  $1\frac{1}{2}$   $16/ft^3$ .

LIGHTING LAYOUT.

ELBOWS ALLOWED.

SUPPLY AIR DUCTWORK WITH I" THICK FIBERGLASS INSULATION W/ALUMINUM FOIL SCRIM KRAFT FACING

3. LAY OUT ALL DUCTWORK SUCH THAT DUCT RUN-OUTS

or DROPS TO DIFFUSERS ARE ALIGNED TO AVOID

FROM THE CENTER LINE OF THE DUCT ELBOW BY MORE THAN ONE DUCT RADIUS. NO MORE THAN 24" MAXIMUM LENGTH OF FLEX DUCT AND NO FLEX DUCT

UNNECESSARY OFFSETS. USE FLEXIBLE DUCT ONLY

WHERE HARD DUCTING IS NOT POSSIBLE. FLEXIBLE DUCT SHALL BE INSTALLED SUCH THAT THE CENTER LINE OF THE DIFFUSER NECK SHALL NOT BE OFFSET

# FOUNDED FOUNDED BYU 1875 1875 1875

FACILITIES PLANNING

240 BRWB PROVO, UTAH 84602
PHONE: (801) 422-5504
FAX: (801) 422-0565

DATE: January 2024

DESIGNER: B. Holman

DRAWN BY: B. Holman

ADA CHECK:

CODE CHECK:

MECHANICAL:

STRUCTURAL:

PLANNING DIR:

CLIENT APPROVAL DATE

4. THE JOINTS AND SEAMS OF ALL SUPPLY AIR
DUCTWORK SHALL BE SEALED. MASTIC SEALING
COMPOUND SHALL BE DURODYNE S-2, 3M EC-150,
IRON GRIP 601 OF HARDCAST TWO-PART SYSTEM II.
5. AIR BALANCE ALL DIFFUSERS AND VAY BOXES TO

AIR VOLUMES NOTED ON PLANS.

6. REFER TO THE ARCHITECTURAL REFLECTED CEILING PLANS FOR THE EXACT LOCATION OF ALL DIFFUSERS, GRILLES, FIRE SPRINKLERS, etc.


REVISIONS

REVISIONS

RIGHAM YOUNG University

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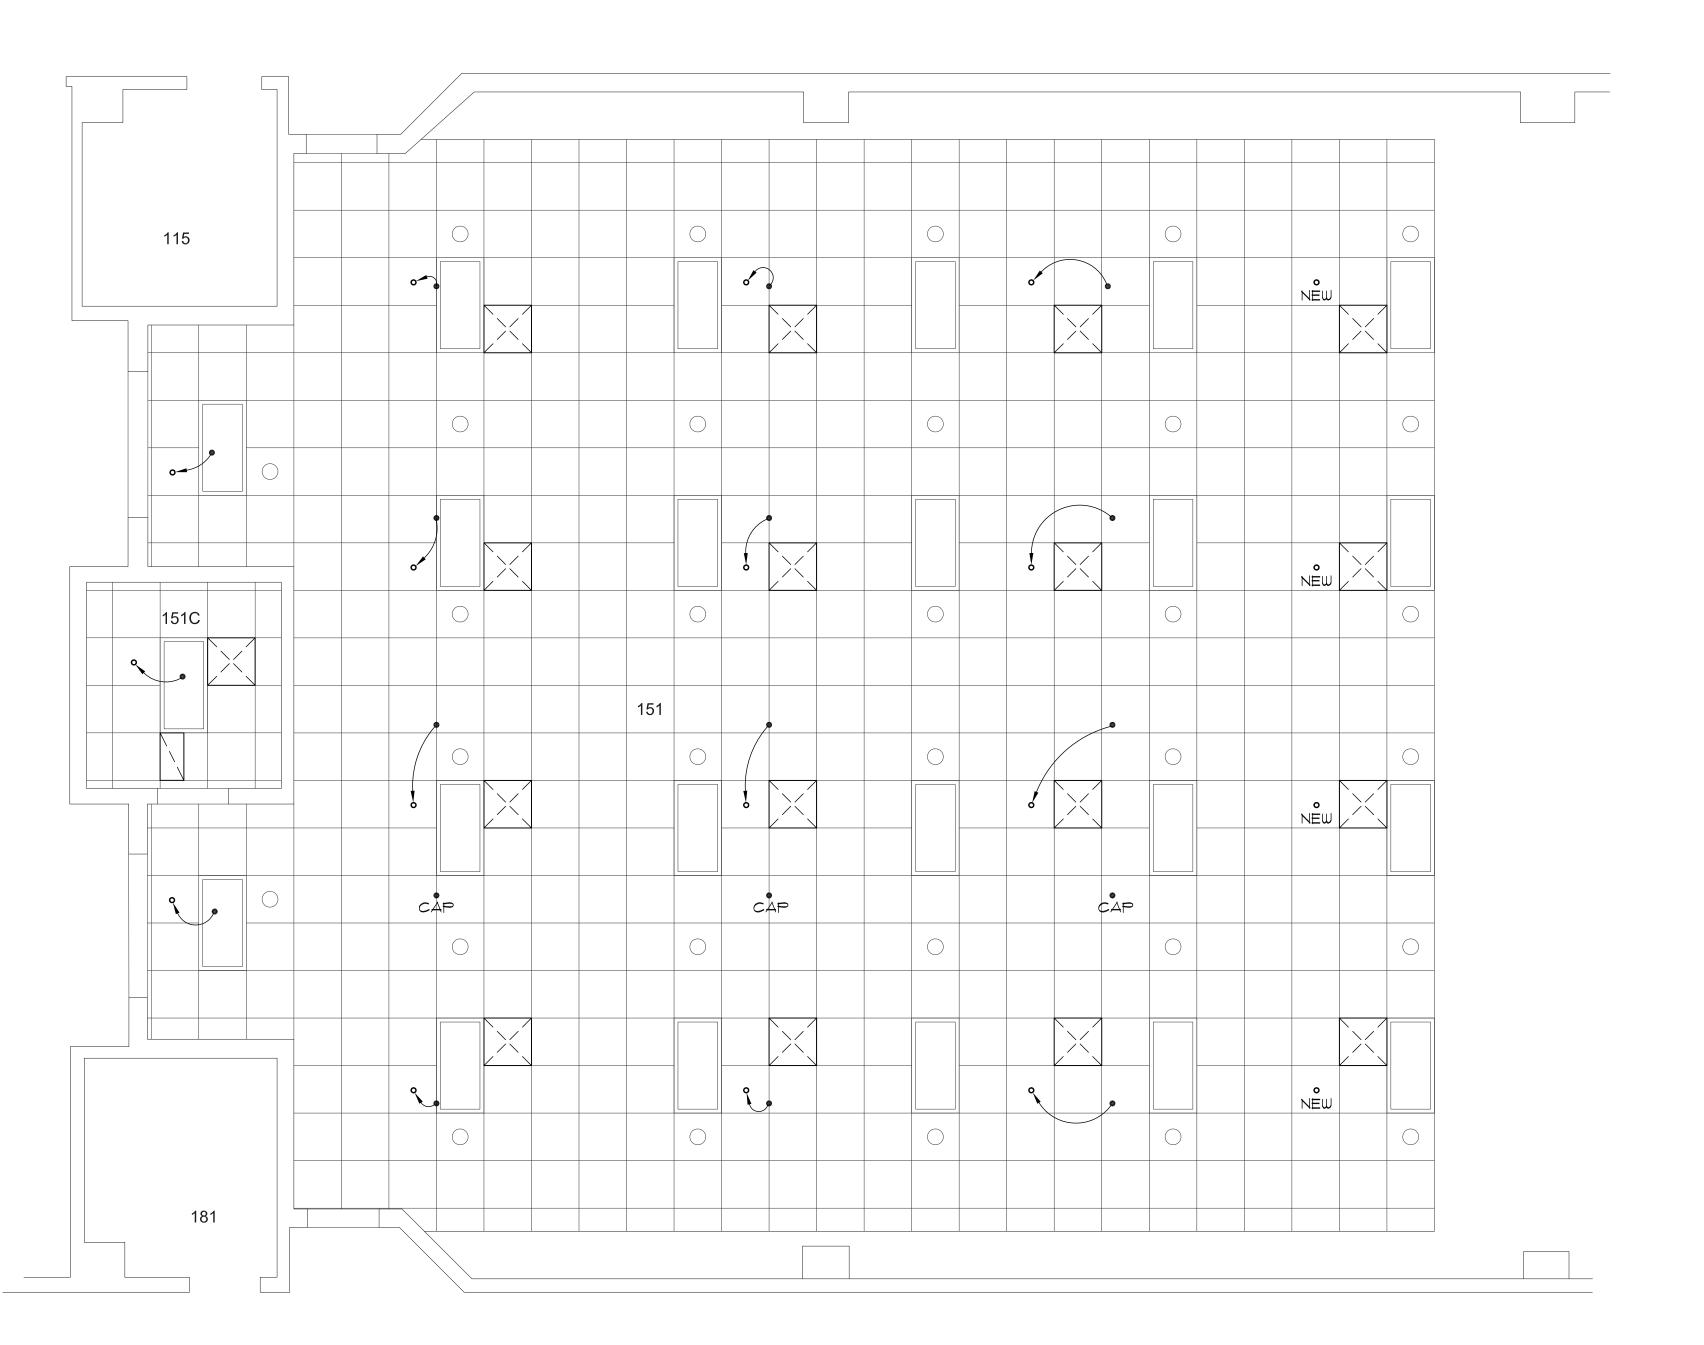
REMODEL AUDITORIUMS 151
PHYSICAL FACILITIES
N. ELDON TANNER BUILDING (TNRB)

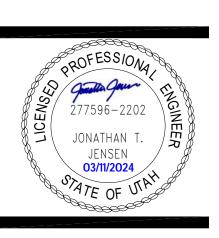

DEMOLITION & NEW
MECHANICAL PLANS
AND SCHEDULES

WORK ORDER & SHEET NO.

M3728 M1.3



ROOM 151 FIRE SPRINKLING PLAN

SCALE - 1/4" = 1'-0"

#### FIRE SPRINKLING NOTES

- FIRE SPRINKLING CONTRACTOR SHALL FIELD VERIFY ALL EXISTING CONDITIONS AND FAMILIARIZE THEMSELVES WITH THE INTENT OF THE NEW FIRE SPRINKLING INSTALLATION PRIOR TO SUBMITTING A BID ON THIS PROJECT.
- INSTALL NEW FIRE SPRINKLER HEADS, AS CLOSE AS POSSIBLE, IN LOCATIONS SHOWN.
- 3. ALL NEW SPRINKLER HEADS INSTALLED IN CEILING SHALL BE VICTAULIC CONCEALED TYPE MODEL V38. 4. COORDINATE EXACT LOCATIONS OF ALL NEW HEADS WITH STRUCTURE, HYAC PIPING, DUCTWORK, LIGHTING, ELECTRICAL CONDUITS, etc. INSTALL ALL NEW SPRINKLER HEADS IN CENTER OF GRID IN LAY-IN CEILINGS UNLESS OTHERWISE APPROVED.
- 5. FIRE SPRINKLING TECHNICIAN SHALL INVESTIGATE EXISTING CONDITIONS AND PIPE INSTALLATION AND DESIGN NEW FIRE SPRINKLING SYSTEM ACCORDING TO THE NFPA NATIONAL FIRE CODE, ORDINARY HAZARD PIPE SCHEDULE. CONTRACTOR SHALL PROVIDE SUBMITTALS FOR ALL COMPONENTS AND PROVIDE HYDRAULIC CALCULATIONS PRIOR TO INSTALLATION.
- 6. UPGRADE SEISMIC BRACING OF ANY NEW OR MODIFIED SPRINKLER PIPING AS PER MOST RECENTLY ADOPTED VERSION OF NFPA NATIONAL FIRE CODE.

#### FIRE SPRINKLING LEGEND

- EXISTING SPRINKLER HEAD
- RELOCATED, RECESSED HEAD



**240 BRWB PROVO, UTAH 84602** PHONE: (801) 422-5504

FAX: (801) 422-0565

DATE: January 2024 **DESIGNER:** B. Holman

DRAWN BY: B. Holman

ADA CHECK: CODE CHECK: MECHANICAL: STRUCTURAL: PLANNING DIR:

CLIENT APPROVAL

**REVISIONS** 

Z S BRIGHAM


REMODEL AUDITORIUMS 151
PHYSICAL FACILITIES
N. ELDON TANNER BUILDING (TNRB)


JONATHAN T. JENSEN 03/11/2024

NEW 1st & 2nd **LEVEL FIRE SPRINKLING PLANS** 

WORK ORDER & SHEET NO.

M3728 **M2.1** 

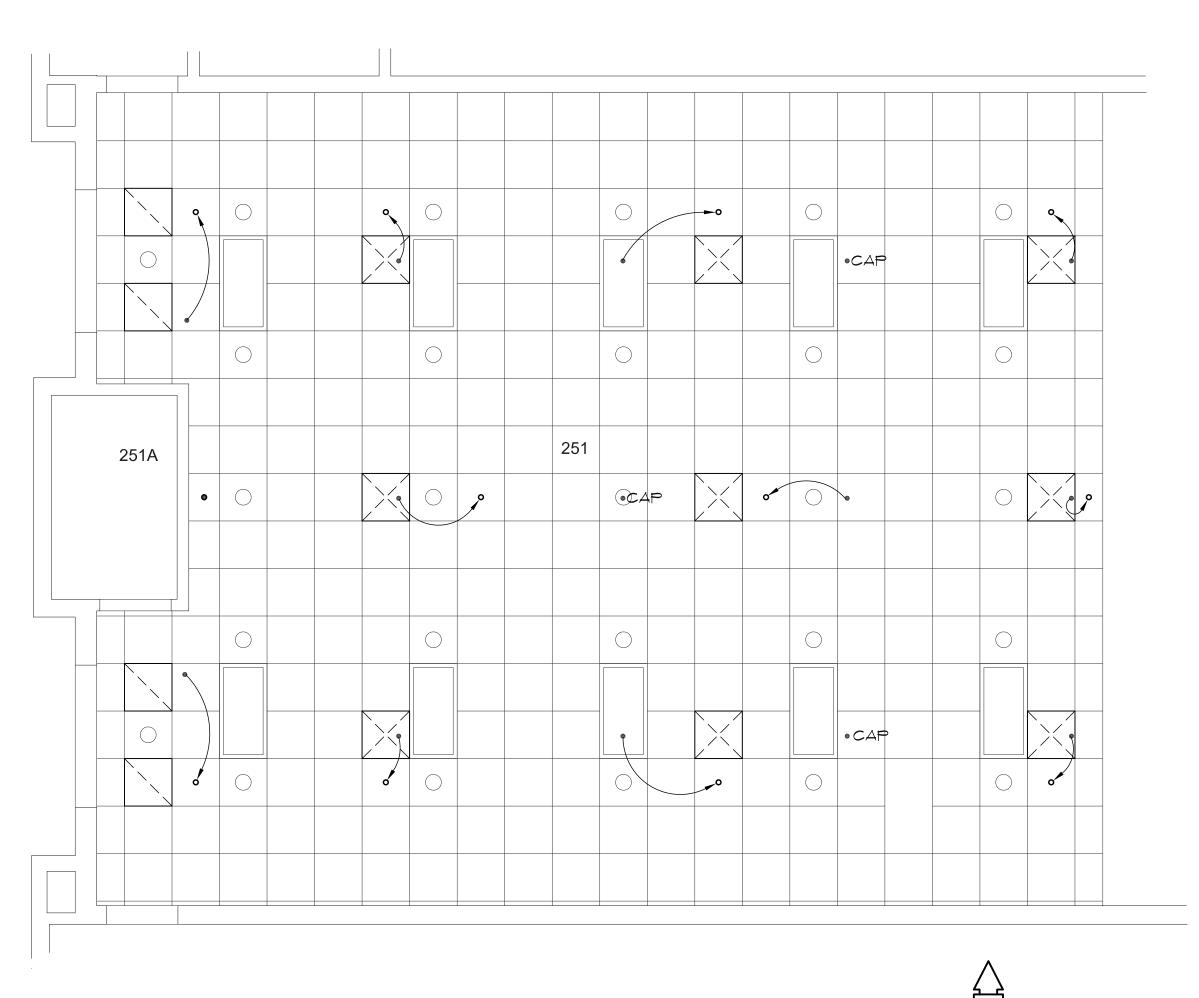

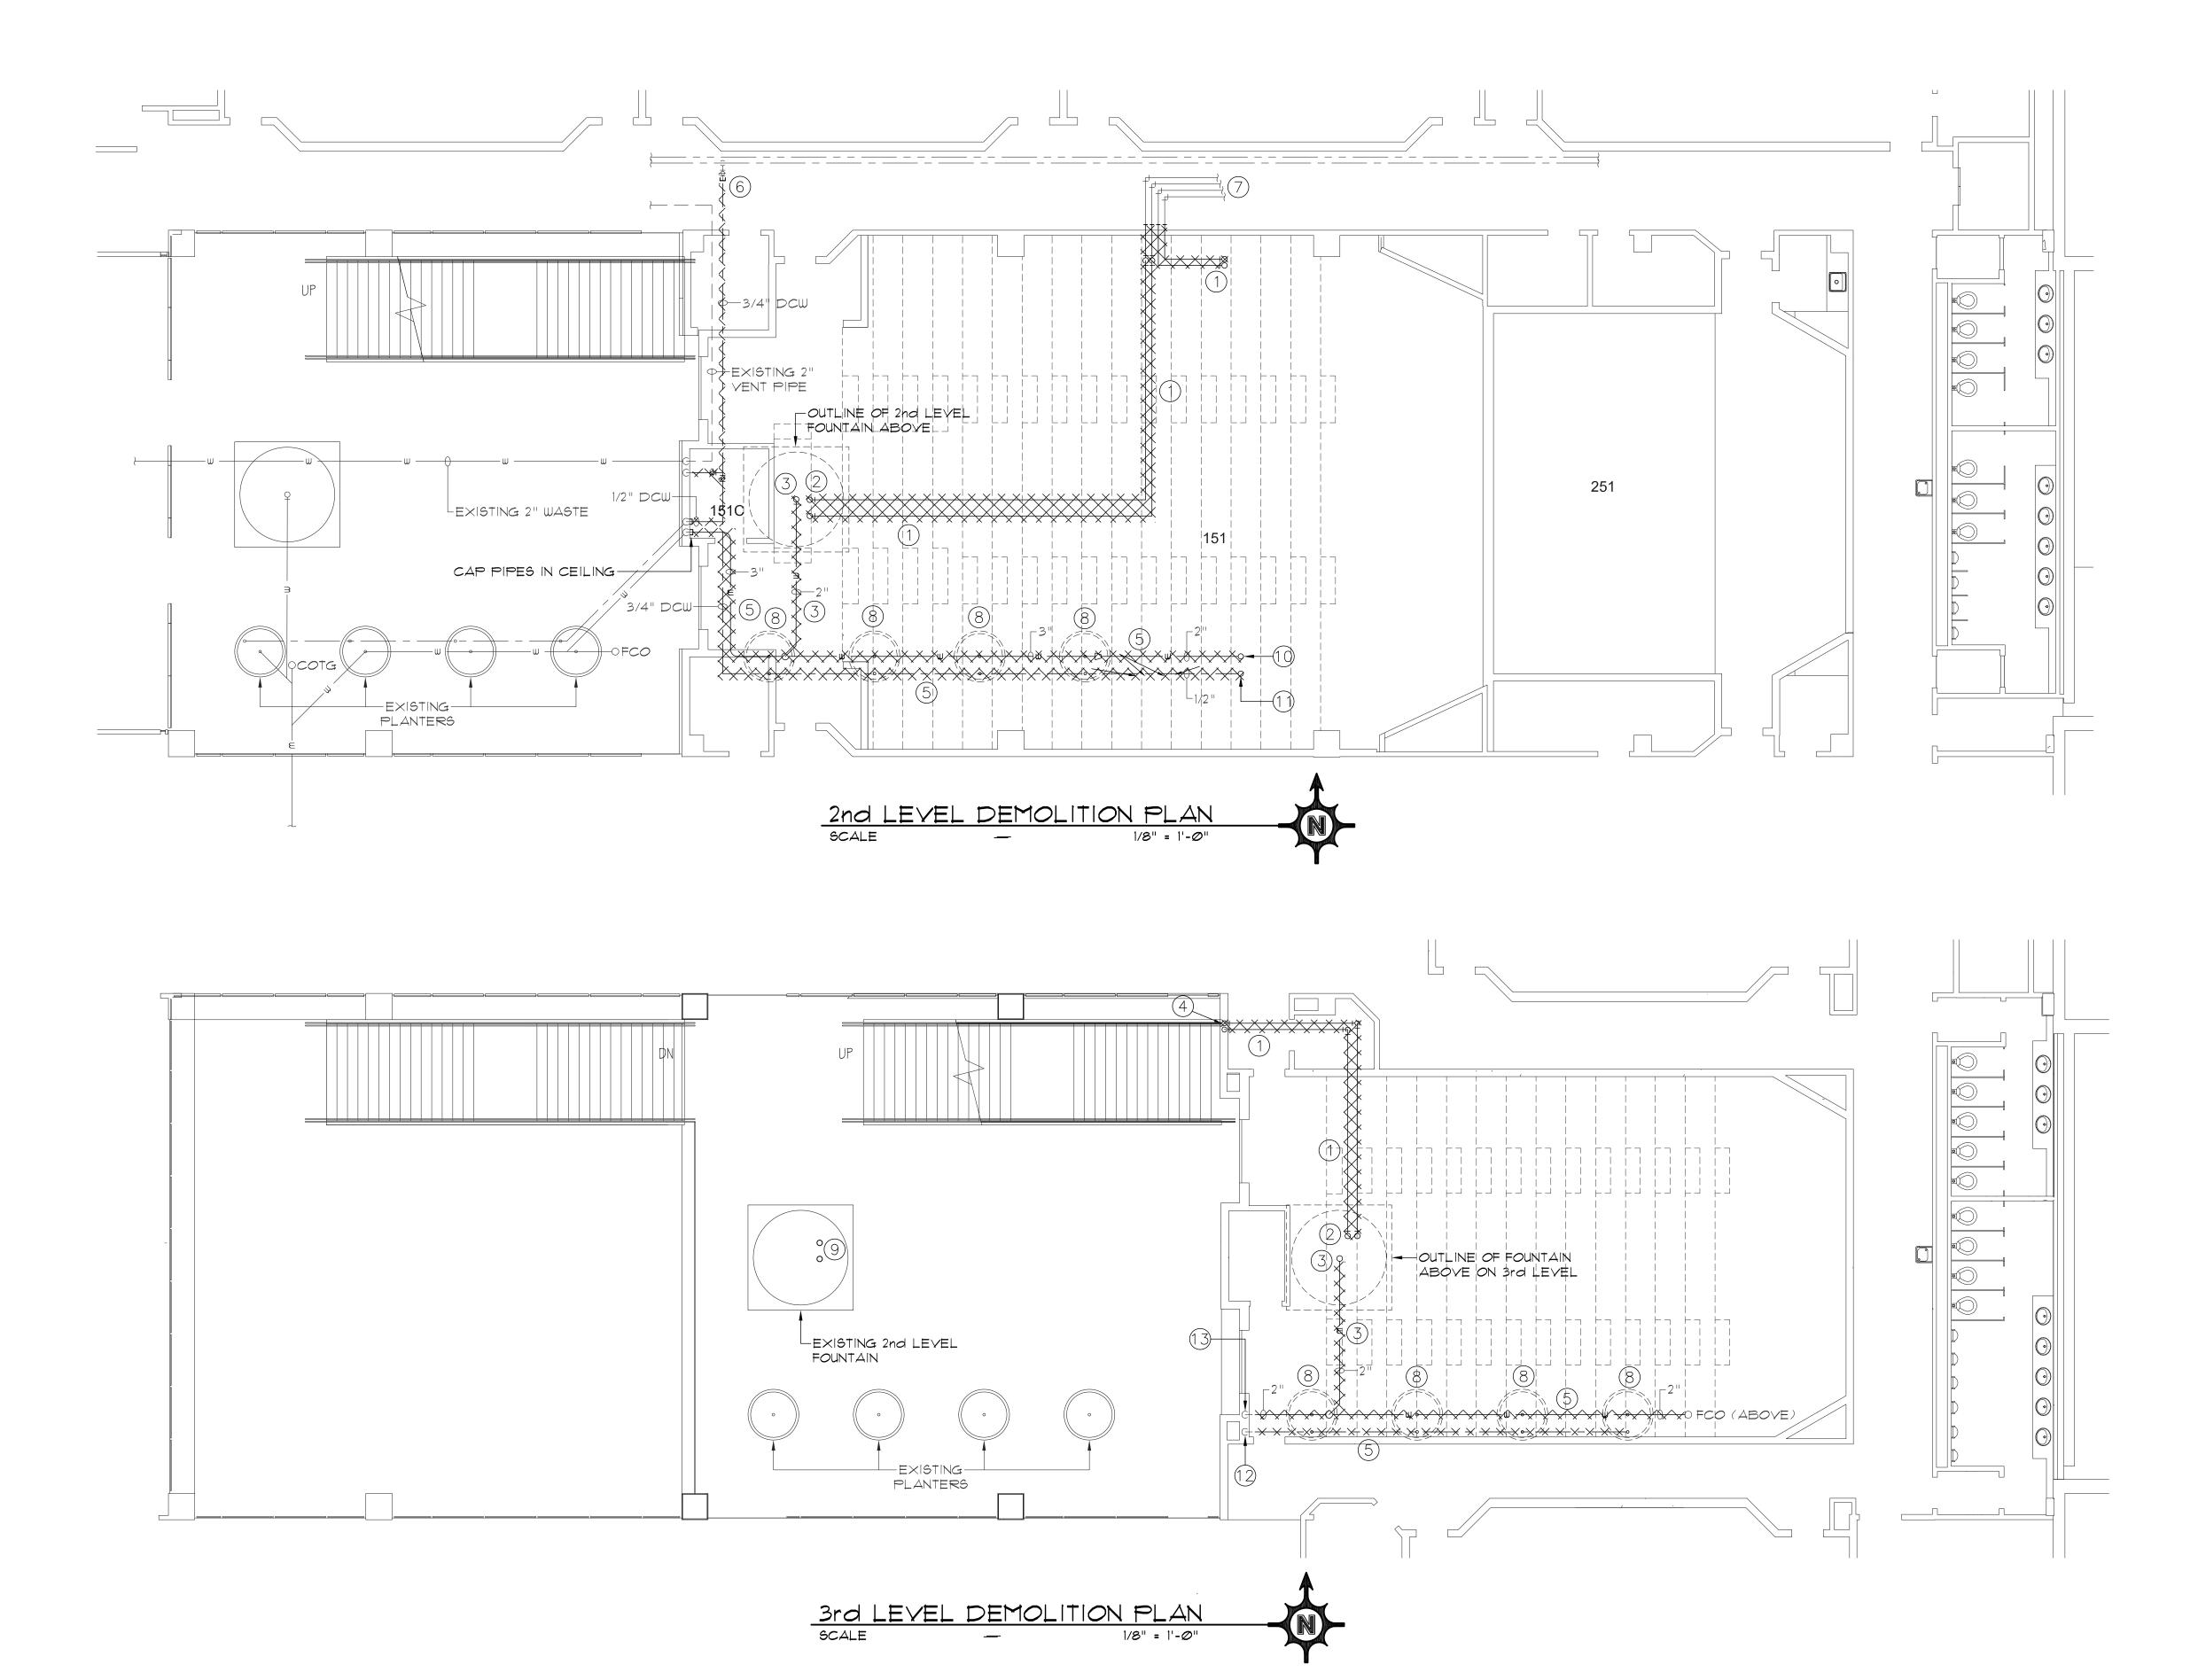

#### **KEYED PLUMBING NOTES**

- DEMO EXISTING FOUNTAIN SUPPLY/RETURN PIPING LOCATED IN CEILING SPACE PREPARATORY FOR NEW IN SAME LOCATION, IF ADDITIVE ALTERNATE IS ACCEPTED. FIELD VERIFY ROUTING OF EXISTING
- REMOVE EXISTING FOUNTAIN SUPPLY/RETURN PIPING UP THRU FLOOR SLAB AND IN FOUNTAIN, ON FLOOR ABOVE, COMPLETE.
- DEMO EXISTING FOUNTAIN OVERFLOW DRAIN FROM FOUNTAIN TO CONNECTION OF EXISTING DRAIN PIPING MAIN. FIELD VERIFY LOCATION OF DRAIN IN FOUNTAIN AND ROUTING OF EXISTING PIPING AFTER CEILING HAS BEEN REMOVED.
- 1) DEMO EXISTING 1 1/2" FOUNTAIN SUPPLY/RETURN PIPING UP IN WALL FROM 2nd LEVEL CEILING, FIELD VERIFY EXACT RISE LOCATION.
- ) DEMO EXISTING 2" CAST IRON OVERFLOW DRAIN PIPING AND 1/2" GALVANIZED STEEL DOW PIPING,
- SERVING PLANTERS ON LEVEL ABOVE, COMPLETE. DEMO SECTION OF EXISTING COPPER 3/4" DCW PIPE DOWNSTREAM OF EXISTING VALVE AND CAP PIPE AT VALVE.
- ) EXISTING PLASTIC FOUNTAIN SUPPLY/RETURN PIPING II CEILING SPACE OF HALLWAY BACK TO MECHANICAL
- CUT OFF DRAIN PIPE TO EACH PLANTER IN CEILING SPACE OF AUDITORIUM, FILL WITH EXPANDING SPRAY FOAM FROM BELOW, AND INSTALL CAP ON BOTTOM OF PIPE. TYPICAL ALL PLANTERS ON 2nd AND 3rd
- ) REMOVE EXISTING FOUNTAIN SUPPLY/RETURN PIPING IN FOUNTAIN DOWN THRU FLOOR SLAB BELOW FOUNTAIN.
- (10) 2" CI WASTE DROP FROM 2nd LEVEL CEILING.
- (11) 1/2" GALY DCW RISER TO 2nd LEVEL CEILING.
- 2) ABANDON 1/2" GALY DCW RISER, IN WALL, INTO 2nd LEYEL CEILING.
- $\hat{1}\hat{3}$ ) 2" CI WASTE DROP TO 1st LEVEL CEILING TO REMAIN \$ BE RE-USED.



**FACILITIES PLANNING 240 BRWB PROVO, UTAH 84602** PHONE: (801) 422-5504 FAX: (801) 422-0565

February 2024 DESIGNER: B. Holman **DRAWN BY:** B. Holman

ADA CHECK: CODE CHECK: **MECHANICAL:** STRUCTURAL:

CLIENT APPROVAL

PLANNING DIR:

**REVISIONS** 

REMODEL AUDITORIUMS 151 PHYSICAL FACILITIES


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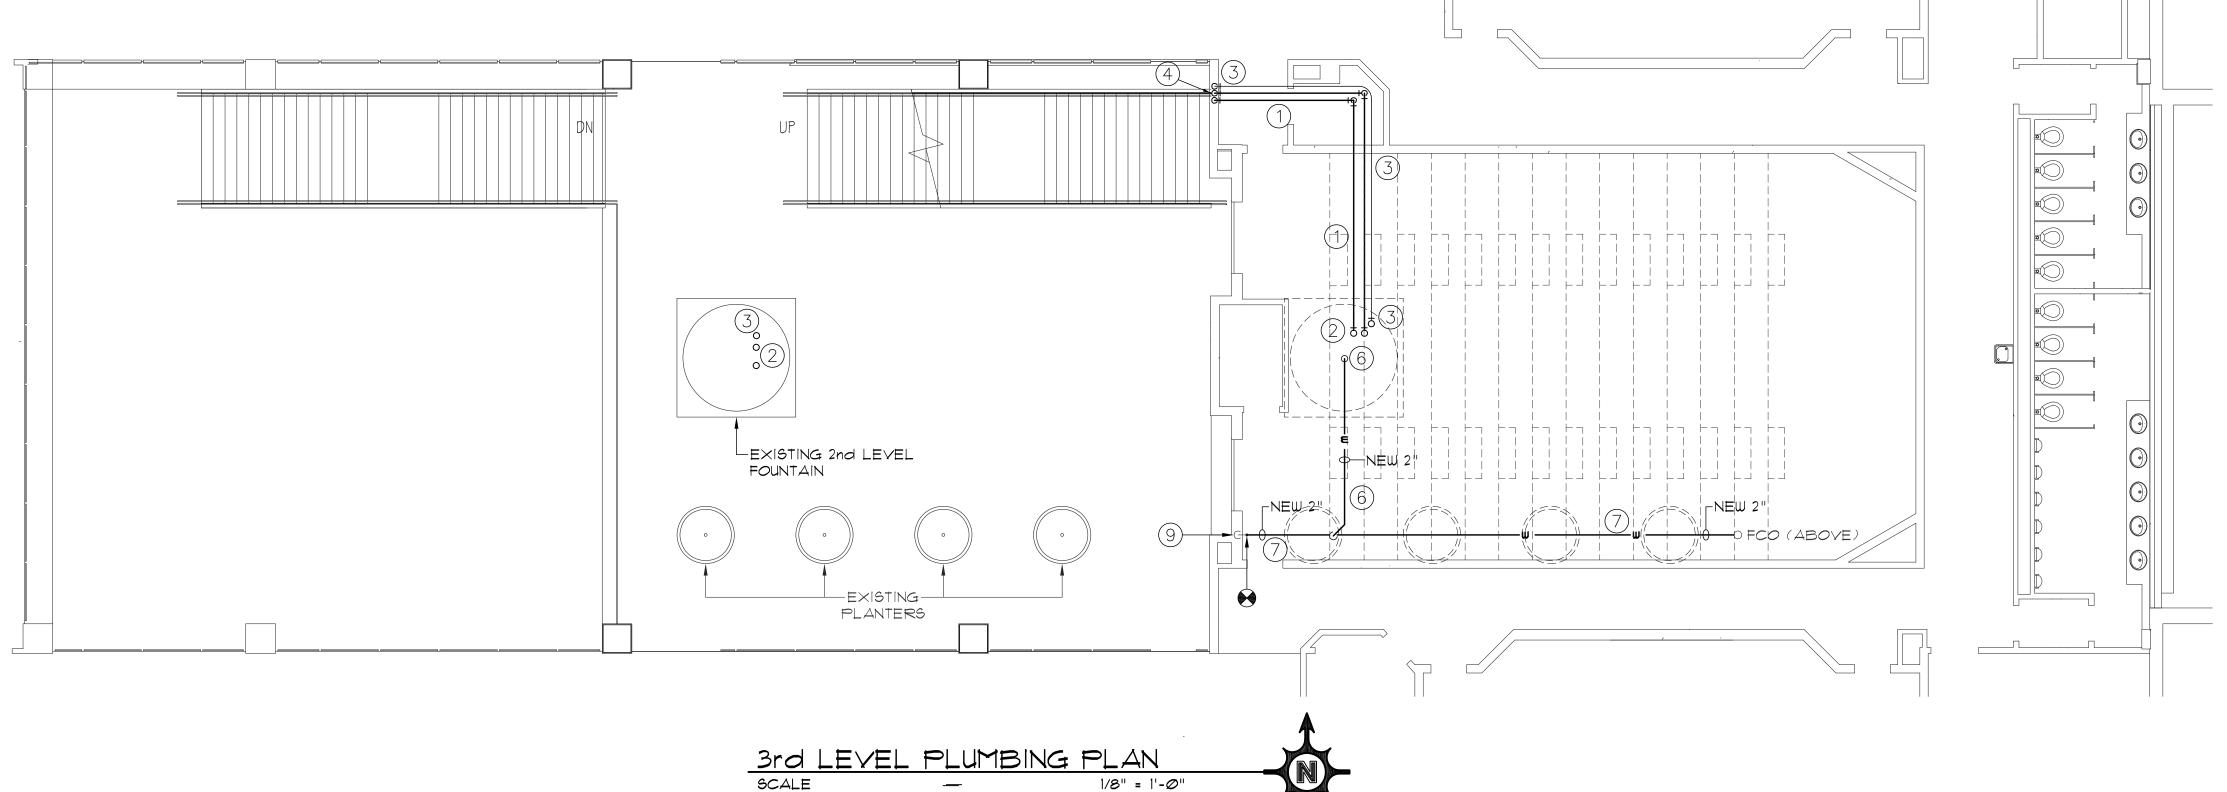


2nd & 3rd LEVEL **PLUMBING DEMOLITION PLANS** 

WORK ORDER & SHEET NO.

M3728 P1.1



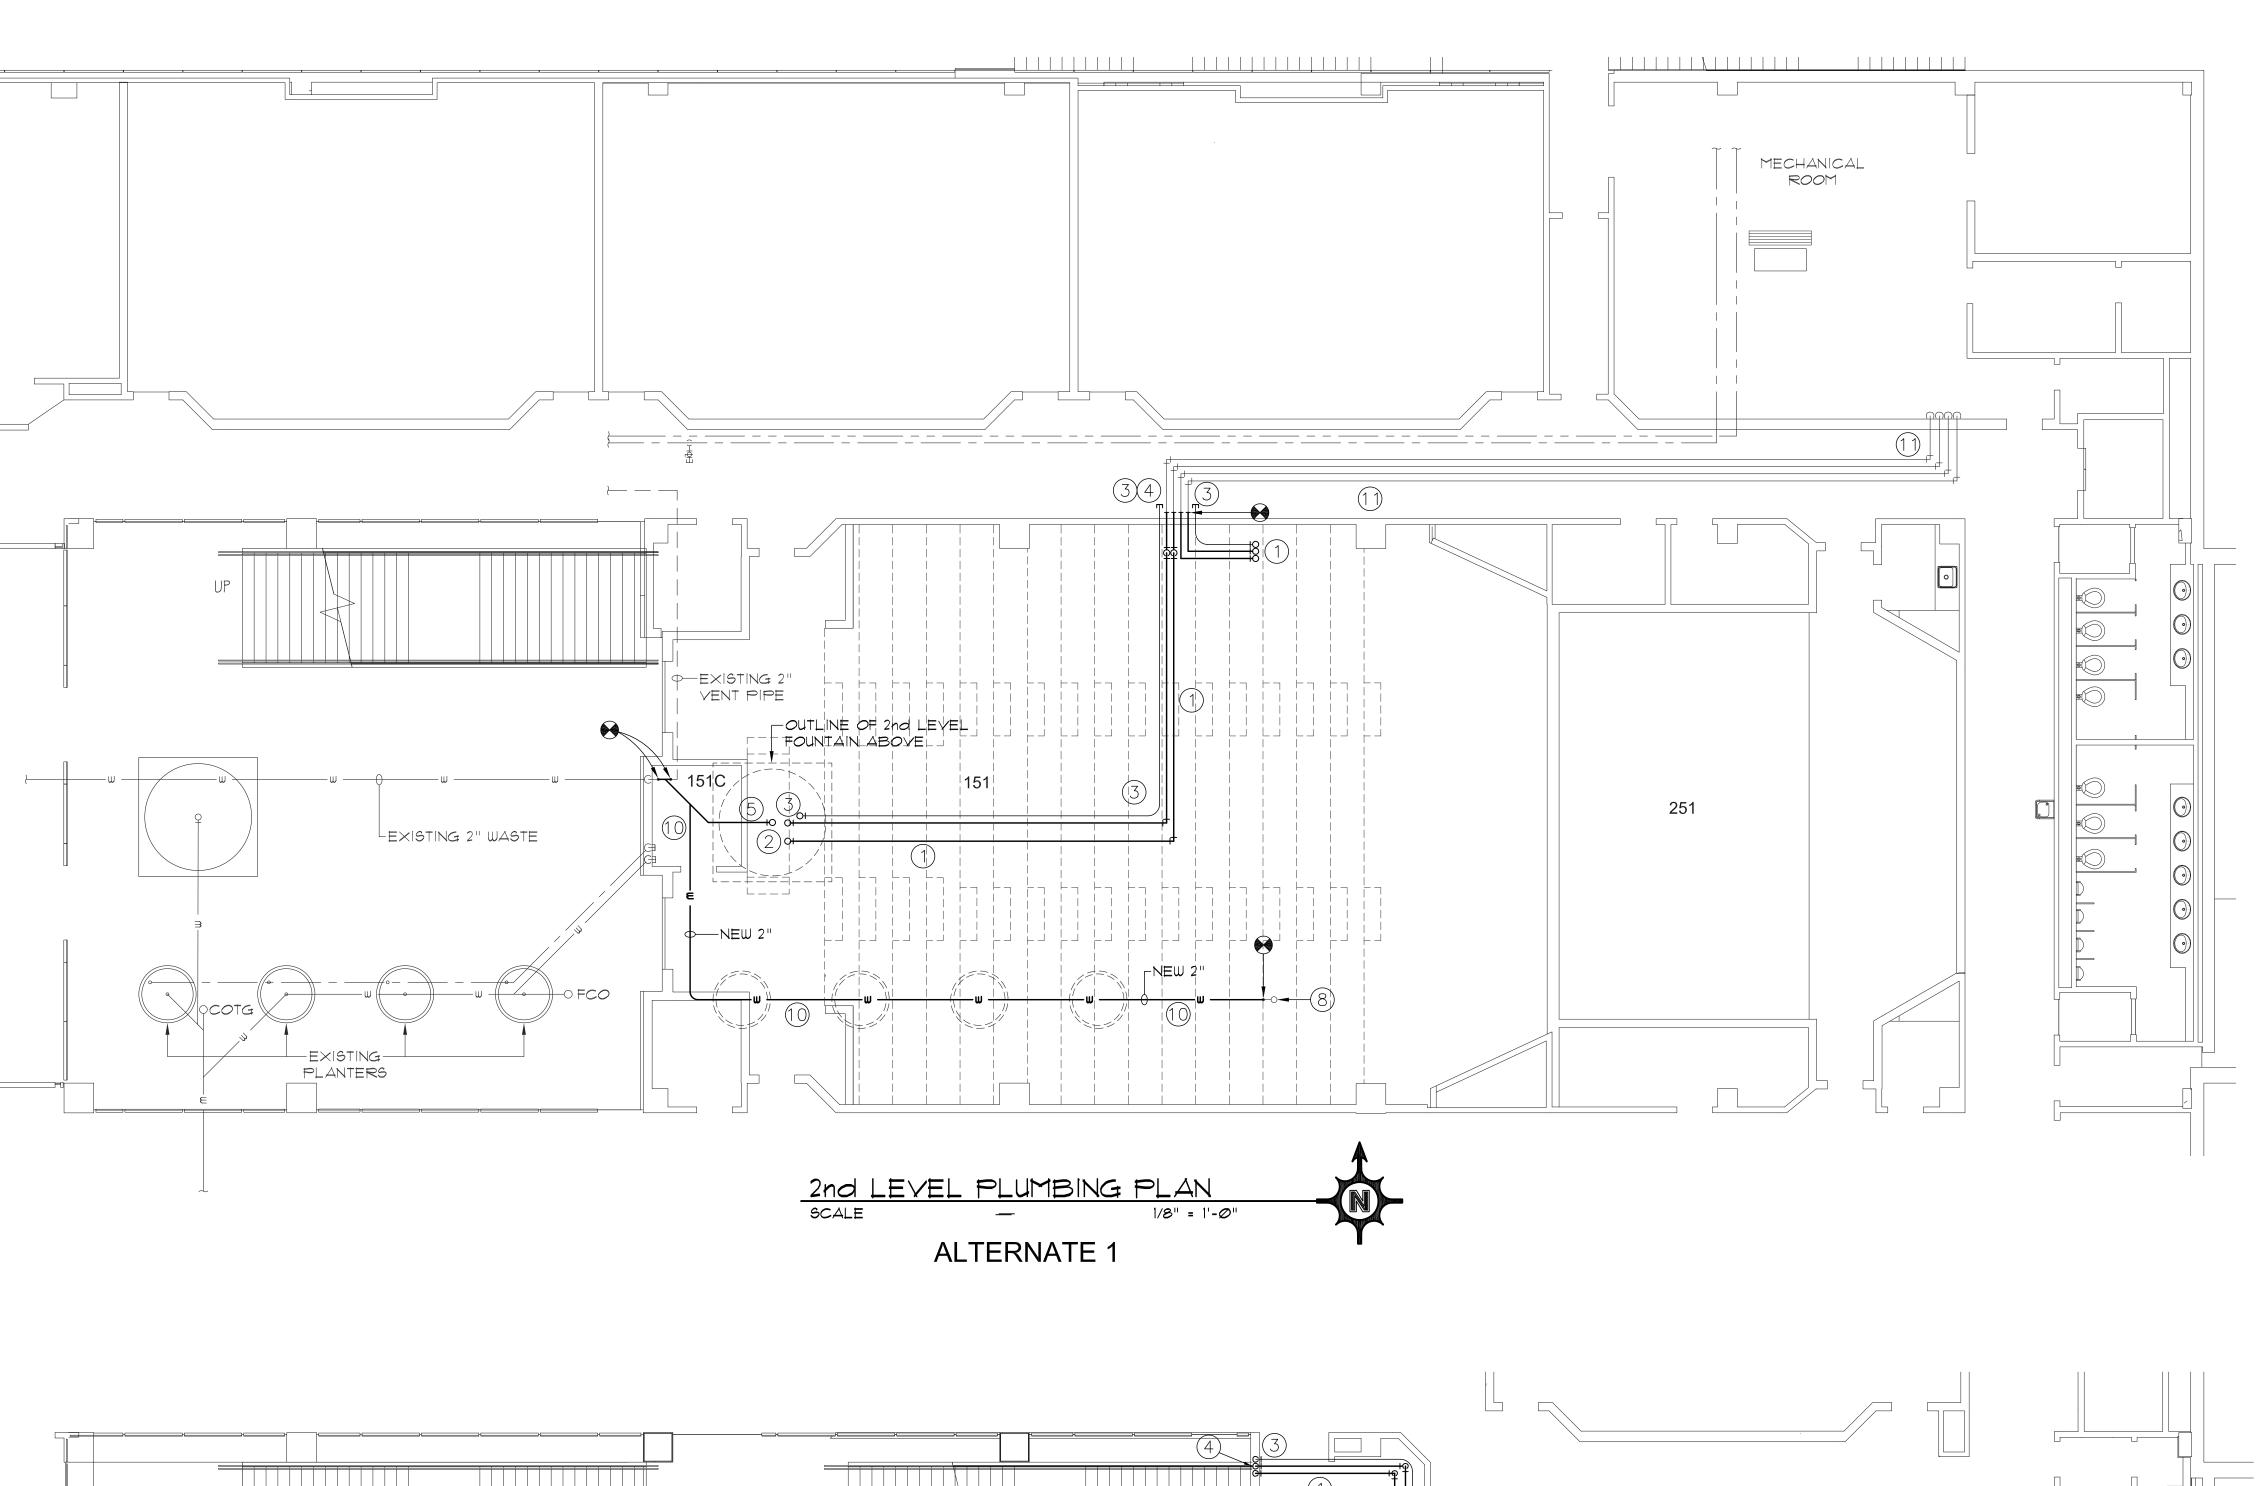

ALTERNATE 1

#### **KEYED PLUMBING NOTES**

- FURNISH & INSTALL NEW 2" SCHEDULE 40 PVC FOUNTAIN SUPPLY/RETURN PIPING TO REPLACE EXISTING. MATCH EXISTING ROUTING AND RE-USE EXISTING HANGERS. FIELD VERIFY EXACT ROUTING OF EXISTING PIPING.
- ) RISE NEW 2" SCHEDULE 40 PVC FOUNTAIN SUPPLY/RETURN PIPING UP THROUGH FLOOR TO FOUNTAIN ABOVE, FIELD VERIFY EXACT RISE LOCATION.
- ) FURNISH & INSTALL A 3/4" CONDUIT FROM FOUNTAIN TO CORRIDOR. ROUTE PARALLEL WITH NEW FOUNTAIN PIPING AS SHOWN. CAP CONDUIT IN CORRIDOR CEILING SPACE FOR FUTURE EXTENSION.
- CONNECT NEW 2" FOUNTAIN SUPPLY / RETURN PIPING TO EXISTING IN CEILING SPACE OF CORRIDOR. FIELD VERIFY WHICH PIPE IS SUPPLY AND RETURN AND MARK TO ENSURE PROPER CONNECTION WITH NEW PIPING TO FOUNTAIN.
- NEW 2" WASTE PIPING FROM FOUNTAIN OVERFLOW DRAIN, ON LEVEL ABOVE, TO EXISTING 2" WASTE VENT FROM ABANDONED SINK IN NORTHWEST CORNER OF ROOM 151C. FIELD VERIFY LOCATION OF OVERFLOW DRAIN PIPE IN CEILING OF 151 AND VENT PIPING IN CEILING OF ROOM 151C. INSTALL TRAP AT DRAIN.
- NEW 2" WASTE PIPING FROM FOUNTAIN OVERFLOW DRAIN, ON LEVEL ABOVE, TO NEW 2" WASTE PIPING IN CEILING OF 251. INSTALL TRAP AT DRAIN.
- ) INSTALL NEW 2" WASTE PIPING IN CEILING OF 251 FROM EXISTING FLOOR CLEAN OUT TO EXISTING DROP IN WALL. RE-USE EXISTING HANGERS.
- 8) 2" CI WASTE DROP FROM 2nd LEVEL CEILING.
- 9) 2" CI WASTE DROP TO 1st LEVEL CEILING.
- n) INSTALL NEW 2" WASTE PIPING IN CEILING OF 151 FROM EXISTING EXISTING DROP FROM CEILING ABOVE TO ROOM 151C. RE-USE EXISTING HANGERS.
- ) EXISTING PLASTIC FOUNTAIN SUPPLY/RETURN PIPING IN CEILING SPACE OF HALLWAY BACK TO MECHANICAL



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February 2024 DESIGNER: B. Holman **DRAWN BY:** B. Holman

ADA CHECK:

CODE CHECK: **MECHANICAL:** STRUCTURAL: PLANNING DIR:

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**REVISIONS** 

151 and 251. FACILITIES


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REMODEL

2nd & 3rd LEVEL **ALTERNATE 1 PLUMBING PLANS** 

WORK ORDER & SHEET NO.

M3728 P1.2

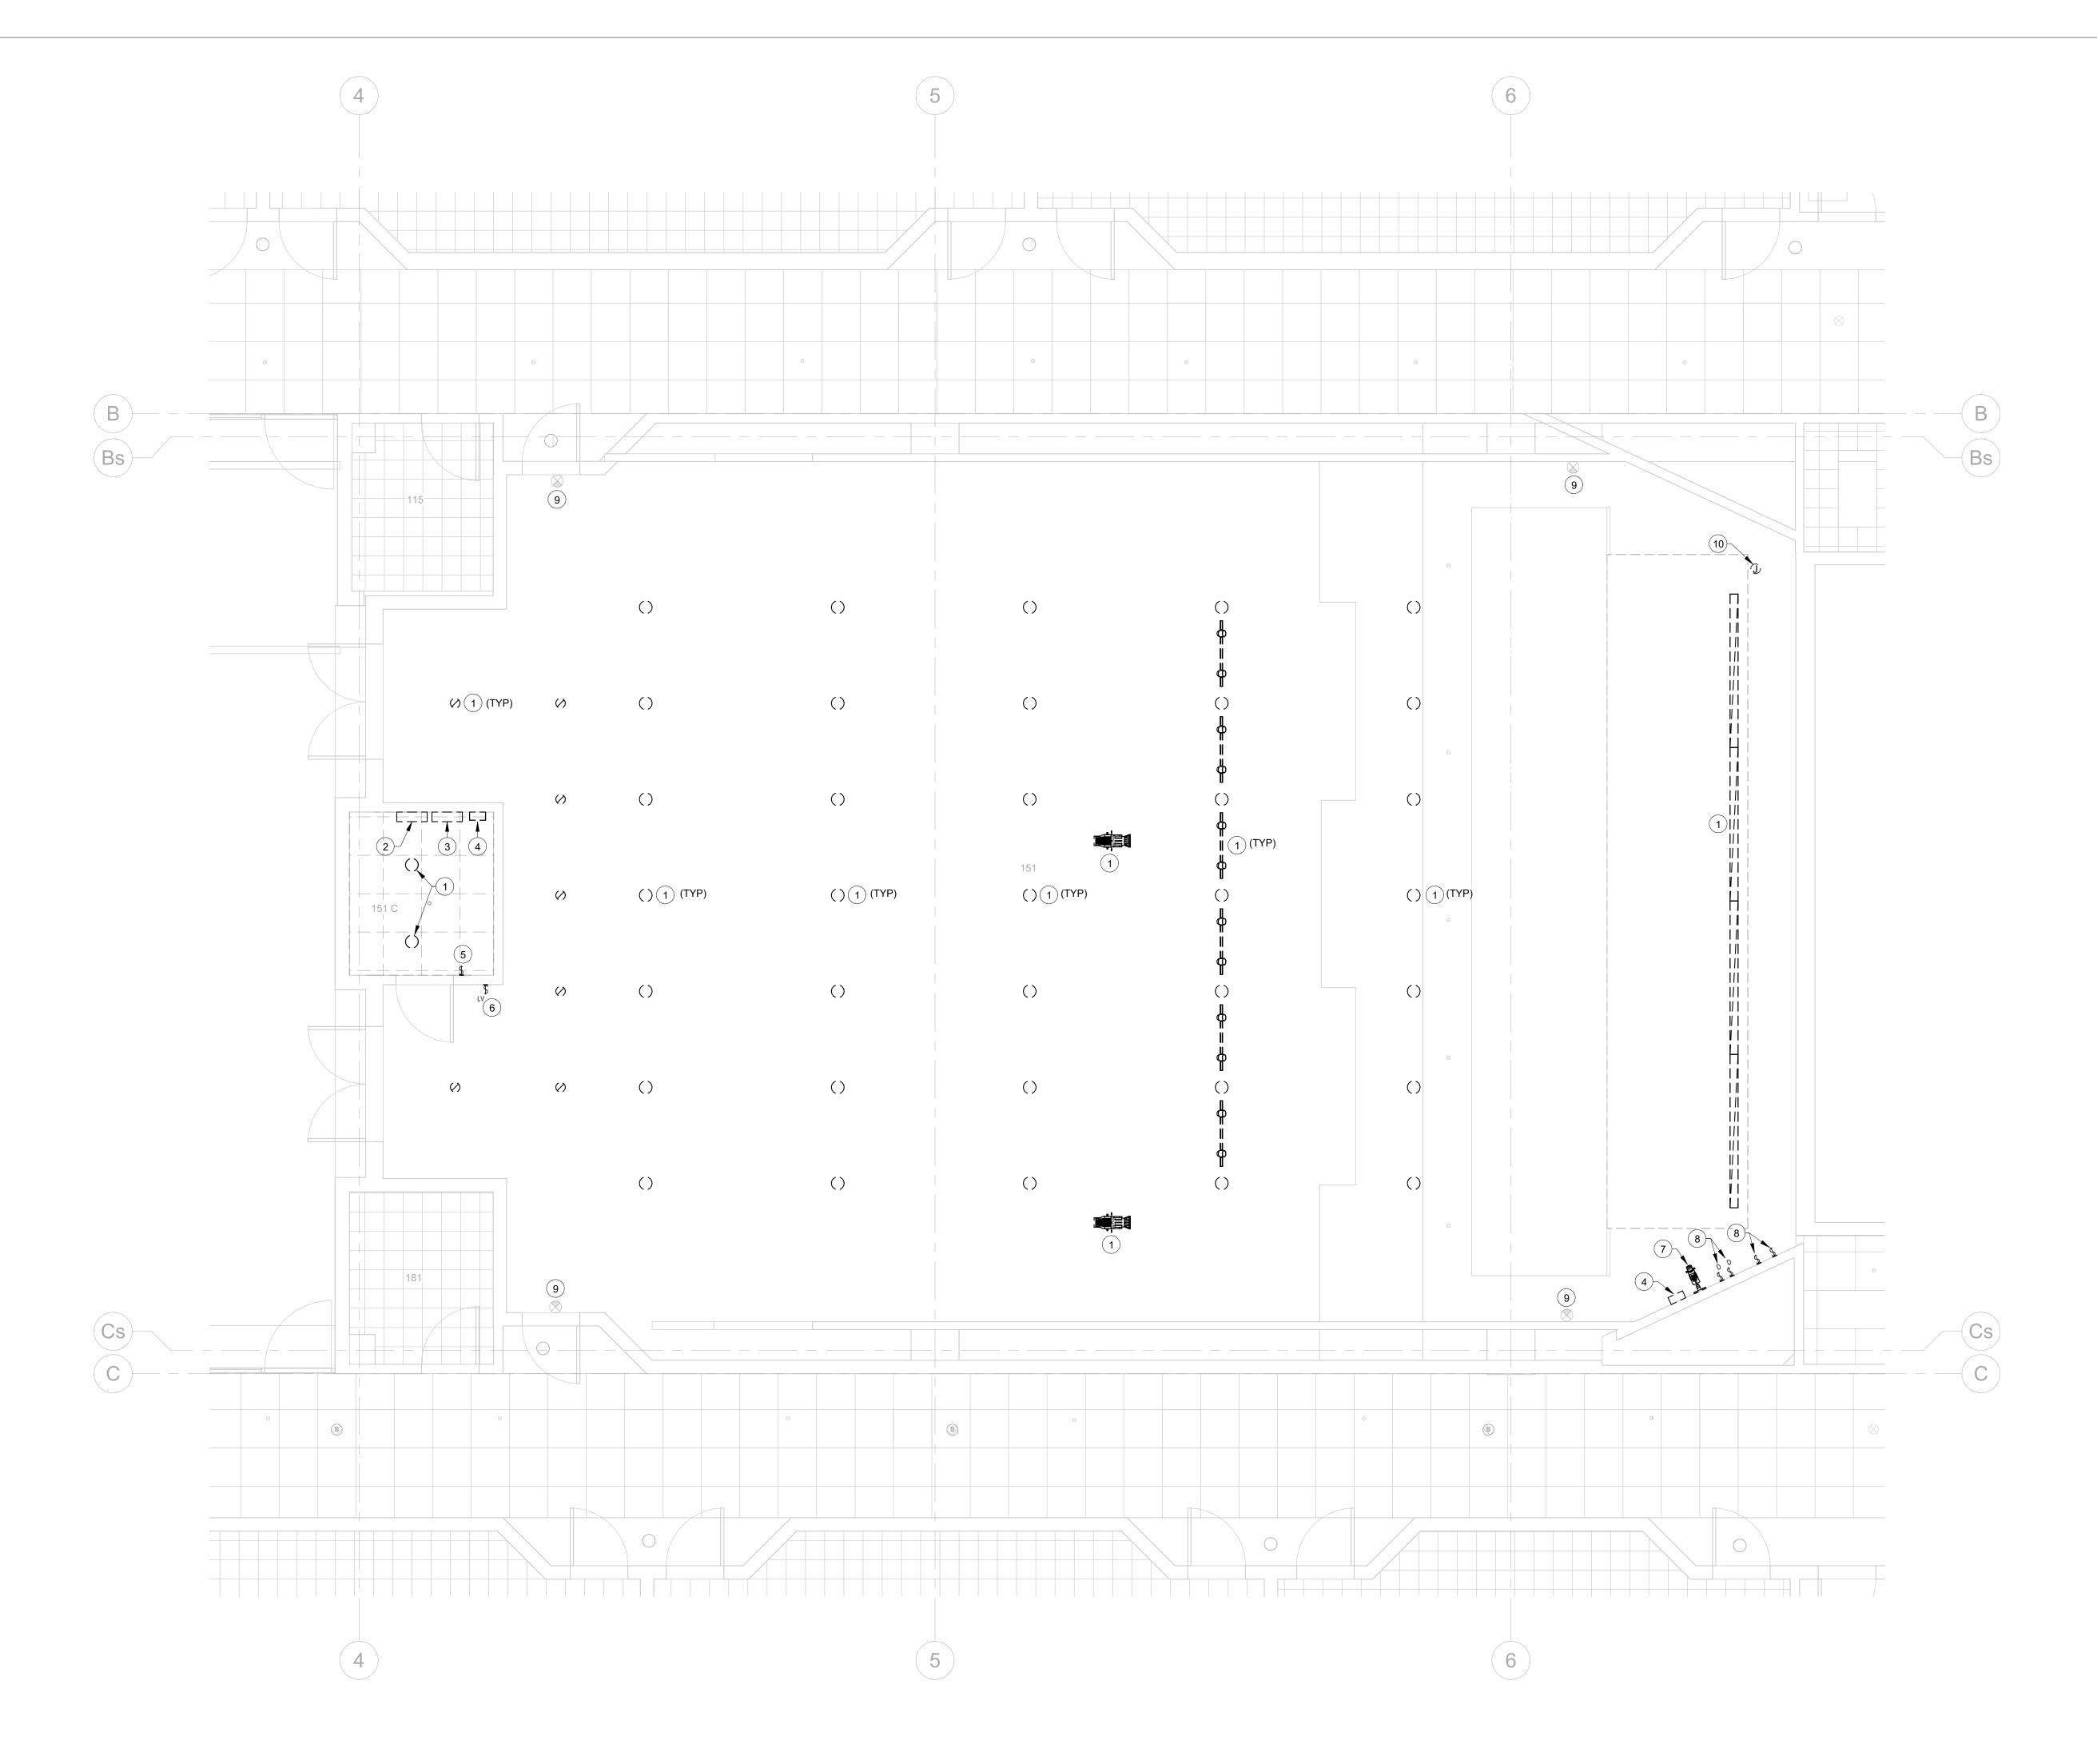

- 1 DEMOLISH EXISTING LUMINAIRE AND ASSOCIATED ABANDONED CIRCUITING
- COMPLETE.

  2 DEMOLISH EXISTING BATTERY BACKUP
- SYSTEM AND ASSOCIATED LUMINAIRES AND ABANDONED CIRCUITING COMPLETE.

  3 DEMOLISH EXISTING DIMMER SYSTEM AND
- ASSOCIATED ABANDONED CIRCUITING.

  4 DEMOLISH EXISTING LIGHTING CONTROL STATION AND REPLACE WITH NEW TOUCH
- PANEL CONTROL STATION.

  5 REPLACE EXISTING SWITCH WITH NEW
- OCCUPANCY SENSOR SWITCH.

  6 DEMOLISH EXISTING LOW VOLTAGE SWITCH
- AND REPLACE WITH NEW ENTRY STATION SWITCH.

  7 DEMOLISH EXISTING PIN SPOT AND REPLACE
- WITH NEW LUMINAIRE TYPE.

  8 DEMOLISH EXISTING SWITCH AND ASSOCIATED ABANDONED CIRCUITING COMPLETE. INSTALL BLANK STAINLESS COVER OVER EXISTING BACKBOX.
- 9 EXISTING EXIT SIGN TO REMAIN.
   10 DISCONNECT POWER TO EXISTING
   PROJECTION SCREEN IN PREPARATION FOR
   SCREEN RELOCATION. RELOCATE POWER
   FEED TO NEW LOCATION. RECONNECT
   SCREEN AS REQUIRED. INSTALL NEW
   PROJECTION SCREEN CONTROLS AT TECH
   PODIUM AND BOOTH.



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FAX: (801) 422-0566

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DRAWN BY: SRG

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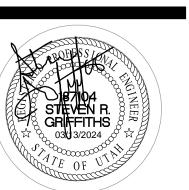
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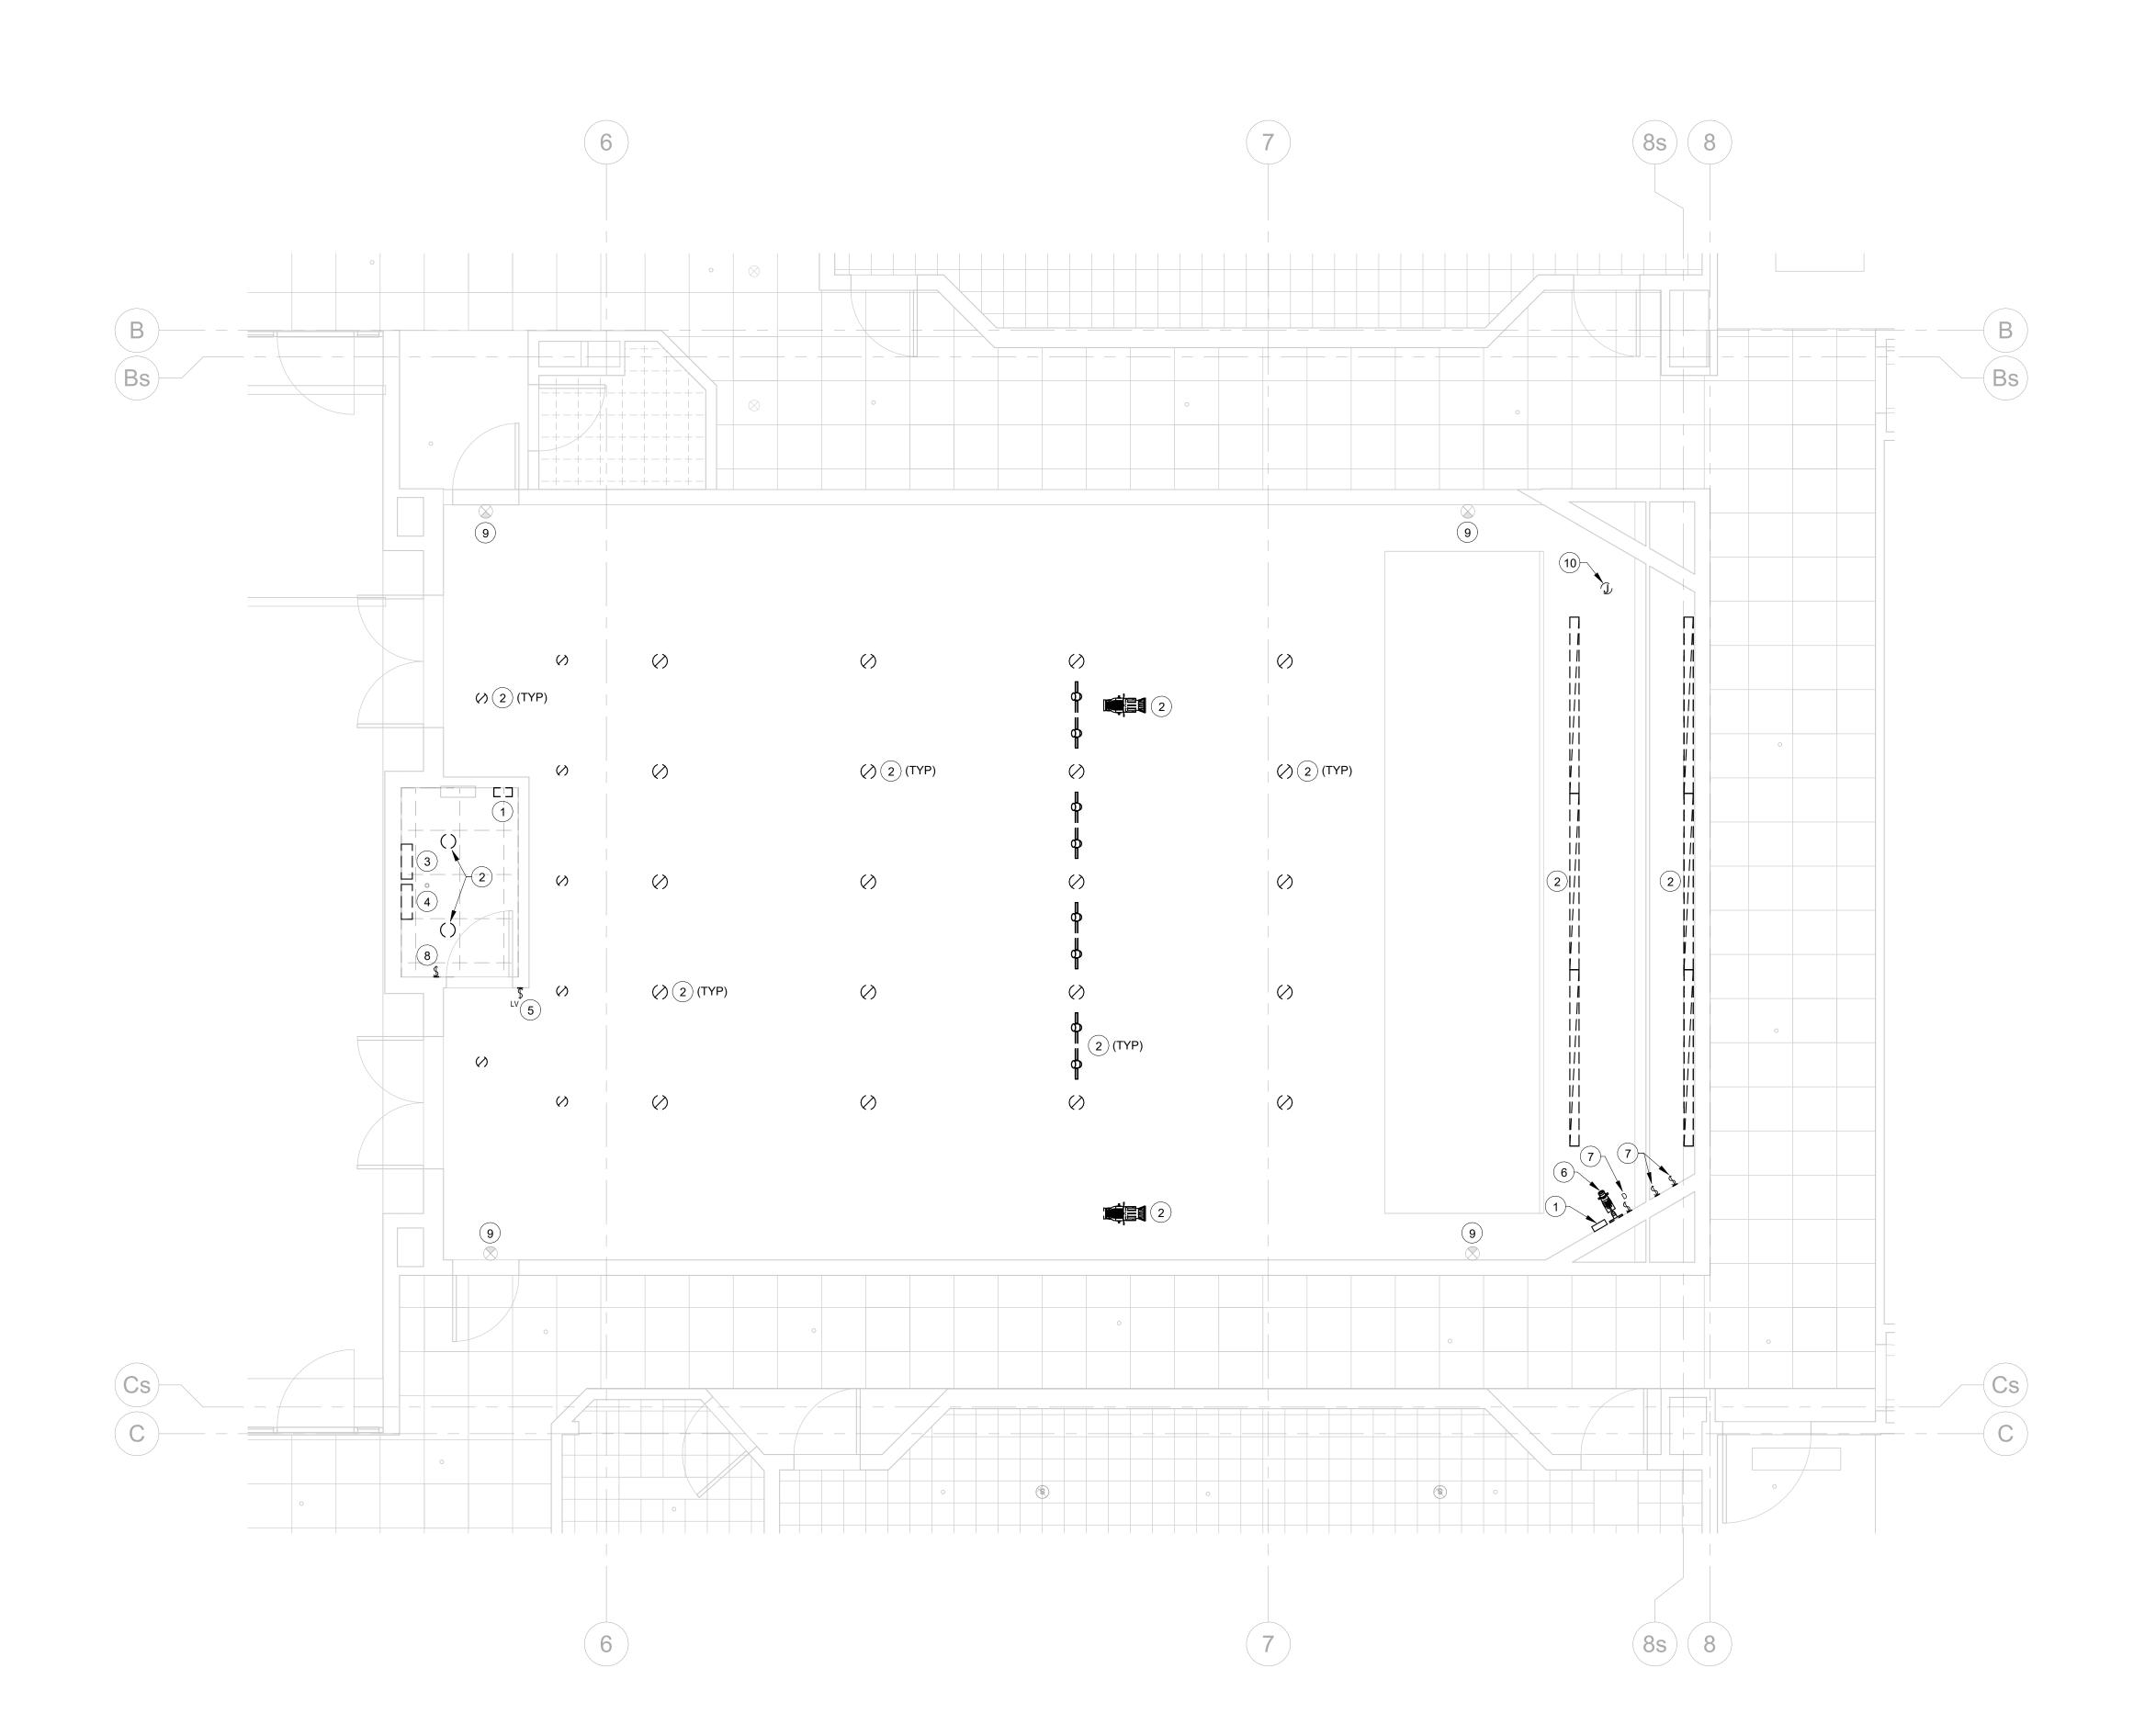


LEVEL 1 DEMOLITION LIGHTING PLAN

WORK ORDER & SHEET NO.

M3728

E1.1



- 1 DEMOLISH EXISTING LIGHTING CONTROL STATION AND REPLACE WITH NEW TOUCH
- PANEL CONTROL STATION. 2 DEMOLISH EXISTING LUMINAIRE AND ASSOCIATED ABANDONED CIRCUITING
- COMPLETE.
- 3 DEMOLISH EXISTING DIMMER SYSTEM AND ASSOCIATED ABANDONED CIRCUITING.
- 4 DEMOLISH EXISTING BATTERY BACKUP SYSTEM AND ASSOCIATED LUMINAIRES AND ABANDONED CIRCUITING COMPLETE. 5 DEMOLISH EXISTING LOW VOLTAGE SWITCH AND REPLACE WITH NEW ENTRY STATION
- SWITCH. 6 DEMOLISH EXISTING PIN SPOT AND REPLACE WITH NEW LUMINAIRE TYPE.
- 7 DEMOLISH EXISTING SWITCH AND ASSOCIATED ABANDONED CIRCUITING COMPLETE. INSTALL BLANK STAINLESS COVER OVER EXISTING BACKBOX.
- 8 REPLACE EXISTING SWITCH WITH NEW OCCUPANCY SENSOR SWITCH.
- 9 EXISTING EXIT SIGN TO REMAIN.
- 10 DISCONNECT POWER TO EXISTING PROJECTION SCREEN IN PREPARATION FOR SCREEN RELOCATION. RELOCATE POWER FEED TO NEW LOCATION. RECONNECT SCREEN AS REQUIRED. INSTALL NEW PROJECTION SCREEN CONTROLS AT TECH PODIUM AND BOOTH.



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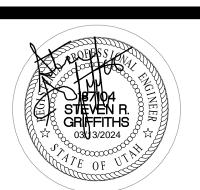
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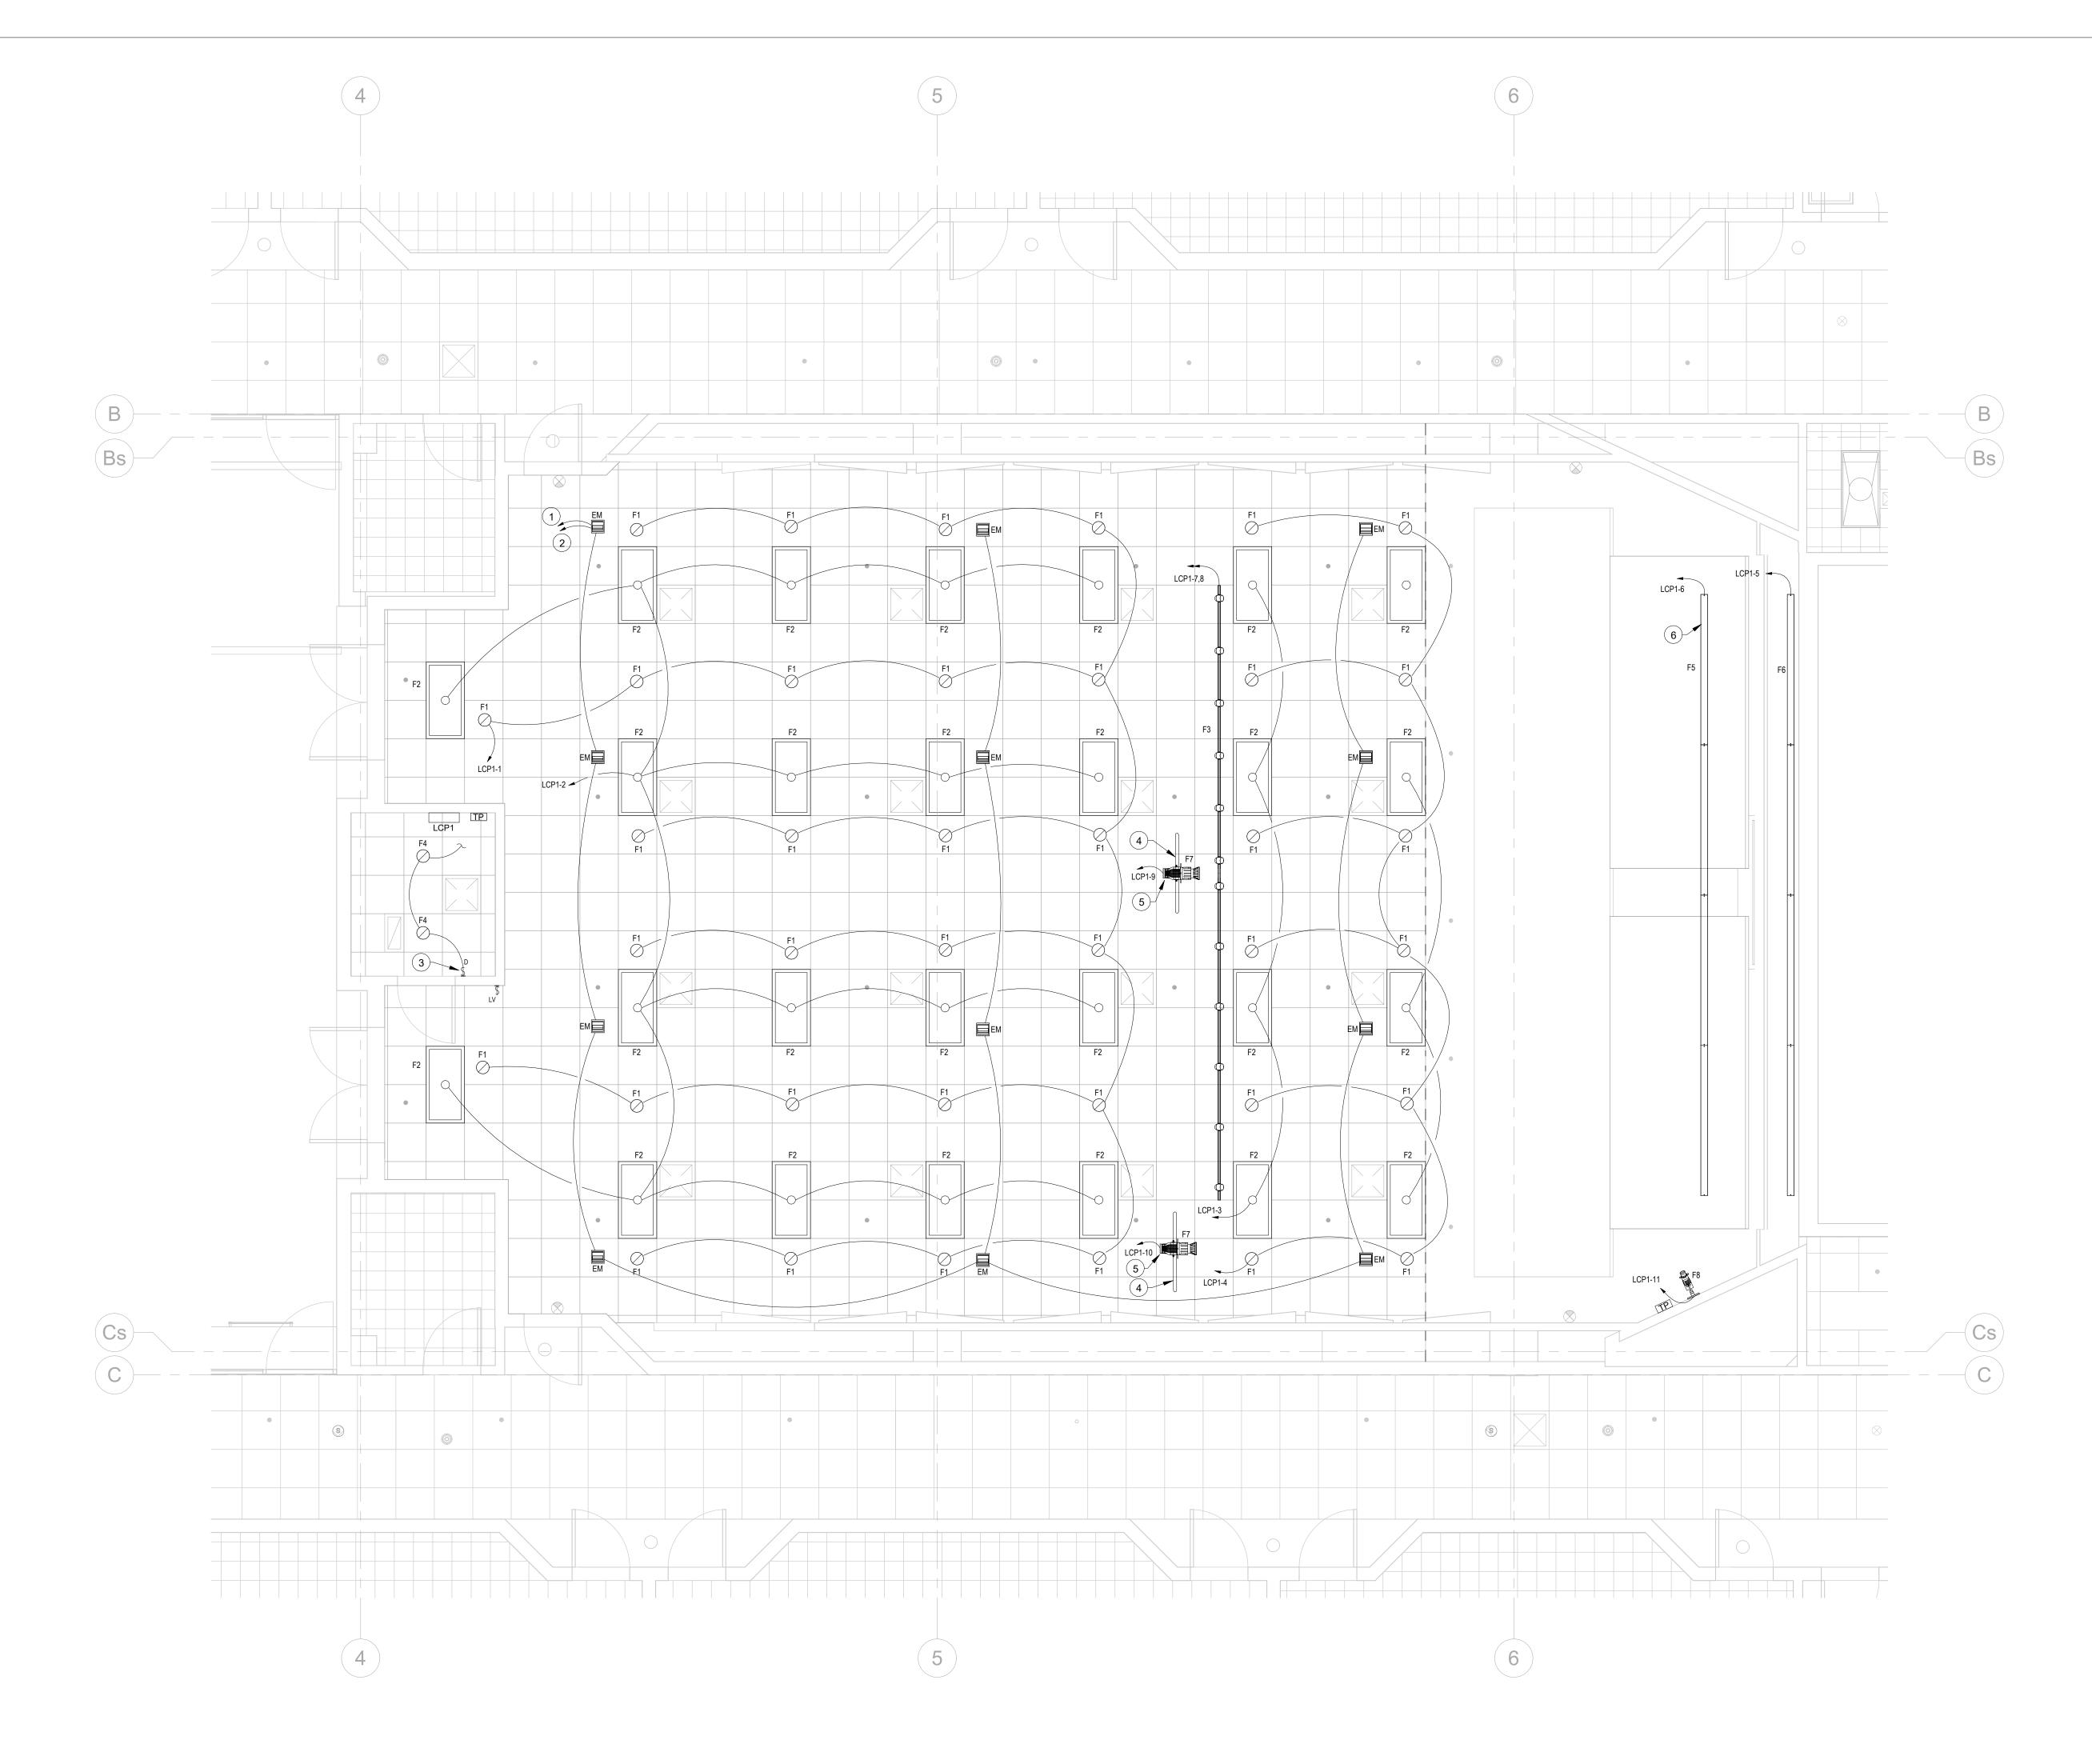
**REVISIONS** 



LEVEL 2 DEMOLITION LIGHTING PLAN

WORK ORDER & SHEET NO.

M3728 E1.2



- 1 CONNECT TO NEAREST EXISTING UNSWITCHED 277V LIGHTING CIRCUIT VIA 3/4"C W/(2)#12, #12 GND.
- 2 CONNECT TO ROOM EXIT SIGN CIRCUIT VIA 3/4"C W/(2)#12, #12 GND.
- 3/4"C W/(2)#12, #12 GND.

  3 SEE SINGLE-POLE SWITCH WIRING DETAIL FOR
- INSTALLATION REQUIREMENTS.

  4 INSTALL "1-1/2"X48" SCHED 40 ANODIZED FIXTURE MOUNTING BAR. MOUNT SO HORIZONTAL BAR IS 12" BELOW CEILING TILE. VERTICAL SUPPORT BARS SHALL BE SUFFICIENT LENGTH TO SOLIDLY FASTEN TO CEILING STRUCTURE ABOVE. BAR FINISH SHALL BE WHITE."
- 5 PROVIDE TWISTLOCK RECEPTACLE & CORD CAP TO CONNECT FIXTURE TO INDICATED CIRCUIT.
- 6 COORDINATE LOCATION OF LUMINAIRE WITH FINAL SCREEN LOCATION. MAINTAIN 24" BETWEEN SCREEN AND LUMINAIRE.



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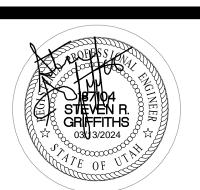
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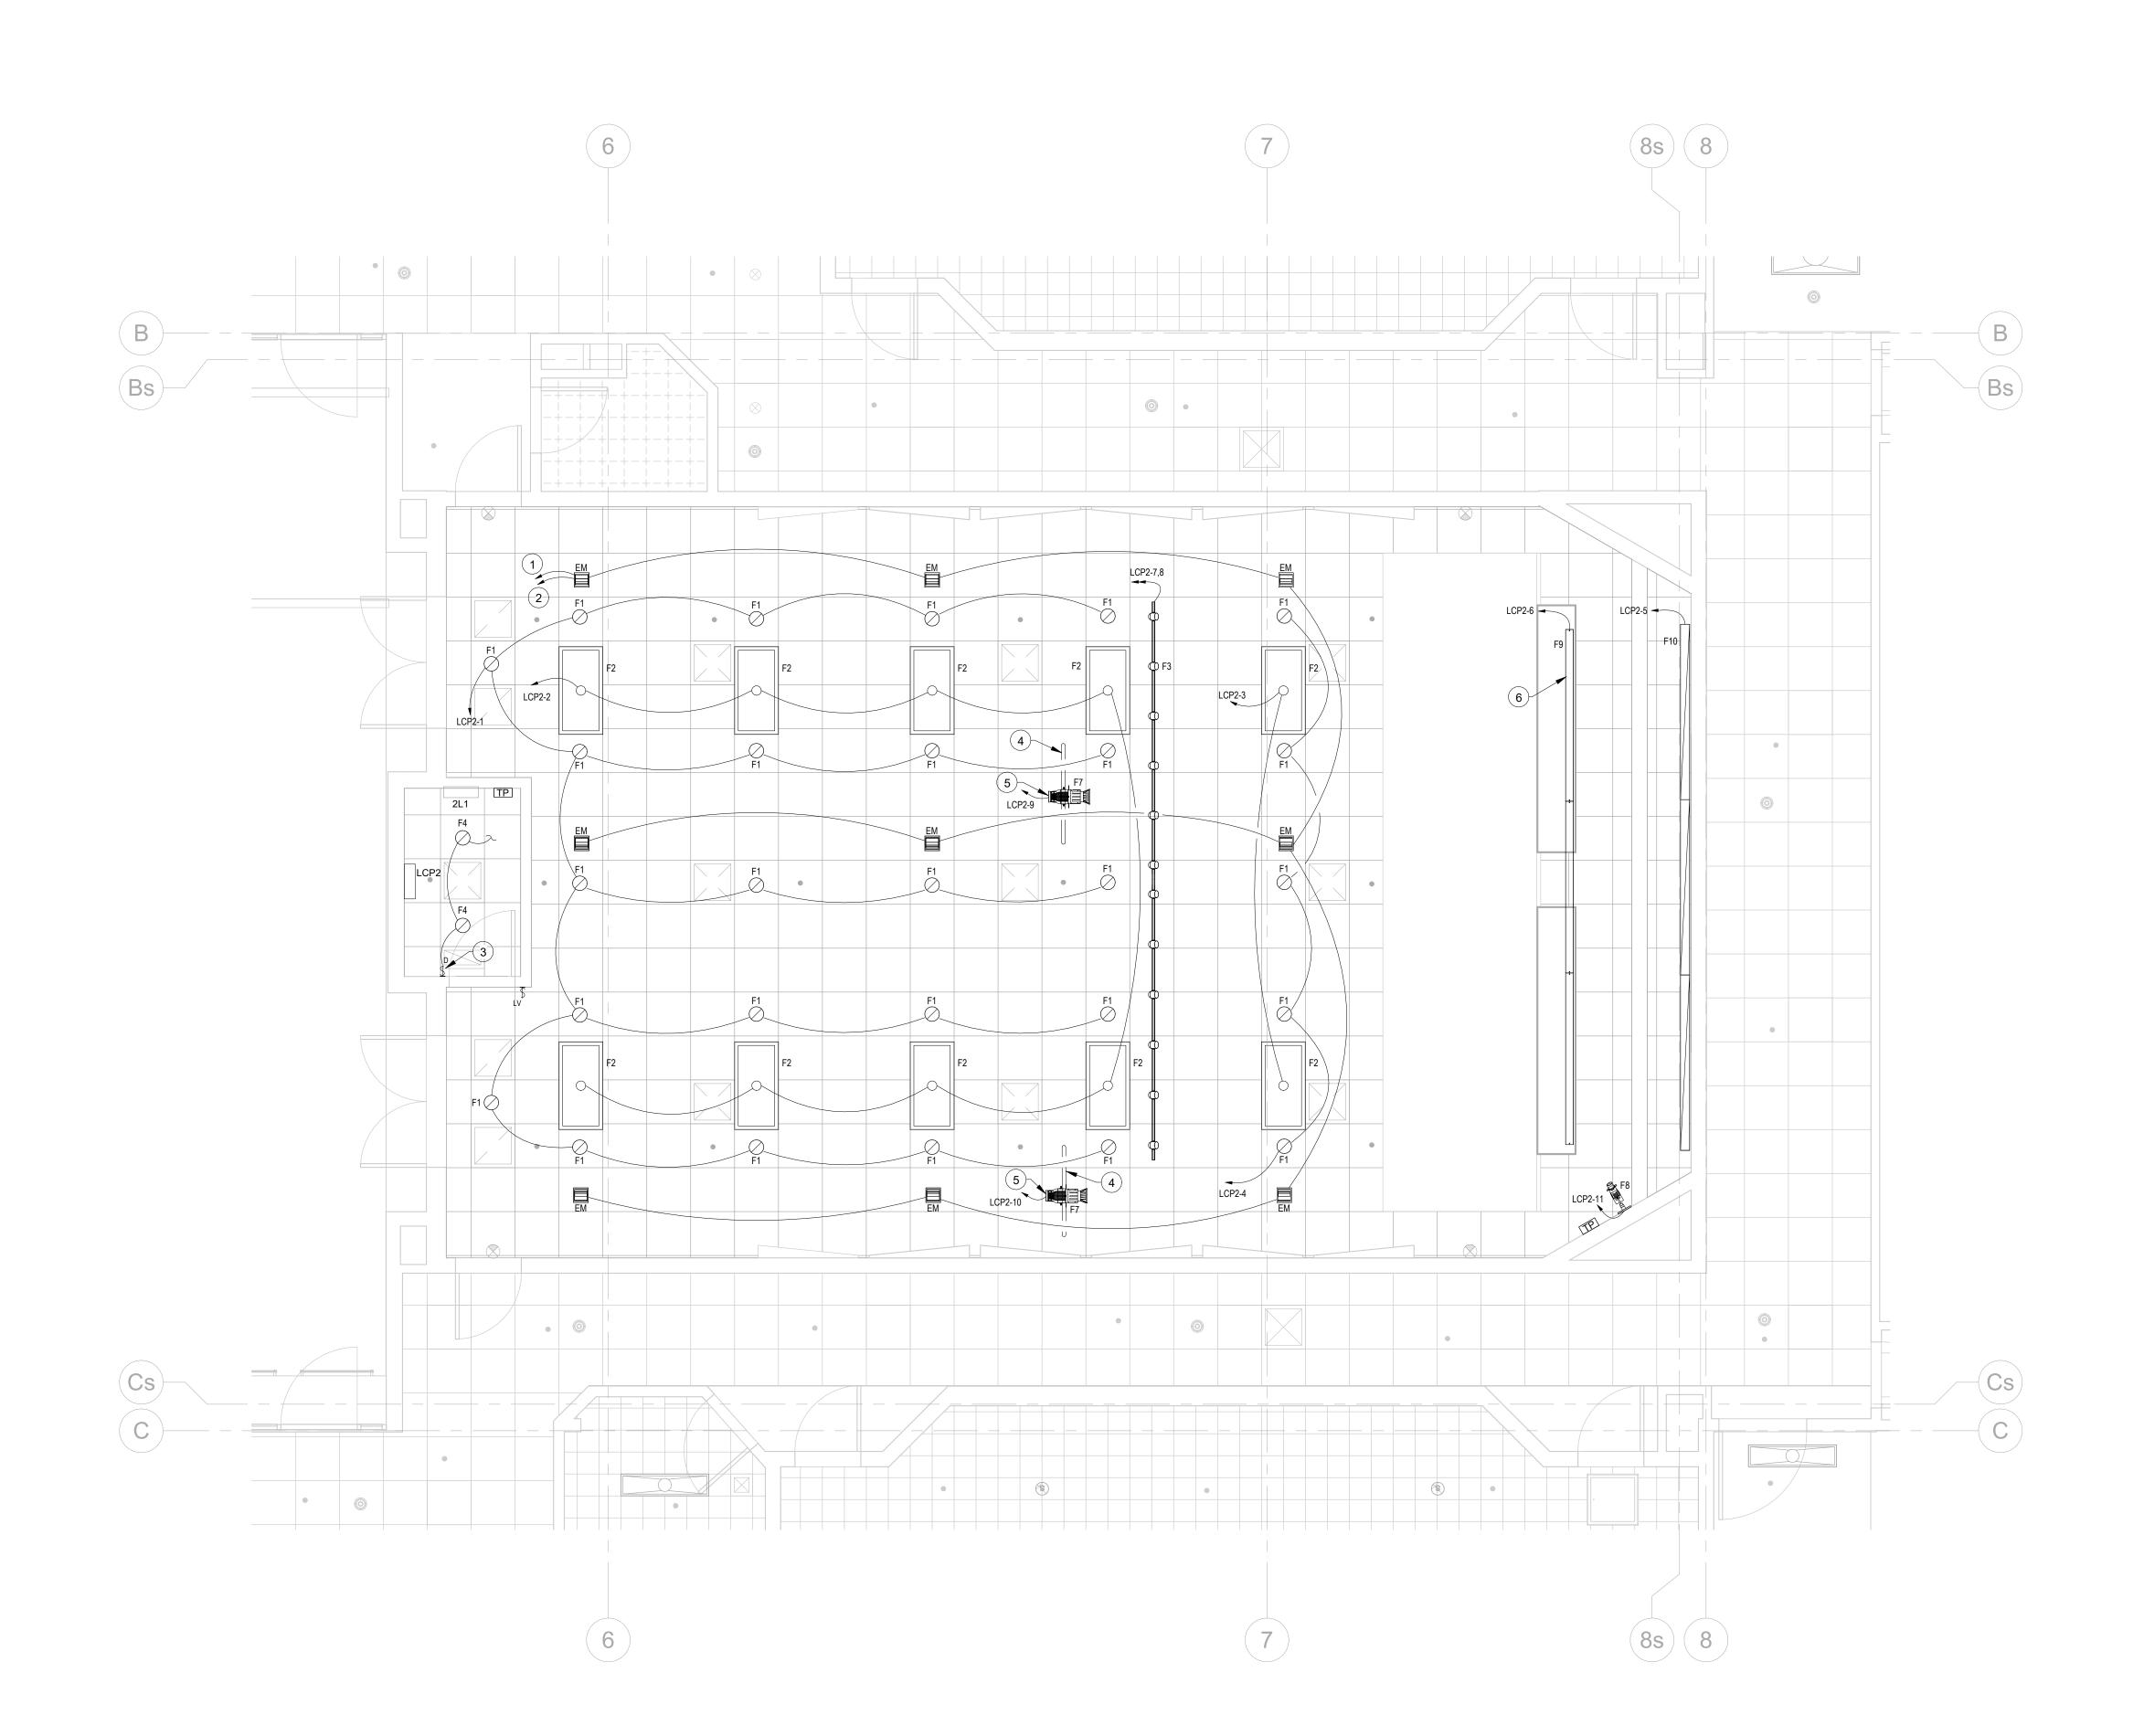


LEVEL 1 LIGHTING PLAN

WORK ORDER & SHEET NO.

M3728

**E2.1** 



- CONNECT TO ROOM EXIT SIGN CIRCUIT VIA 3/4"C W/(2)#12, #12 GND.
   CONNECT TO NEAREST EXISTING UNSWITCHED 277V LIGHTING CIRCUIT VIA 2/4/10 M/(2)#43, #43 CND
- 3/4"C W/(2)#12, #12 GND. 3 SEE SINGLE-POLE SWITCH WIRING DETAIL FOR INSTALLATION REQUIREMENTS.
- 4 INSTALL "1-1/2"X48" SCHED 40 ANODIZED FIXTURE MOUNTING BAR. MOUNT SO HORIZONTAL BAR IS 12" BELOW CEILING TILE. VERTICAL SUPPORT BARS SHALL BE SUFFICIENT LENGTH TO SOLIDLY FASTEN TO CEILING STRUCTURE ABOVE. BAR FINISH SHALL BE WHITE."
- 5 PROVIDE TWISTLOCK RECEPTACLE & CORD CAP TO CONNECT FIXTURE TO INDICATED
- 6 COORDINATE LOCATION OF LUMINAIRE WITH FINAL SCREEN LOCATION. MAINTAIN 24" BETWEEN SCREEN AND LUMINAIRE.



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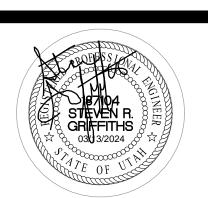
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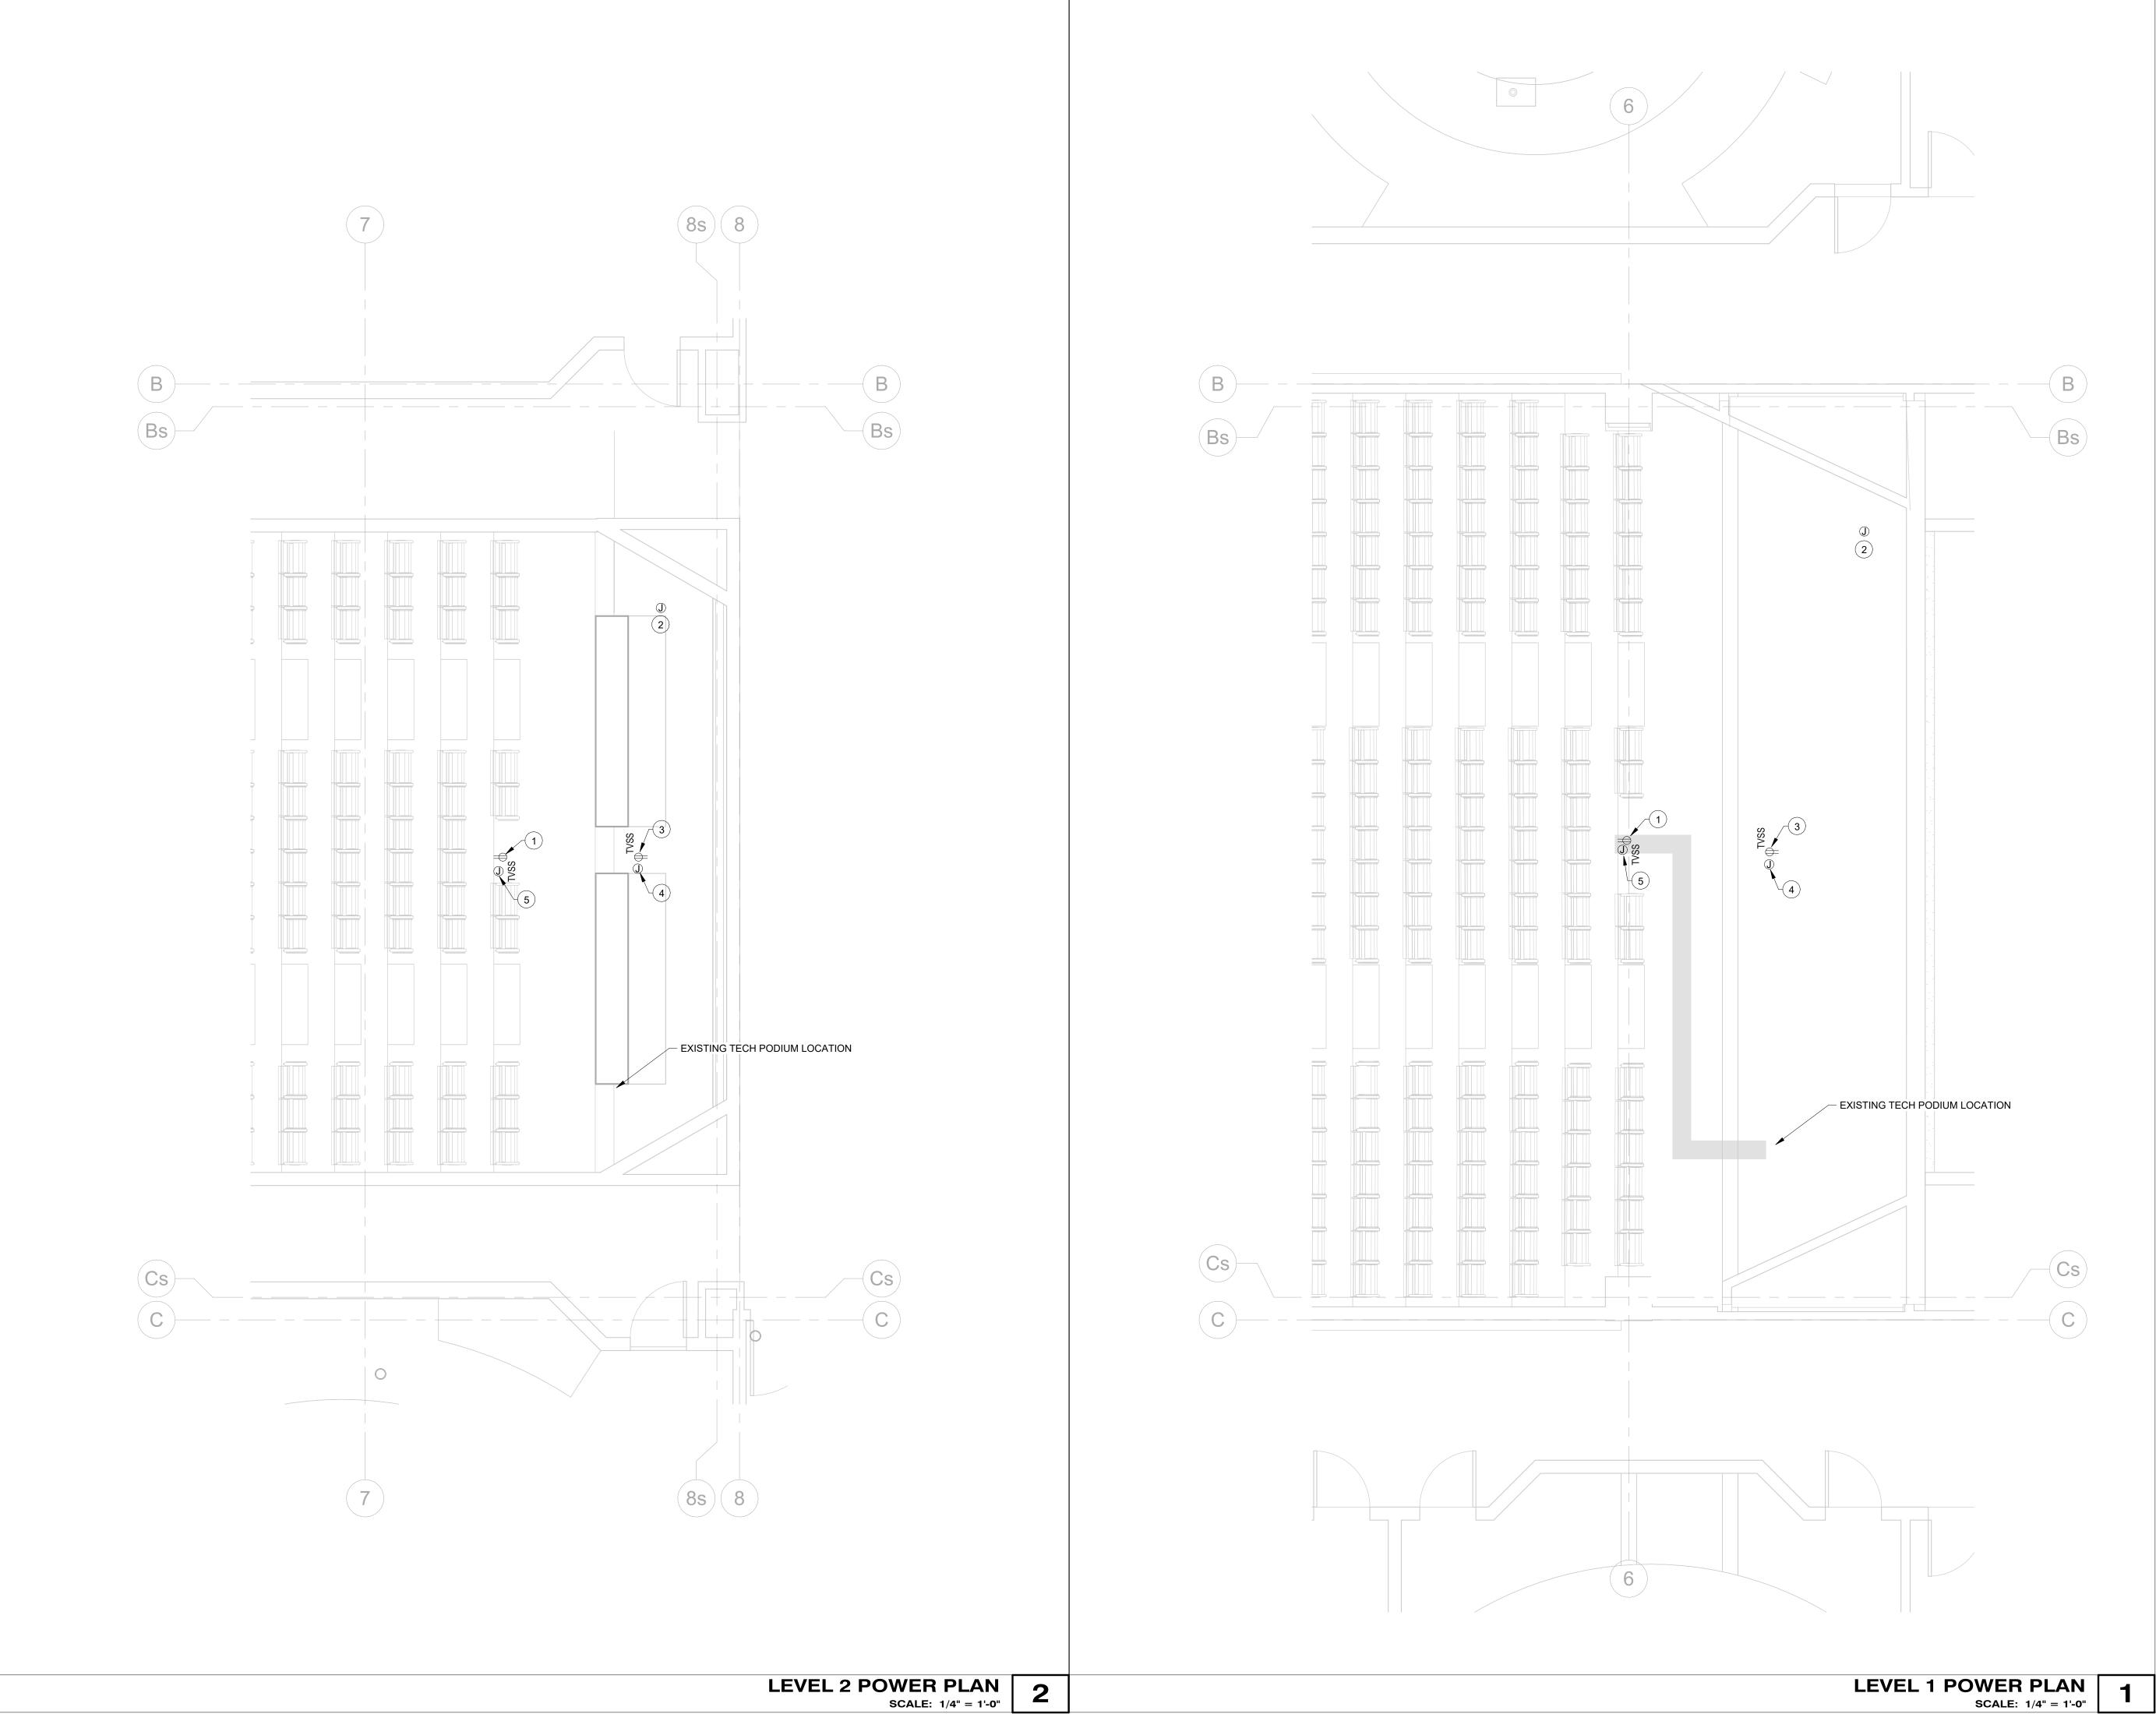
JILDING (TNRB) - LEVEL 1



LEVEL 2 LIGHTING PLAN

WORK ORDER & SHEET NO.

M3728 **E2.2** 



- 1 SURFACE MOUNT NEW RECEPTACLE TO FACE OF RISER. EXTEND EXISTING RECEPTACLE CIRCUIT FROM EXISTING TECH PODIUM TO NEW RECEPTACLE VIA 3/4"C W/(2)#12, #12
- 2 NEW LOCATION OF EXISTING SCREEN. 3 NEW RECEPTACLE FOR SHORT-THROW PROJECTOR. CONNECT TO NEAREST EXISTING RECEPTACLE CIRCUIT VIA 3/4"C W/(2)#12, #12 GND. COORDINATE EXACT LOCATION WITH OIT
- DRAWINGS. 4 INSTALL 1" CONDUIT FROM PROJECTOR TO TECH PODIUM. INSTALL PULL CORD AND NYLON BUSHINGS.
- 5 INSTALL 1-1/2" CONDUIT FROM FLAT PANEL DISPLAY TO TECH PODIUM. INSTALL PULL CORD AND NYLON BUSHINGS.



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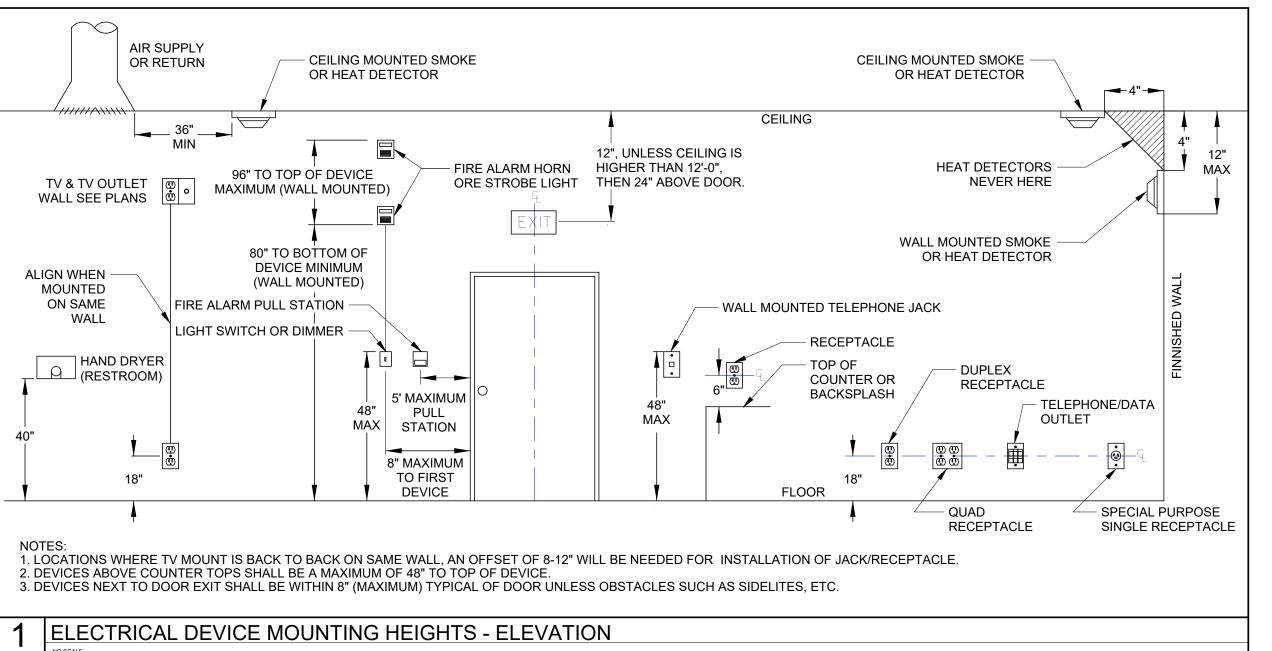
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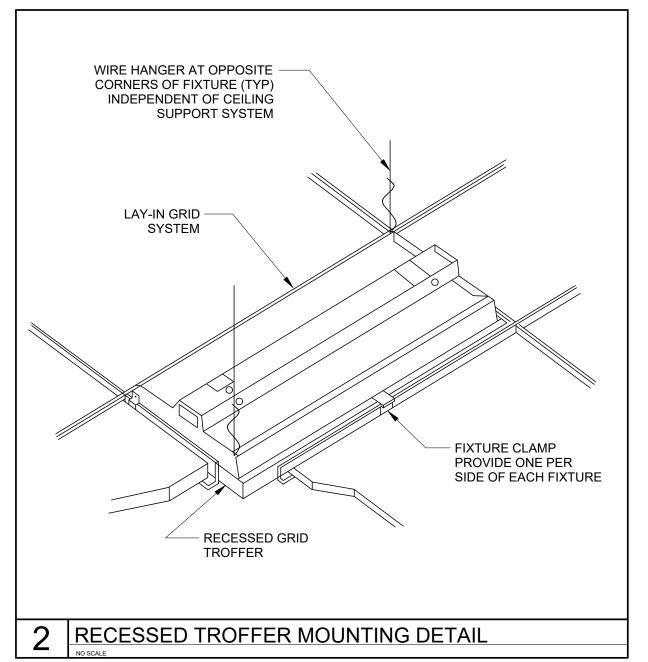
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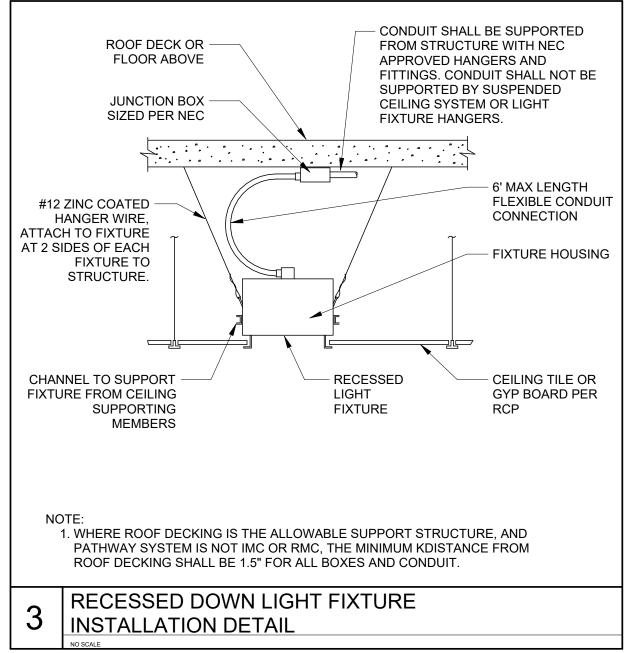
**LEVELS 1 & 2** POWER PLANS


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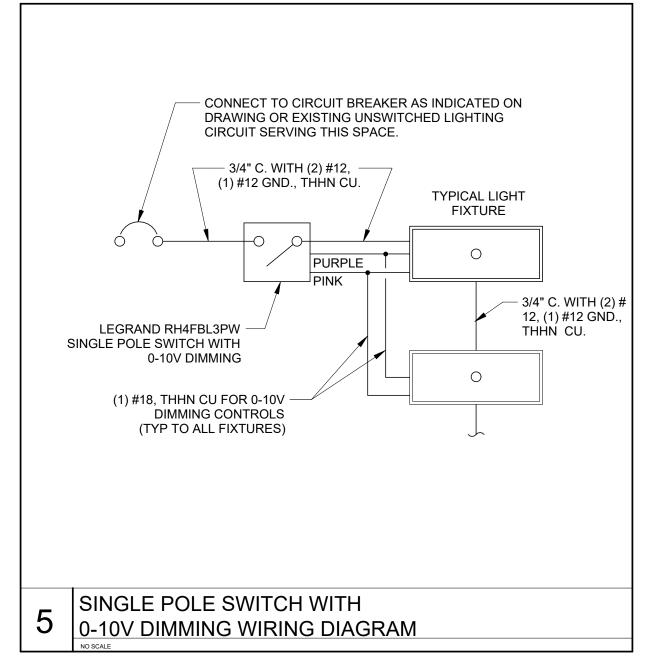
M3728 E3.1










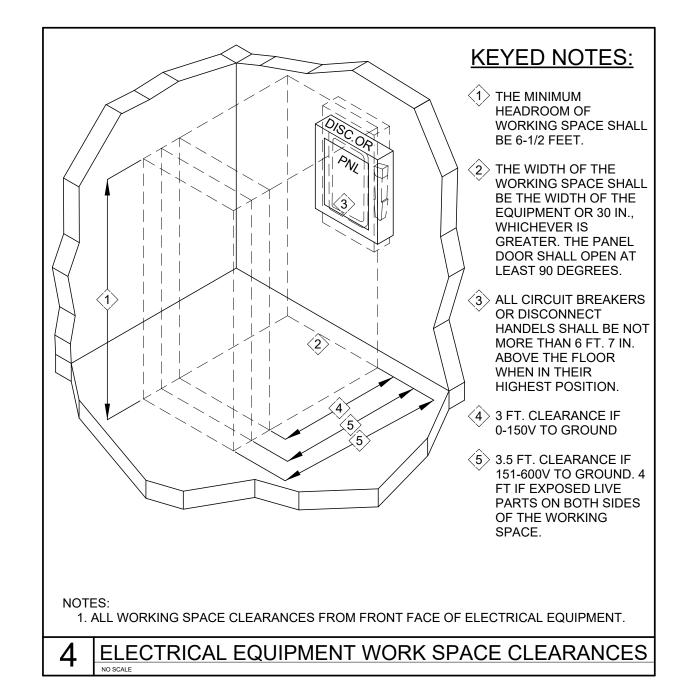

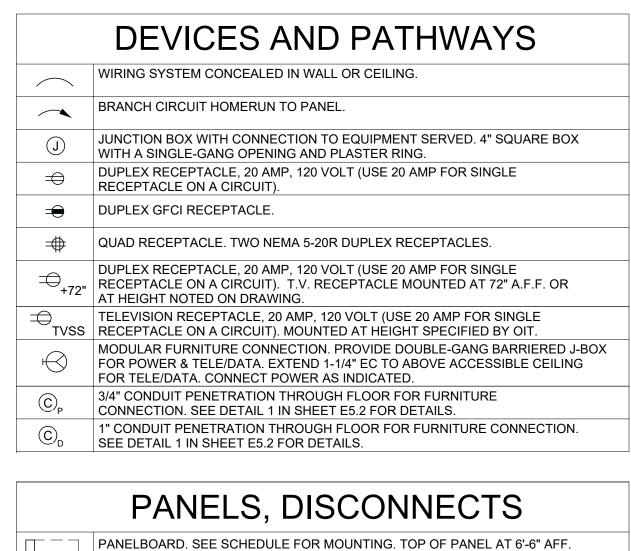


•	FOR TELE/DATA. CONNECT POWER AS INDICATED.
(C) <sub>P</sub>	3/4" CONDUIT PENETRATION THROUGH FLOOR FOR FURNITURE CONNECTION. SEE DETAIL 1 IN SHEET E5.2 FOR DETAILS.
© <sub>D</sub>	1" CONDUIT PENETRATION THROUGH FLOOR FOR FURNITURE CONNECTION. SEE DETAIL 1 IN SHEET E5.2 FOR DETAILS.
	PANELS, DISCONNECTS
	PANELBOARD. SEE SCHEDULE FOR MOUNTING. TOP OF PANEL AT 6'-6" AFF.
	TELECOMMUNICATIONS

TELE/DATA OUTLET. 1" EC TO ABOVE NEAREST ACCESSIBLE CEILING FOR J-HOOK

SYSTEM OR TO LOCAL CABLE TRAY (WITHIN 6") AS APPLICABLE WITH PULL STRING.


4" SQUARE BOX WITH A SINGLE-GANG OPENING AND PLASTER RING.

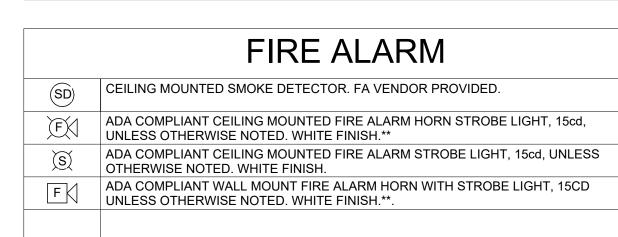

CEILING MOUNTED OCCUPANCY SENSOR, DUAL TECHNOLOGY.

CEILING MOUNTED OCCUPANCY SENSOR POWER PACK.

EMERGENCY LIGHTING CONTROLLER MODULE.

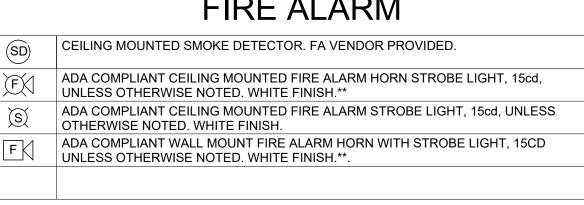

U.G.

LIGHTING (SEE FIXTURE SCH.)

LED LINEAR PENDANT LIGHT

SCHEDULE.

**GENERAL NOTES** 

1. CONTACT THE ENGINEER AS SOON AS

2. FOLLOW THE DESIGN AS PER THESE

REVIEWED WITH THE ENGINEER.

3. SEE OIT DRAWINGS FOR PATHWAYS AND J-BOXES REQUIRED FOR TELE/DATA

CONTRACTOR SHALL INCLUDE ALL

STANDARD PLANS. ANY CHANGES,

ADDITIONS, OR ADJUSTMENTS SHALL BE

AND AUDIO/VISUAL NEEDS. ELECTRICAL

REQUIRED PATHWAYS AND BACK BOXES

4. ALL CONDUIT PENETRATIONS THROUGH

WALLS, FLOORS, AND CEILINGS SHALL

REQUIRED BY THE LATEST ADOPTED

HAVE FIRE CAULKING APPLIED AS

REVISION OF THE IFC AND IBC.

ARE DISCOVERED.

IN HIS BID.

POSSIBLE IF DESIGN IRREGULARITIES

LED RECESSED DOWN LIGHT

SCHEDULE FOR FIXTURE TYPE

LOW VOLTAGE LIGHT SWITCH.

LIGHTING ROOM CONTROLLER.

SINGLE POLE SWITCH, 20 AMP, 120/277 VOLT.

THREE WAY SWITCH, 20 AMP, 120/277 VOLT.

LED GRID TROFFER FIXTURE. SEE FIXTURE SCHEDULE. SUSPEND TWO CORNERS

WITH WIRE TO STRUCTURE. DO NOT ALLOW GRID ALONE TO SUPPORT FIXTURE.

LED FIXTURE CONNECTED TO EMERGENCY LIGHTING CIRCUIT. SEE FIXTURE

EXIT LIGHT WITH ARROWS AND NUMBERS OF FACES AS INDICATED ON PLANS. CONNECTED TO EMERGENCY LIGHTING CIRCUIT. SEE LIGHTING FIXTURE

WALL MOUNTED OCCUPANCY SENSOR AND SWITCH WITH DUAL TECHNOLOGY

## **ABBREVIATIONS**


+42"	DIMENSION INDICATES HEIGHT ABOVE FINISHED FLOOR AT WHICH CENTER OF DEVICE IS TO BE MOUNTED. SEE PLANS
3R	NEMA 3R RATING
AFF	ABOVE FINISHED FLOOR
AHJ	AUTHORITY HAVING JURISDICTION
AHU	AIR HANDLER UNIT
С	CONDUIT WITH PULL CORD
C.B.	CIRCUIT BREAKER
CLG	INSTALLED IN CEILING
EC	EMPTY CONDUIT WITH PULL CORD
E.C.	ELECTRICAL CONTRACTOR

EWC ELECTRIC WATER COOLER EWH ELECTRIC WATER HEATER FACP FIRE ALARM CONTROL PANEL FPN FUSE PER NAMEPLATE LIGHTING CONTACTOR M.C. MECHANICAL CONTRACTOR P.C. PLUMBING CONTRACTOR

UNDERGROUND

WP WEATHER PROOF SERVICE ENTRANCE EMERGENCY FIXTURE WITH BATTERY OR GENERATOR BACK-UP RMS SYMMETRICAL SHORT CIRCUIT

AMPERE INTERRUPTING CAPACITY (EQUIPMENT RATING) TVSS SURGE PROTECTION DEVICE MOUNTED AT HEIGHT DESIGNATED BY OIT.

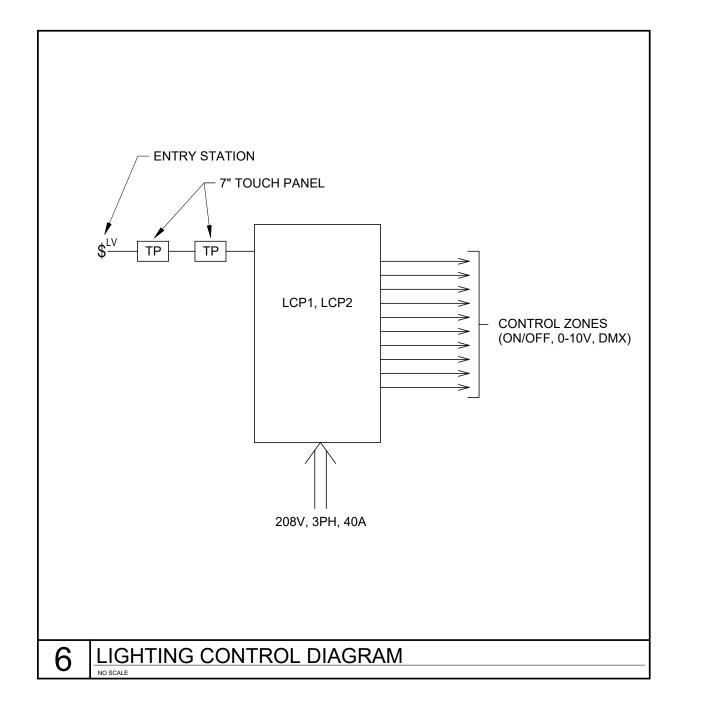



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**ELECTRICAL** SCHEDULES SYMBOLS & **DETAILS** 

**WORK ORDER & SHEET NO.** 

M3728

LIGHTING CONTROL PANEL "LCP1" SCHEDULE								DIMMING SCHEDULE		
IOUNTING: SURFACE LOCATION: 151C								VOLTAGE		
ZONE NUMBER	SUPPLY	VA	ZONE DESCRIPTION	TOUCH PANEL	ENTRY STATION	0-100	DMX	LINE VC		
1	EXIST 208V/3	630	RECESSED CANS (REAR)	Х		Х				
2	EXIST 208V/3	800	FLAT PANELS (REAR)	Х	Х	Х				
3	EXIST 208V/3	400	FLAT PANELS (FRONT)	Х	х	Х				
4	EXIST 208V/3	290	RECESSED CANS (FRONT)	Х		х				
5	EXIST 208V/3	336	LINEAR PENDANT X			Х				
6	EXIST 208V/3	180	LINEAR RECESSED	Х		х				
7	EXIST 208V/3	300	TRACK LIGHTS (CKT 1)	Х				х		
8	EXIST 208V/3	300	TRACK LIGHTS (CKT 2)	Х				х		
9	EXIST 208V/3	208	SPOT LIGHT (CENTER)	Х			х			
10	EXIST 208V/3	208	SPOT LIGHT (SOUTH)	Х			х			
11	EXIST 208V/3	10	TECH PODIUM PIN SPOT	Х		Х				
12		0						$\overline{}$		

L	IGHTING (	CONTR	OL PANEL "LCP2" SCI	HEDULE	1	DIMI	MING	SCHE	וטכ
OUNTING:	SURFACE	LOCATION	: 251A					LINE VOLTAGE	
ZONE NUMBER	SUPPLY	VA	ZONE DESCRIPTION	TOUCH PANEL	ENTRY STATION	0-10V	DMX	LINE V	
1	EXIST 208V/3	484	RECESSED CANS (REAR)	Х		х			
2	EXIST 208V/3	400	FLAT PANELS (REAR)	Х	х	Х			
3	EXIST 208V/3	100	FLAT PANELS (FRONT)	Х	х	Х			Γ
4	EXIST 208V/3	121	RECESSED CANS (FRONT)	Х		Х			Γ
5	EXIST 208V/3	252	LINEAR PENDANT	Х		Х			Г
6	EXIST 208V/3	134	LINEAR RECESSED	Х		Х			Г
7	EXIST 208V/3	300	TRACK LIGHTS (CKT 1)	Х				х	Г
8	EXIST 208V/3	300	TRACK LIGHTS (CKT 2)	Х				х	Г
9	EXIST 208V/3	208	SPOT LIGHT (CENTER)	Х			х		Г
10	EXIST 208V/3	208	SPOT LIGHT (SOUTH)	Х			х		Γ
11	EXIST 208V/3	10	TECH PODIUM PIN SPOT	Х		х			Γ
12		0							T

	LIGHT FIXTURE SCHEDULE								
FIXTURE	FIXTURE	FIXTURE	LUMENC	COT	FIXTUE	200	MOUNTING	DESCRIPTION	
NUMBER F1	MANUFACTURER  HALO COMMERCIAL LIGHTOLIER ELITE DMF LITON	CATALOG NUMBER  HC630D010 HM630408040 61MDC 6RN P6RDL30940MCDZ10U HH6-LED-3000L-DIM10-MVOLT-MD-40K-90/HH6-6501-CL-WH M4NCRN/MD-30-9-40-FL-O/M4TRS-WH CH630UE-0-D10-CR6L36-CW-T40	3000	4000K	UNV	24.2	DECESSED	LED DOWNLIGHT WITH CLEAR DIFFUSE TRIM, 0-10V DIMMING	
F2	SYLVANIA METALUX SLG LITHONIA ELITE RAB PORTOR	PANELF4BS/045UNVD8SC7/24G/WH 24CGTS-L3C3 TPS2435/45/55G2FSK CPX 2X4 ALO8 SWW7 24-FPL-BL-LED-3000L/4000L/5000L/6000L-DIM10-120-347V-30K/35K/40K/50K-85 T34FA-2x2 PT-BLP8-24-3CP	SELECT- ABLE	SELECT- ABLE	UNV	50	LAY-IN GRID	2X4 LED LAY-IN FLAT PANEL	
F3	TIMES SQUARE ALTMAN	TRH-8040-W-120-DT2-TE GAL-2550-4K-W-M-T	5200	4000K	120	50	HALO TRACK	FRAMING PROJECTOR TRACK HEAD (PROVIDE 12 PER ROOM)	
F4	HALO COMMERCIAL LIGHTOLIER ELITE LITON DMF	HC615D010 HM60525840 61MDC 6RN P6RDL15840CDZ10U HH6-LED-1500L-DIM10-MVOLT-MD-40K-90/HH6-6501-CL-WH CH610UE-D10-CR6L22-CW-T40 M4NCRN/MD-15-9-40-FL-O/M4TRS-WH	1500 LUMENS	4000K	UNV	12	RECESSED	LED DOWNLIGHT WITH CLEAR DIFFUSE TRIM, 0-10V DIMMING	
F5	PRUDENTIAL ELITE MARK ALL LUMENWERX	BPRO4-LINFLSHKED4HOR32'TMWLLLGPNUSCUNVCA48"X3DM01 OLS-D-LED-4-CR-32-750L-DIM10-MVOLT-40K-85-WH S4PD LLP 32FT MSL8 80CRI 40K 800LMF DBW SCT MIN1 FLL MVOLT WHTT ZT F2/72A RDCY WHTCY WCRD 3S-32'-MD-40-UNV-HC-WH-WHITECORD VIA4P-D-HLO-FH-SW-80CRI-800LMF-40K-32FT-UNV-D1-1C-ACS-W	24000	4000K	UNV	336	PENDANT	4" LINEAR PENDANT - 32'	
F6	PRUDENTIAL ELITE LUMENWERX ALL	BPRO4-LINFLSHKED4MOR32'TMWLLMGZNUSCUNVSURX3DM01 OLS-CM-LED-4-CR-32-500L-WW-DIM10-MVOLT-40K-85-WH VIA4S-D-WRO2-FH-SW-80CRI-350LMF-40K-32FT-UNV-D1-1C-TBD-TBD-W 3C-32'-LD-40-UNV-HC-WH	12960	4000K	UNV	180	SURFACE	4" LINEAR SURFACE WALL GRAZE - 3	
F7	CHAUVET ETC ALTMAN	REVE E-3 SOURCE FOUR LED SERIES 2 TUNGSTEN HD PHXLVD-5K-50-W/510-HD-BK	11512	3200K	120	208	LIGHT BAR	FULL SIZE SPOT	
F8	PUREEDGE LITELINE CONTECH LUCIFER	MR4R-TUBS-NS-3500K-WH-T1 STB16-BK ATF7607-40-06-90-XX PROVIDE MONOPOINT CANOPY CTL9051MPS4CD-P FA-92M-P CY2X-AW-1-WH-BK-90S17B-40-10-4-UCA-JBMP	481	4000K	120	8.5	SURFACE WALL	PINPOINT SPOT	
F9	PRUDENTIAL ELITE MARK ALL LUMENWERX	BPRO4-LINFLSHKED4HOR24'TMWLLLGPNUSCUNVCA48"X3DM01 OLS-D-LED-4-CR-24-750L-DIM10-MVOLT-40K-85-WH S4PD LLP 24FT MSL8 80CRI 40K 800LMF DBW SCT MIN1 FLL MVOLT WHTT ZT F2/72A RDCY WHTCY WCRD 3S-24'-MD-40-UNV-HC-WH-WHITECORD VIA4P-D-HLO-FH-SW-80CRI-750LMF-40K-24FT-UNV-D1-1C-TBD-TBD-W	18000	4000K	UNV	252	PENDANT	4" LINEAR PENDANT - 24'	
F10	PRUDENTIAL ELITE LUMENWERX ALL	BPRO4-LINFLSHKED4MOR24'TMWLLMGZNUSCUNVSURX3DM01 OLS-CM-LED-4-CR-24-500L-WW-DIM10-MVOLT-40K-85-WH VIA4S-D-WRO2-FH-SW-80CRI-400LMF-40K-24FT-UNV-D1-1C-TBD-TBD-W 3C-24'-LD-40-UNV-HC-WH	9720	4000K	UNV	134	SURFACE	4" LINEAR SURFACE WALL GRAZE - 2	
EM	DUAL-LITE	CLMLAC	561	5000K	120/277	18	RECESSED	CONCEALED EMERGENCY LIGHTING UNI	



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DATE: 03/13/2024
DESIGNER: SRG
DRAWN BY: SRG

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CLIENT APPROVAL DATE

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REMODEL AUDITORIUM 151 PHYSICAL FACILITIES


PANDA STEVEN R. GRIFFITHS 03/3/3/2024


ELECTRICAL SCHEDULES

WORK ORDER & SHEET NO.

M3728 E4.2

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Office of IT: Temporarily remove TEC podium, associated equipment and coil cabling

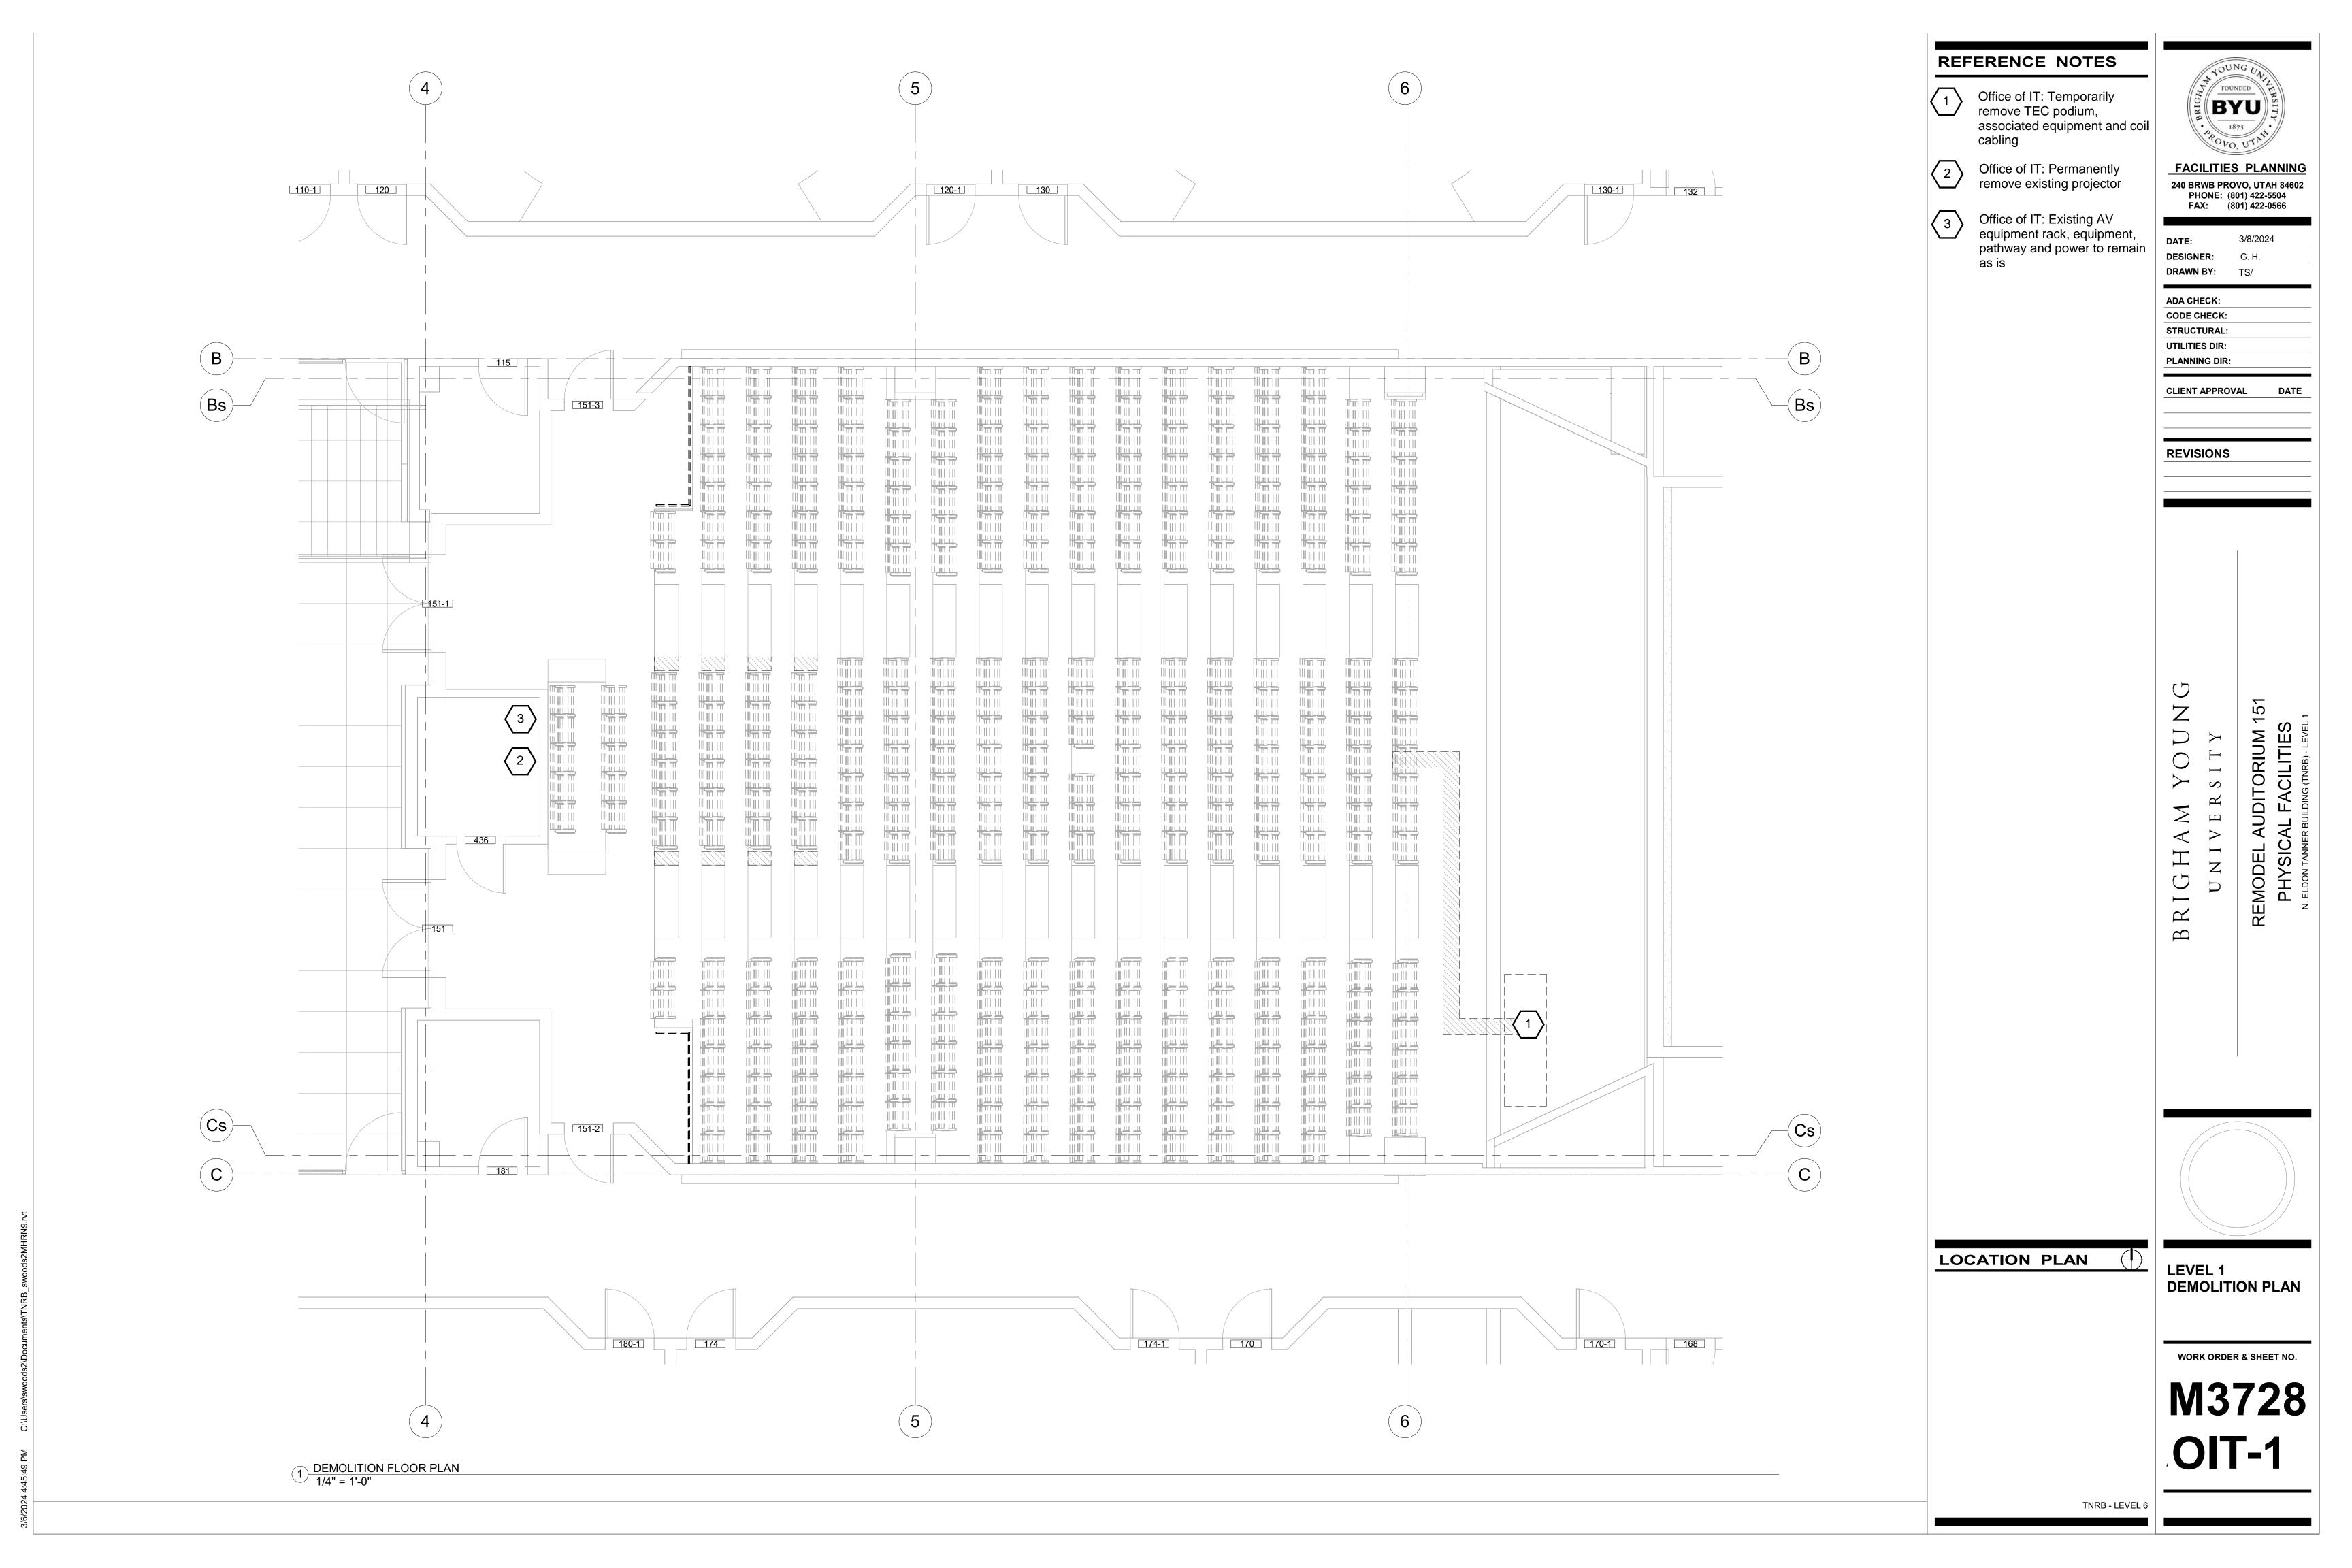Office of IT: Permanently remove existing projector

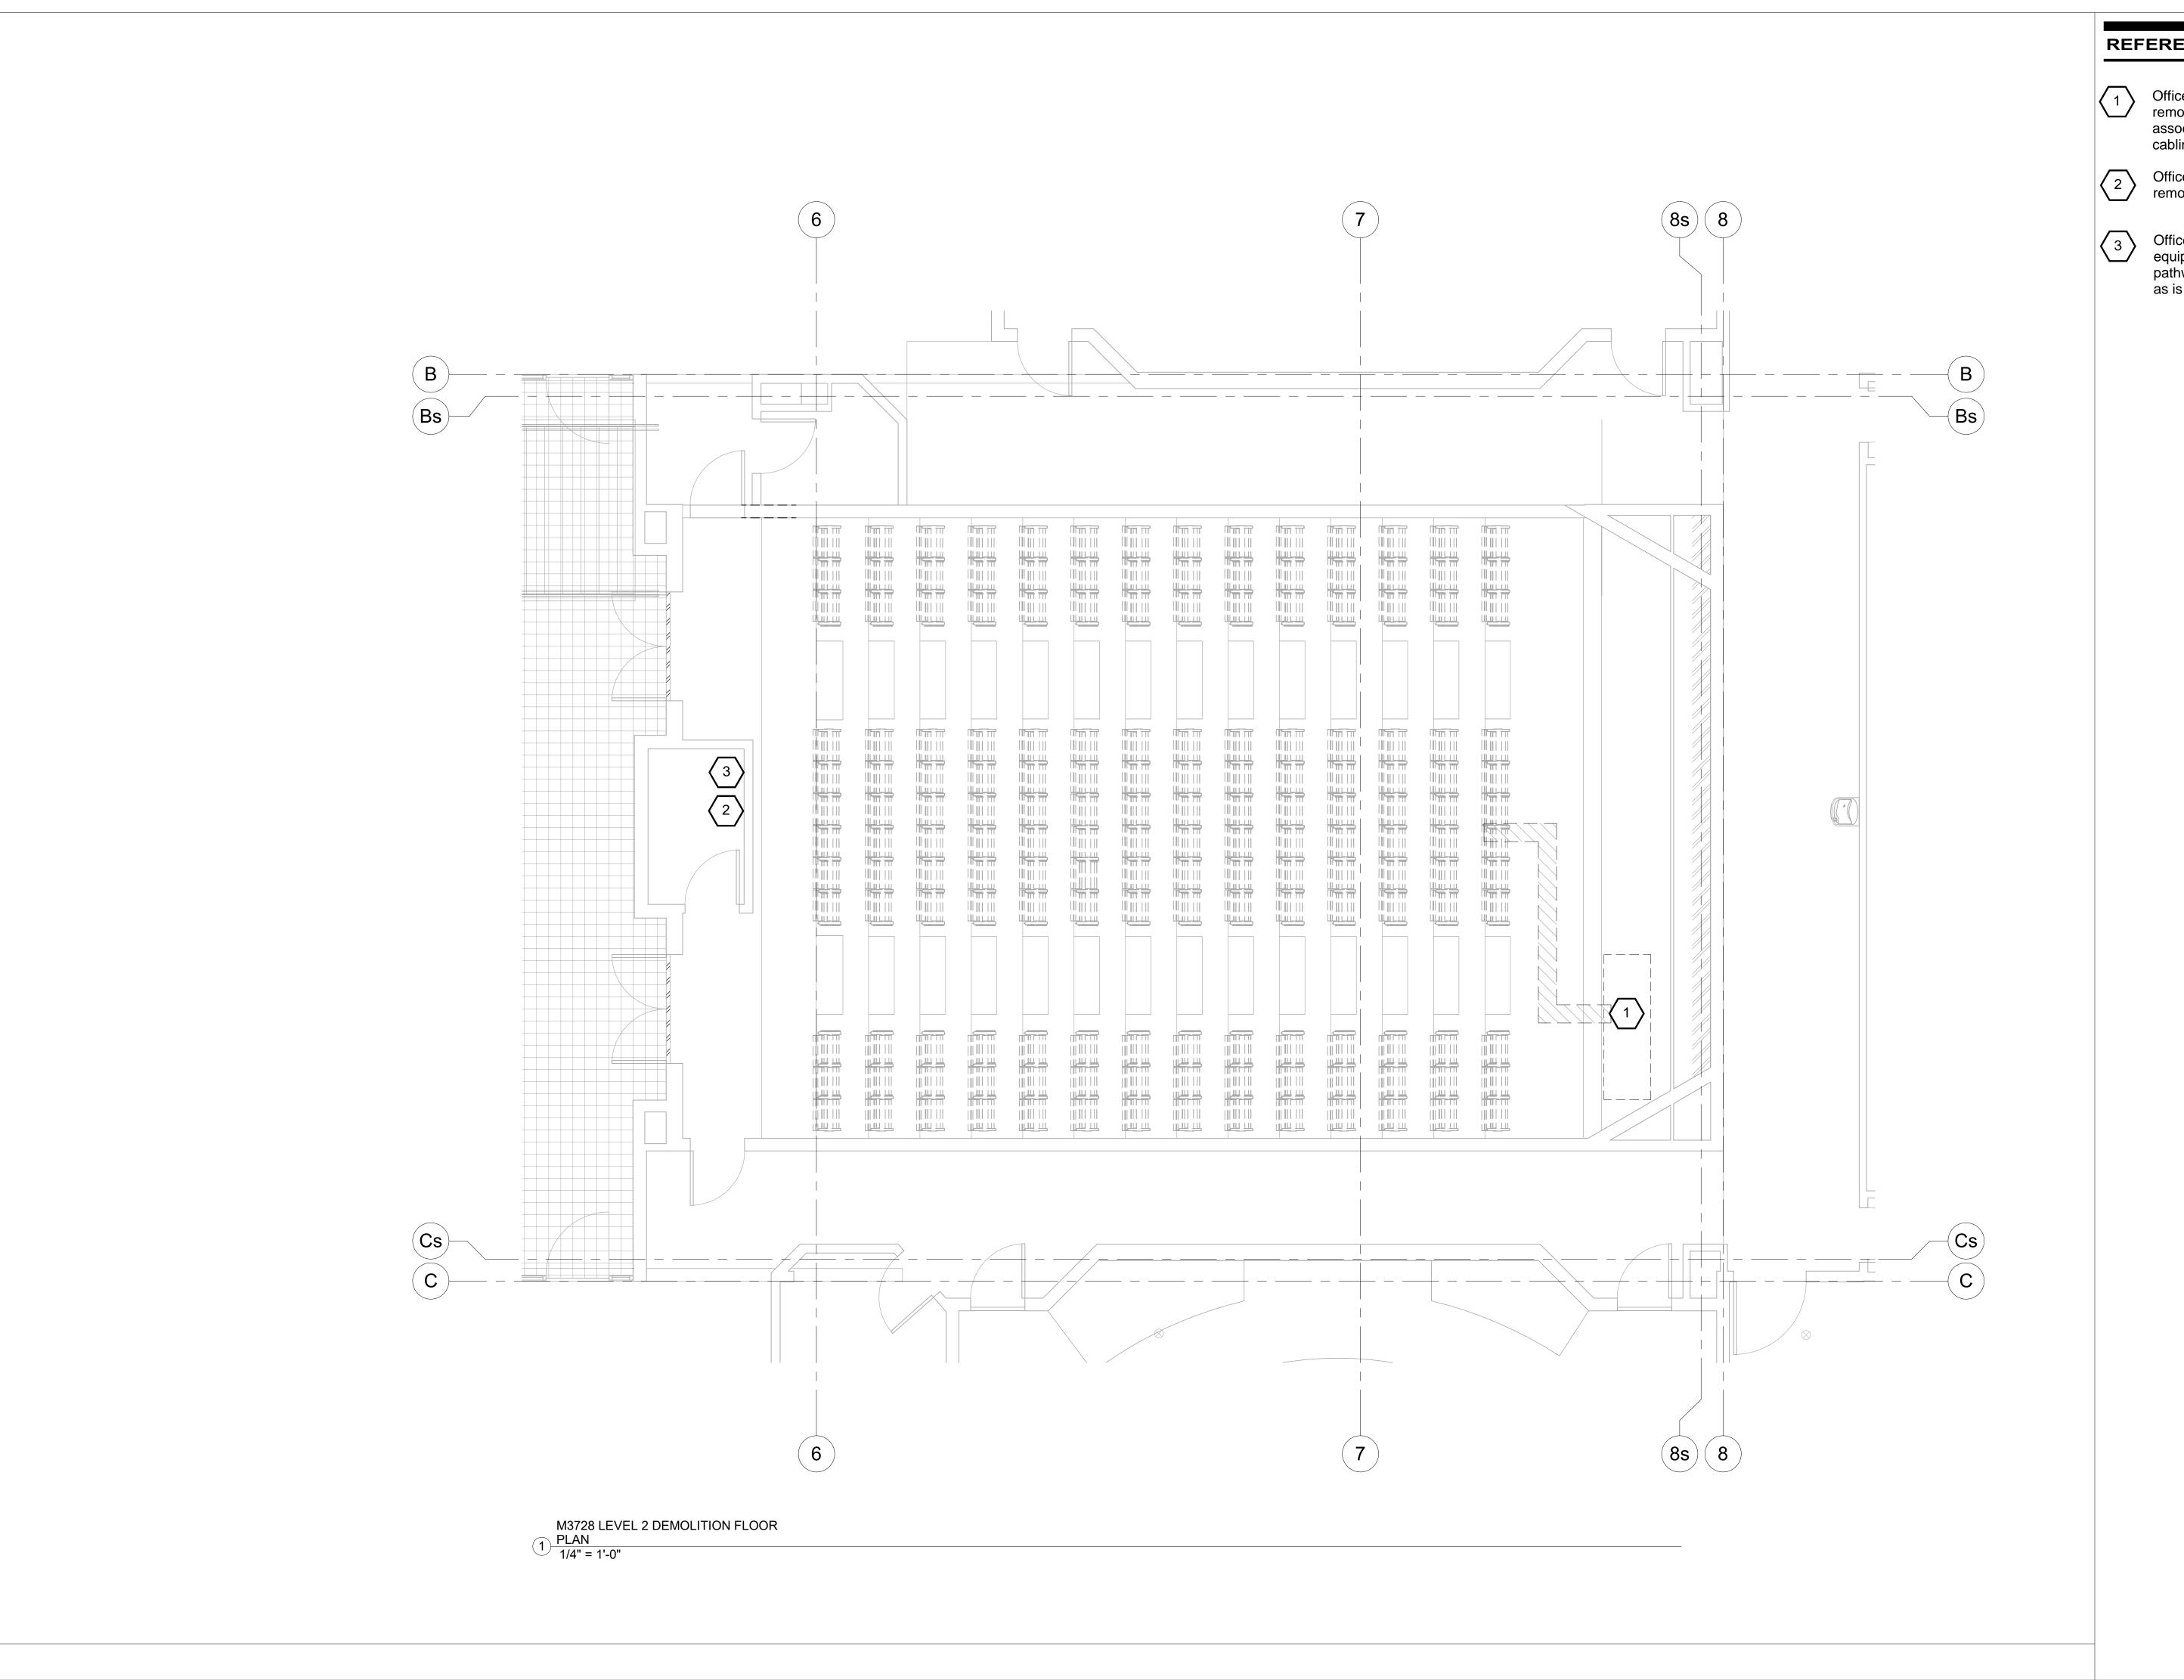Office of IT: Existing AV equipment rack, equipment, pathway and power to remain as is



FACILITIES PLANNING

240 BRWB PROVO, UTAH 84602
PHONE: (801) 422-5504
FAX: (801) 422-0566

ATE:	3/8/2024
ESIGNER:	G. H.
DAWN DV:	TQ/

DESIGNER: G. H.
DRAWN BY: TS/


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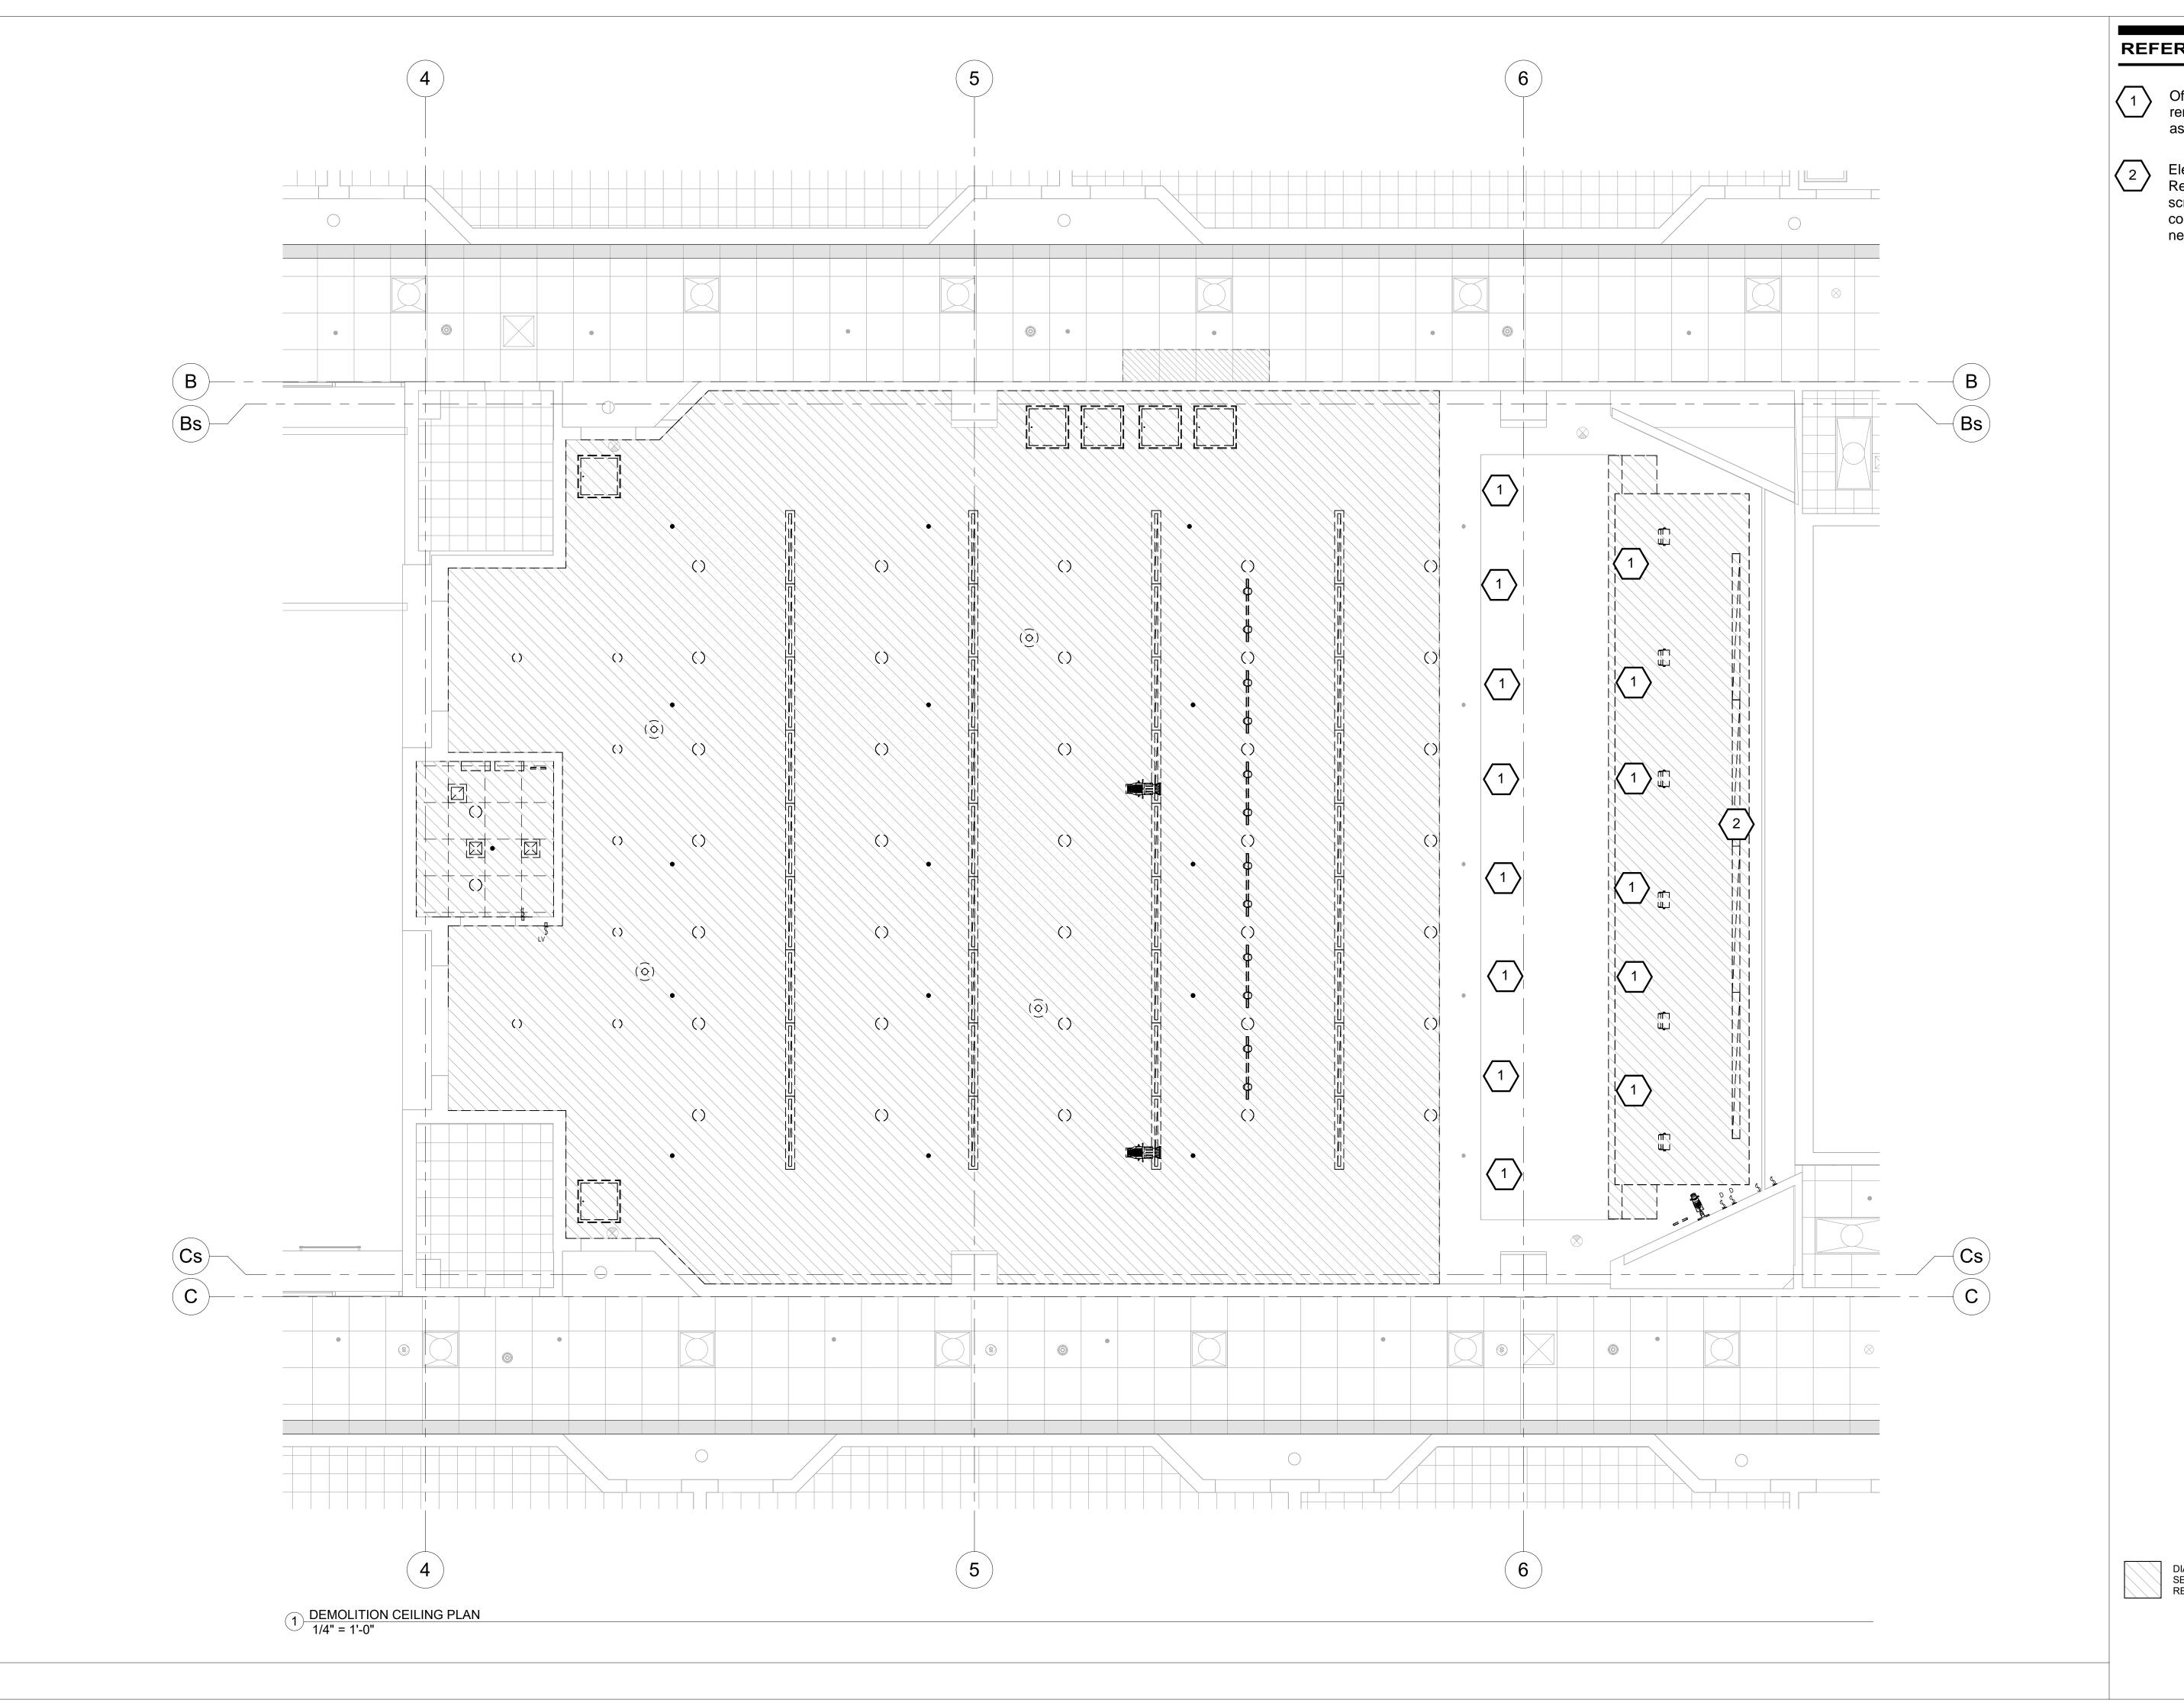
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EMODEL AUDITORIUM 151 PHYSICAL FACILITIES



LEVEL 2
DEMOLITION PLAN

WORK ORDER & SHEET NO.

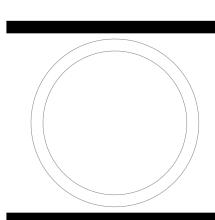

Office of IT: Permanently remove speakers and associated cabling

Electrical Contractor:
Remove existing motorized screen; power and screen control to be reconnected to new projection screen



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FAX: (801) 422-0566

 DATE:
 3/8/2024

 DESIGNER:
 G. H.

DRAWN BY: TS/

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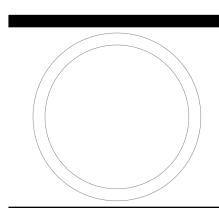
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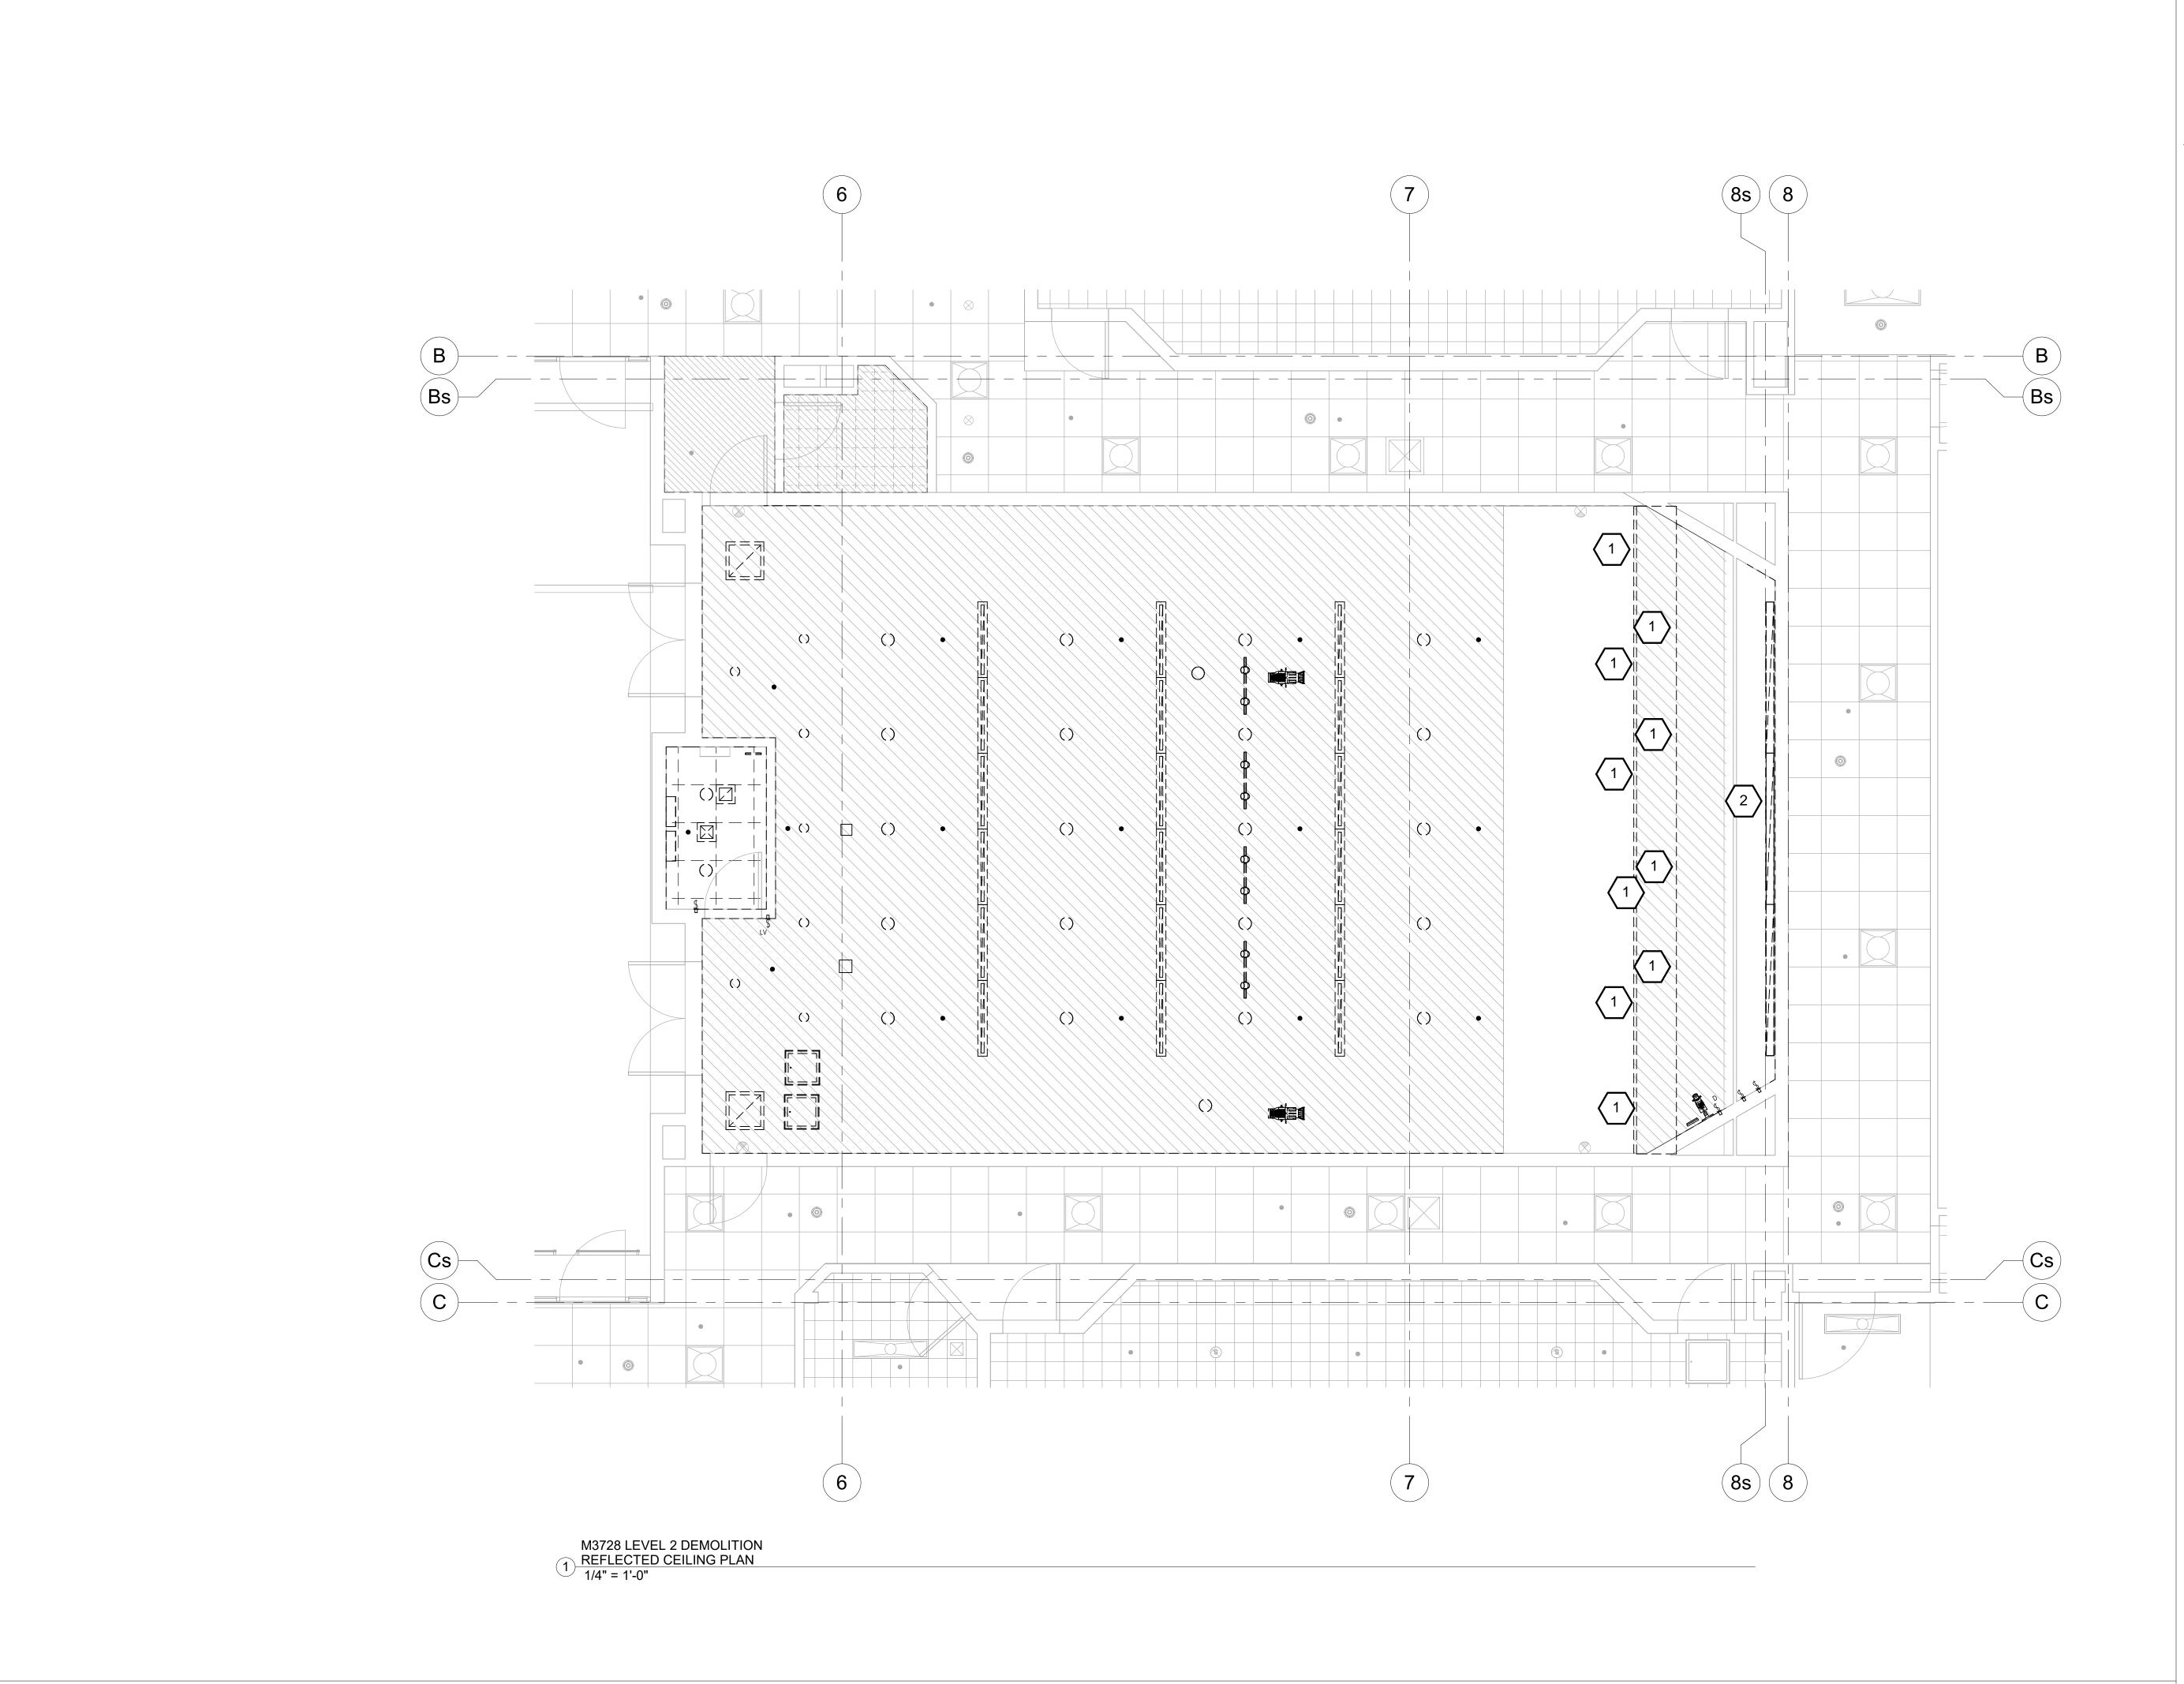


LEVEL 1
DEMOLITION
REFLECTED
CEILING PLAN

WORK ORDER & SHEET NO.

M3728 OIT-3

DIAGONAL HATCH AREA INDICATES SECTION OF CEILING TO BE REMOVED OR ALTERED



Office of IT: Permanently remove speakers and associated cabling



**Electrical Contractor:** Remove existing motorized screen; power and screen control to be reconnected to new projection screen



**FACILITIES PLANNING** 240 BRWB PROVO, UTAH 84602 PHONE: (801) 422-5504 FAX: (801) 422-0566

SIGNER: G.	H.
ATE: 3/8	3/2024


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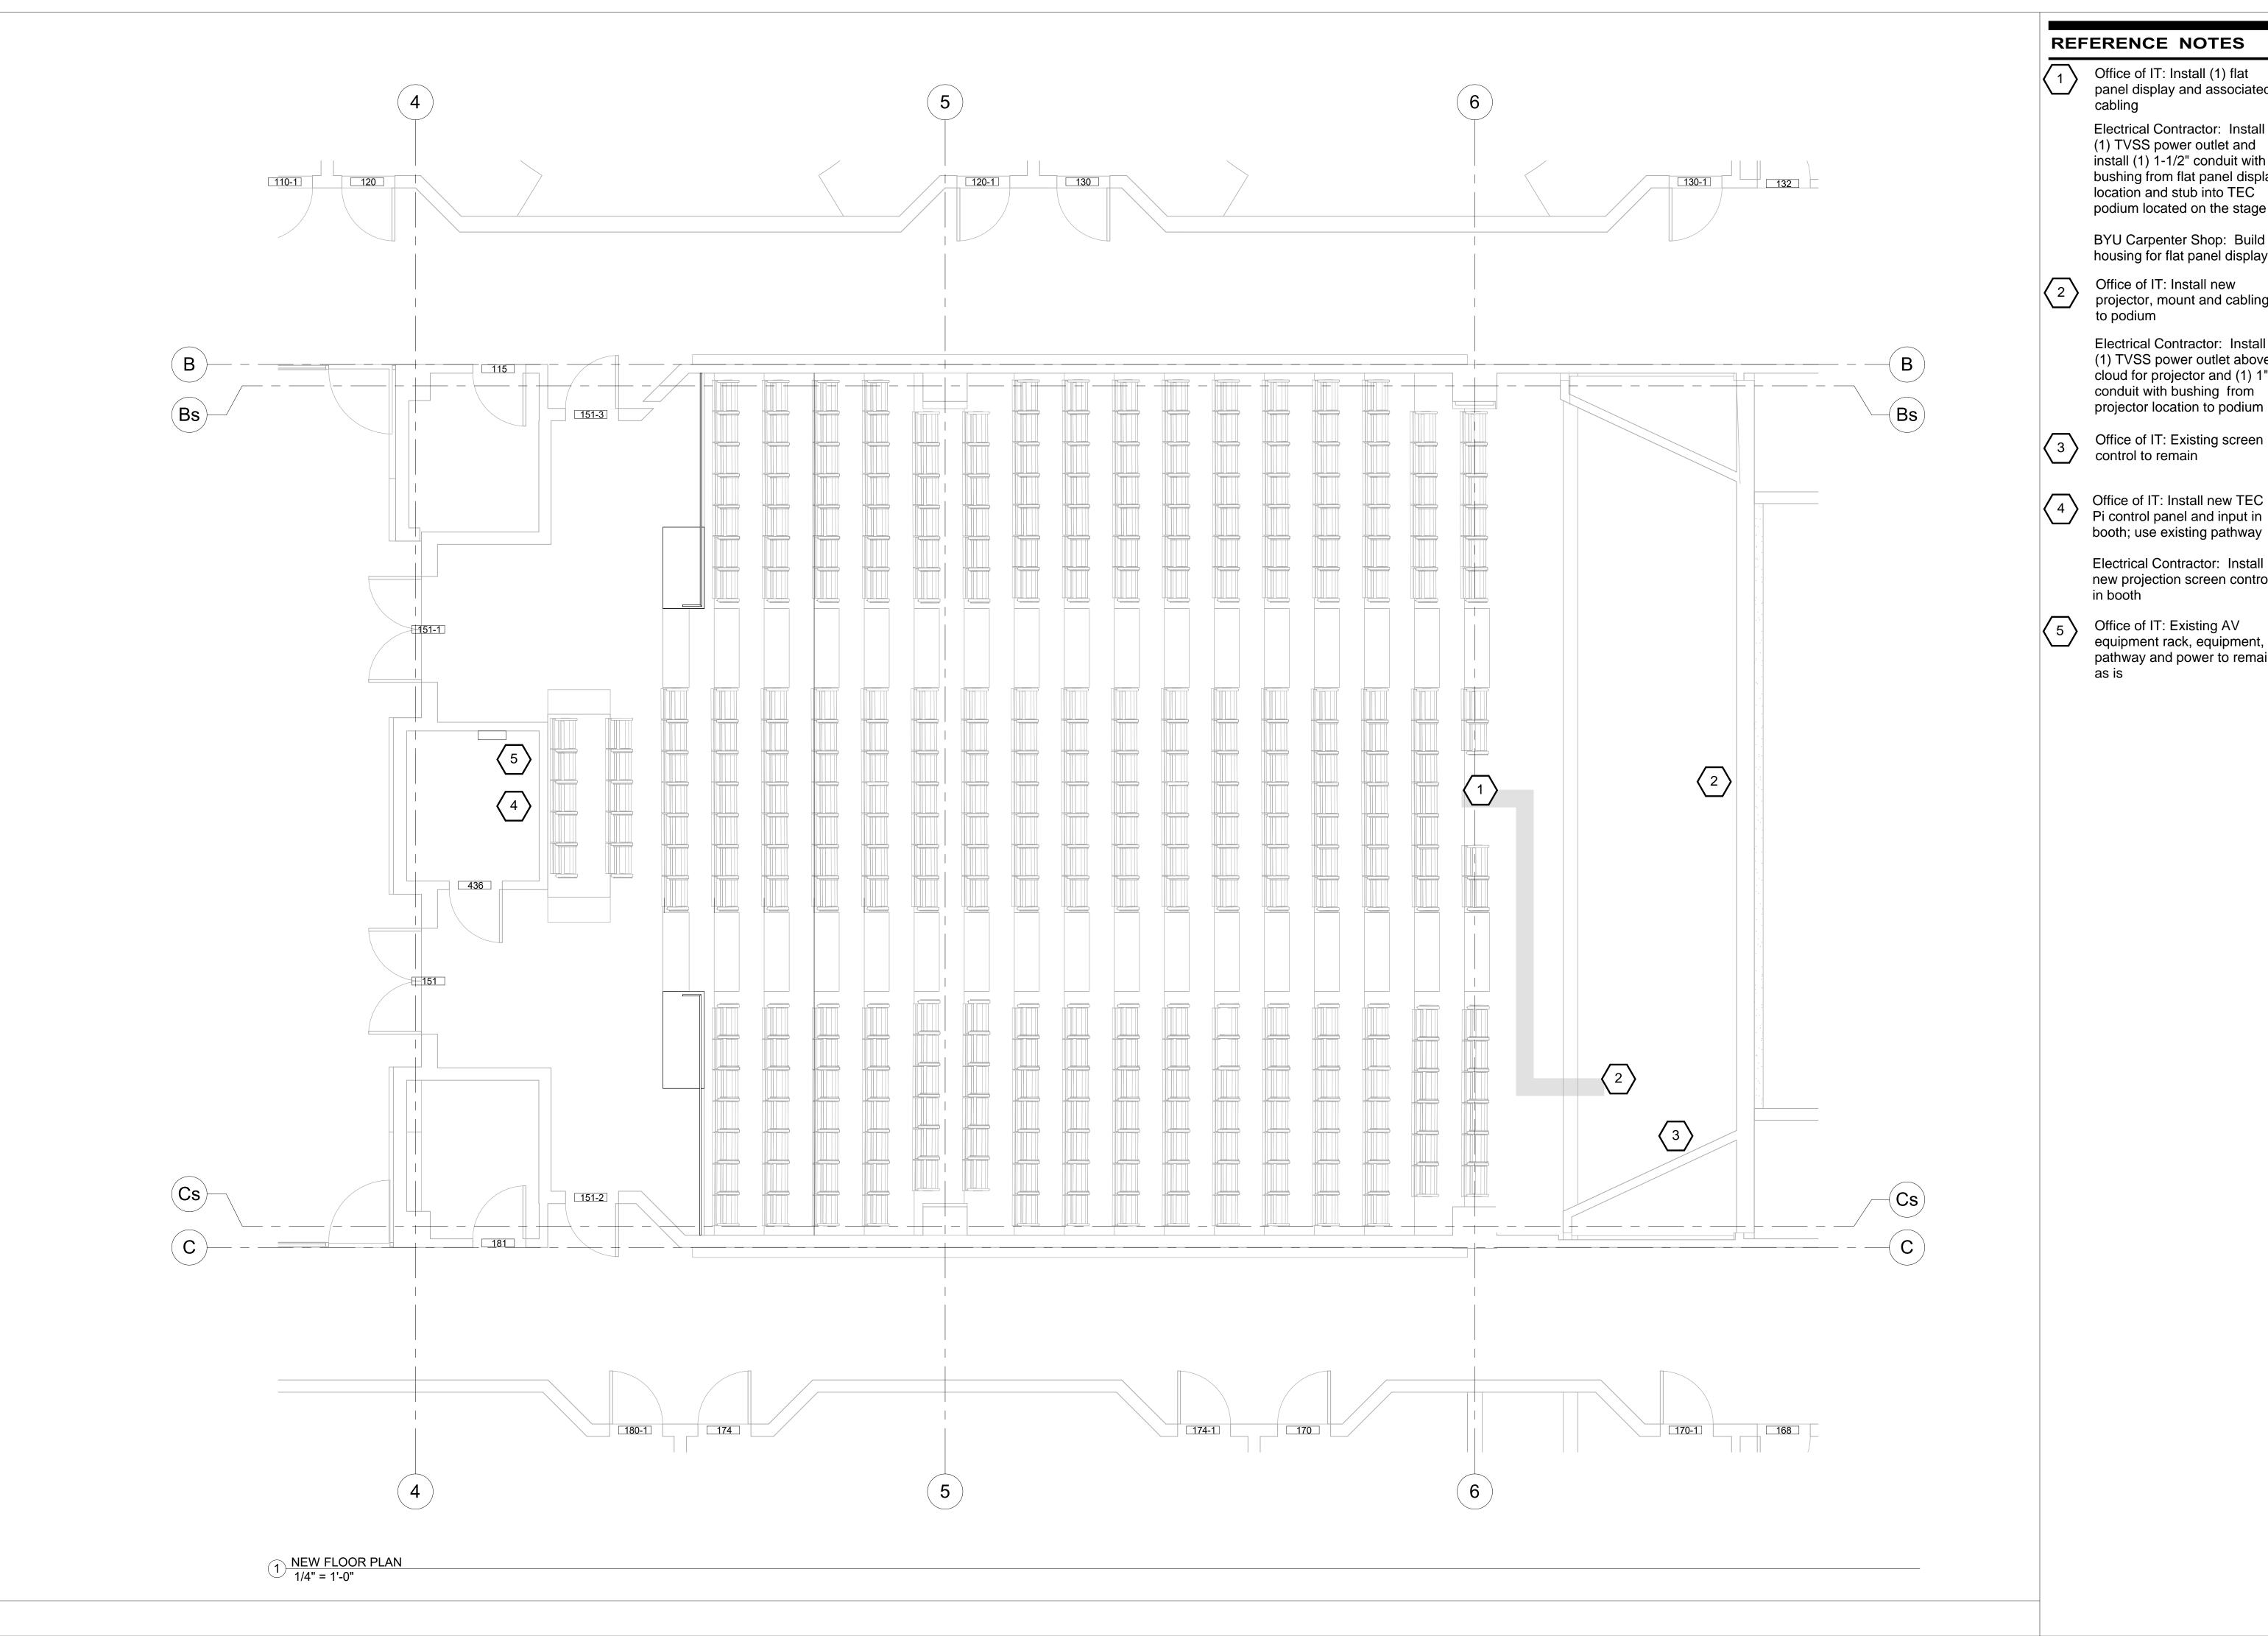
**CLIENT APPROVAL** 

**REVISIONS** 



LEVEL 2 DEMOLITION REFLECTED **CEILING PLAN** 

WORK ORDER & SHEET NO.

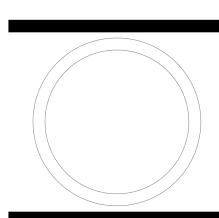


Office of IT: Install (1) flat panel display and associated cabling

Electrical Contractor: Install (1) TVSS power outlet and install (1) 1-1/2" conduit with bushing from flat panel display location and stub into TEC podium located on the stage


BYU Carpenter Shop: Build housing for flat panel display

Office of IT: Install new projector, mount and cabling to podium

Electrical Contractor: Install (1) TVSS power outlet above cloud for projector and (1) 1" conduit with bushing from projector location to podium

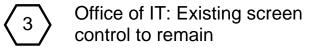

control to remain

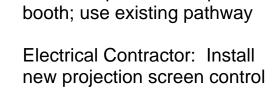

Office of IT: Existing AV equipment rack, equipment, pathway and power to remain as is



**FACILITIES PLANNING** 240 BRWB PROVO, UTAH 84602 PHONE: (801) 422-5504 FAX: (801) 422-0566

ATE:	3/8/2024
ESIGNER:	Designer

DRAWN BY: TS/


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**CLIENT APPROVAL** 

**REVISIONS** 


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LEVEL 1 FLOOR PLAN

WORK ORDER & SHEET NO.

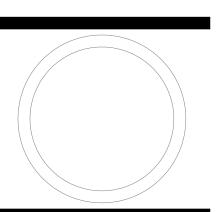

Office of IT: Install (1) flat panel display and associated cabling

Electrical Contractor: Install (1) TVSS power outlet and install (1) 1-1/2" conduit with bushing from flat panel display location and stub into TEC podium located on the stage

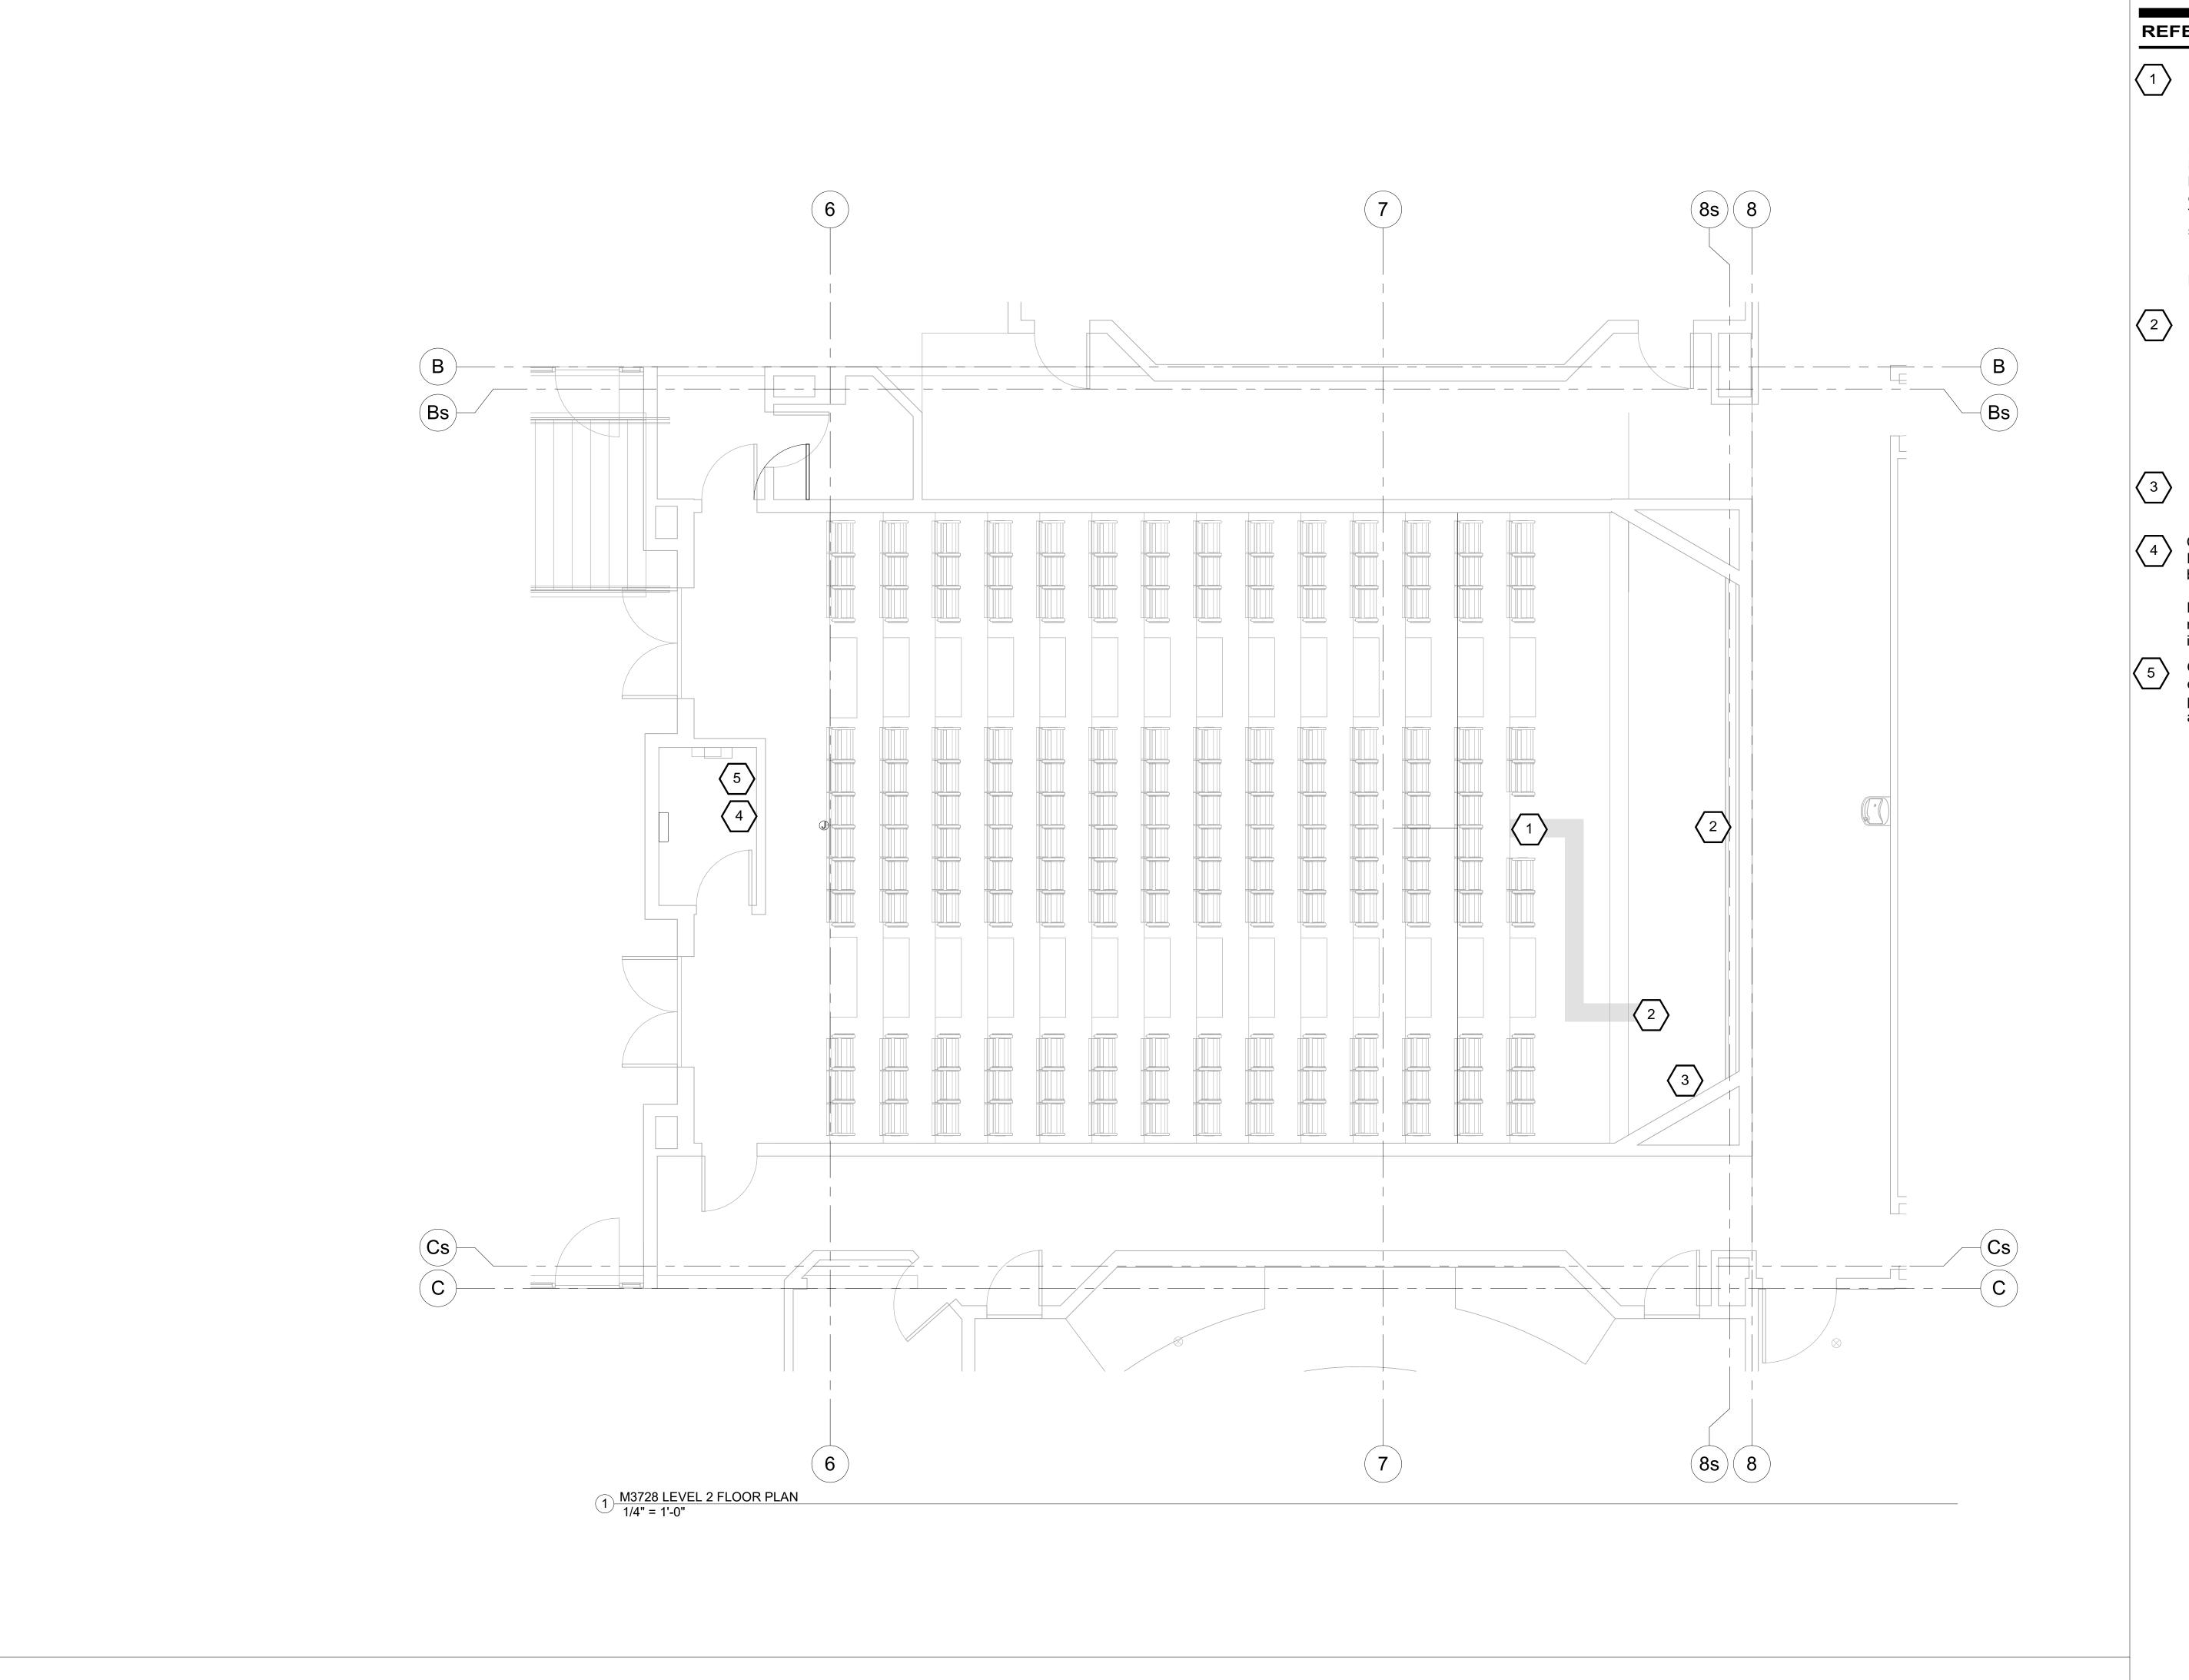BYU Carpenter Shop: Build housing for flat panel display

Office of IT: Install new projector, mount and cabling to podium

Electrical Contractor: Install (1) TVSS power outlet above cloud for projector and (1) 1" conduit with bushing from projector location to podium

Office of IT: Existing screen

control to remain

Office of IT: Install new TEC Pi control panel and input in booth; use existing pathway

Electrical Contractor: Install new projection screen control in booth

Office of IT: Existing AV equipment rack, equipment, pathway and power to remain as is




**FACILITIES PLANNING** 240 BRWB PROVO, UTAH 84602 PHONE: (801) 422-5504 FAX: (801) 422-0566

3/8/2024 DATE: **DESIGNER:** G. H. DRAWN BY: TS/

ADA CHECK: CODE CHECK: STRUCTURAL: UTILITIES DIR:


PLANNING DIR: **CLIENT APPROVAL** 

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**LEVEL 2 FLOOR** PLAN

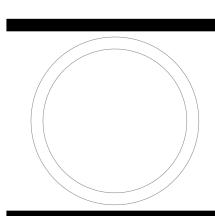WORK ORDER & SHEET NO.



1

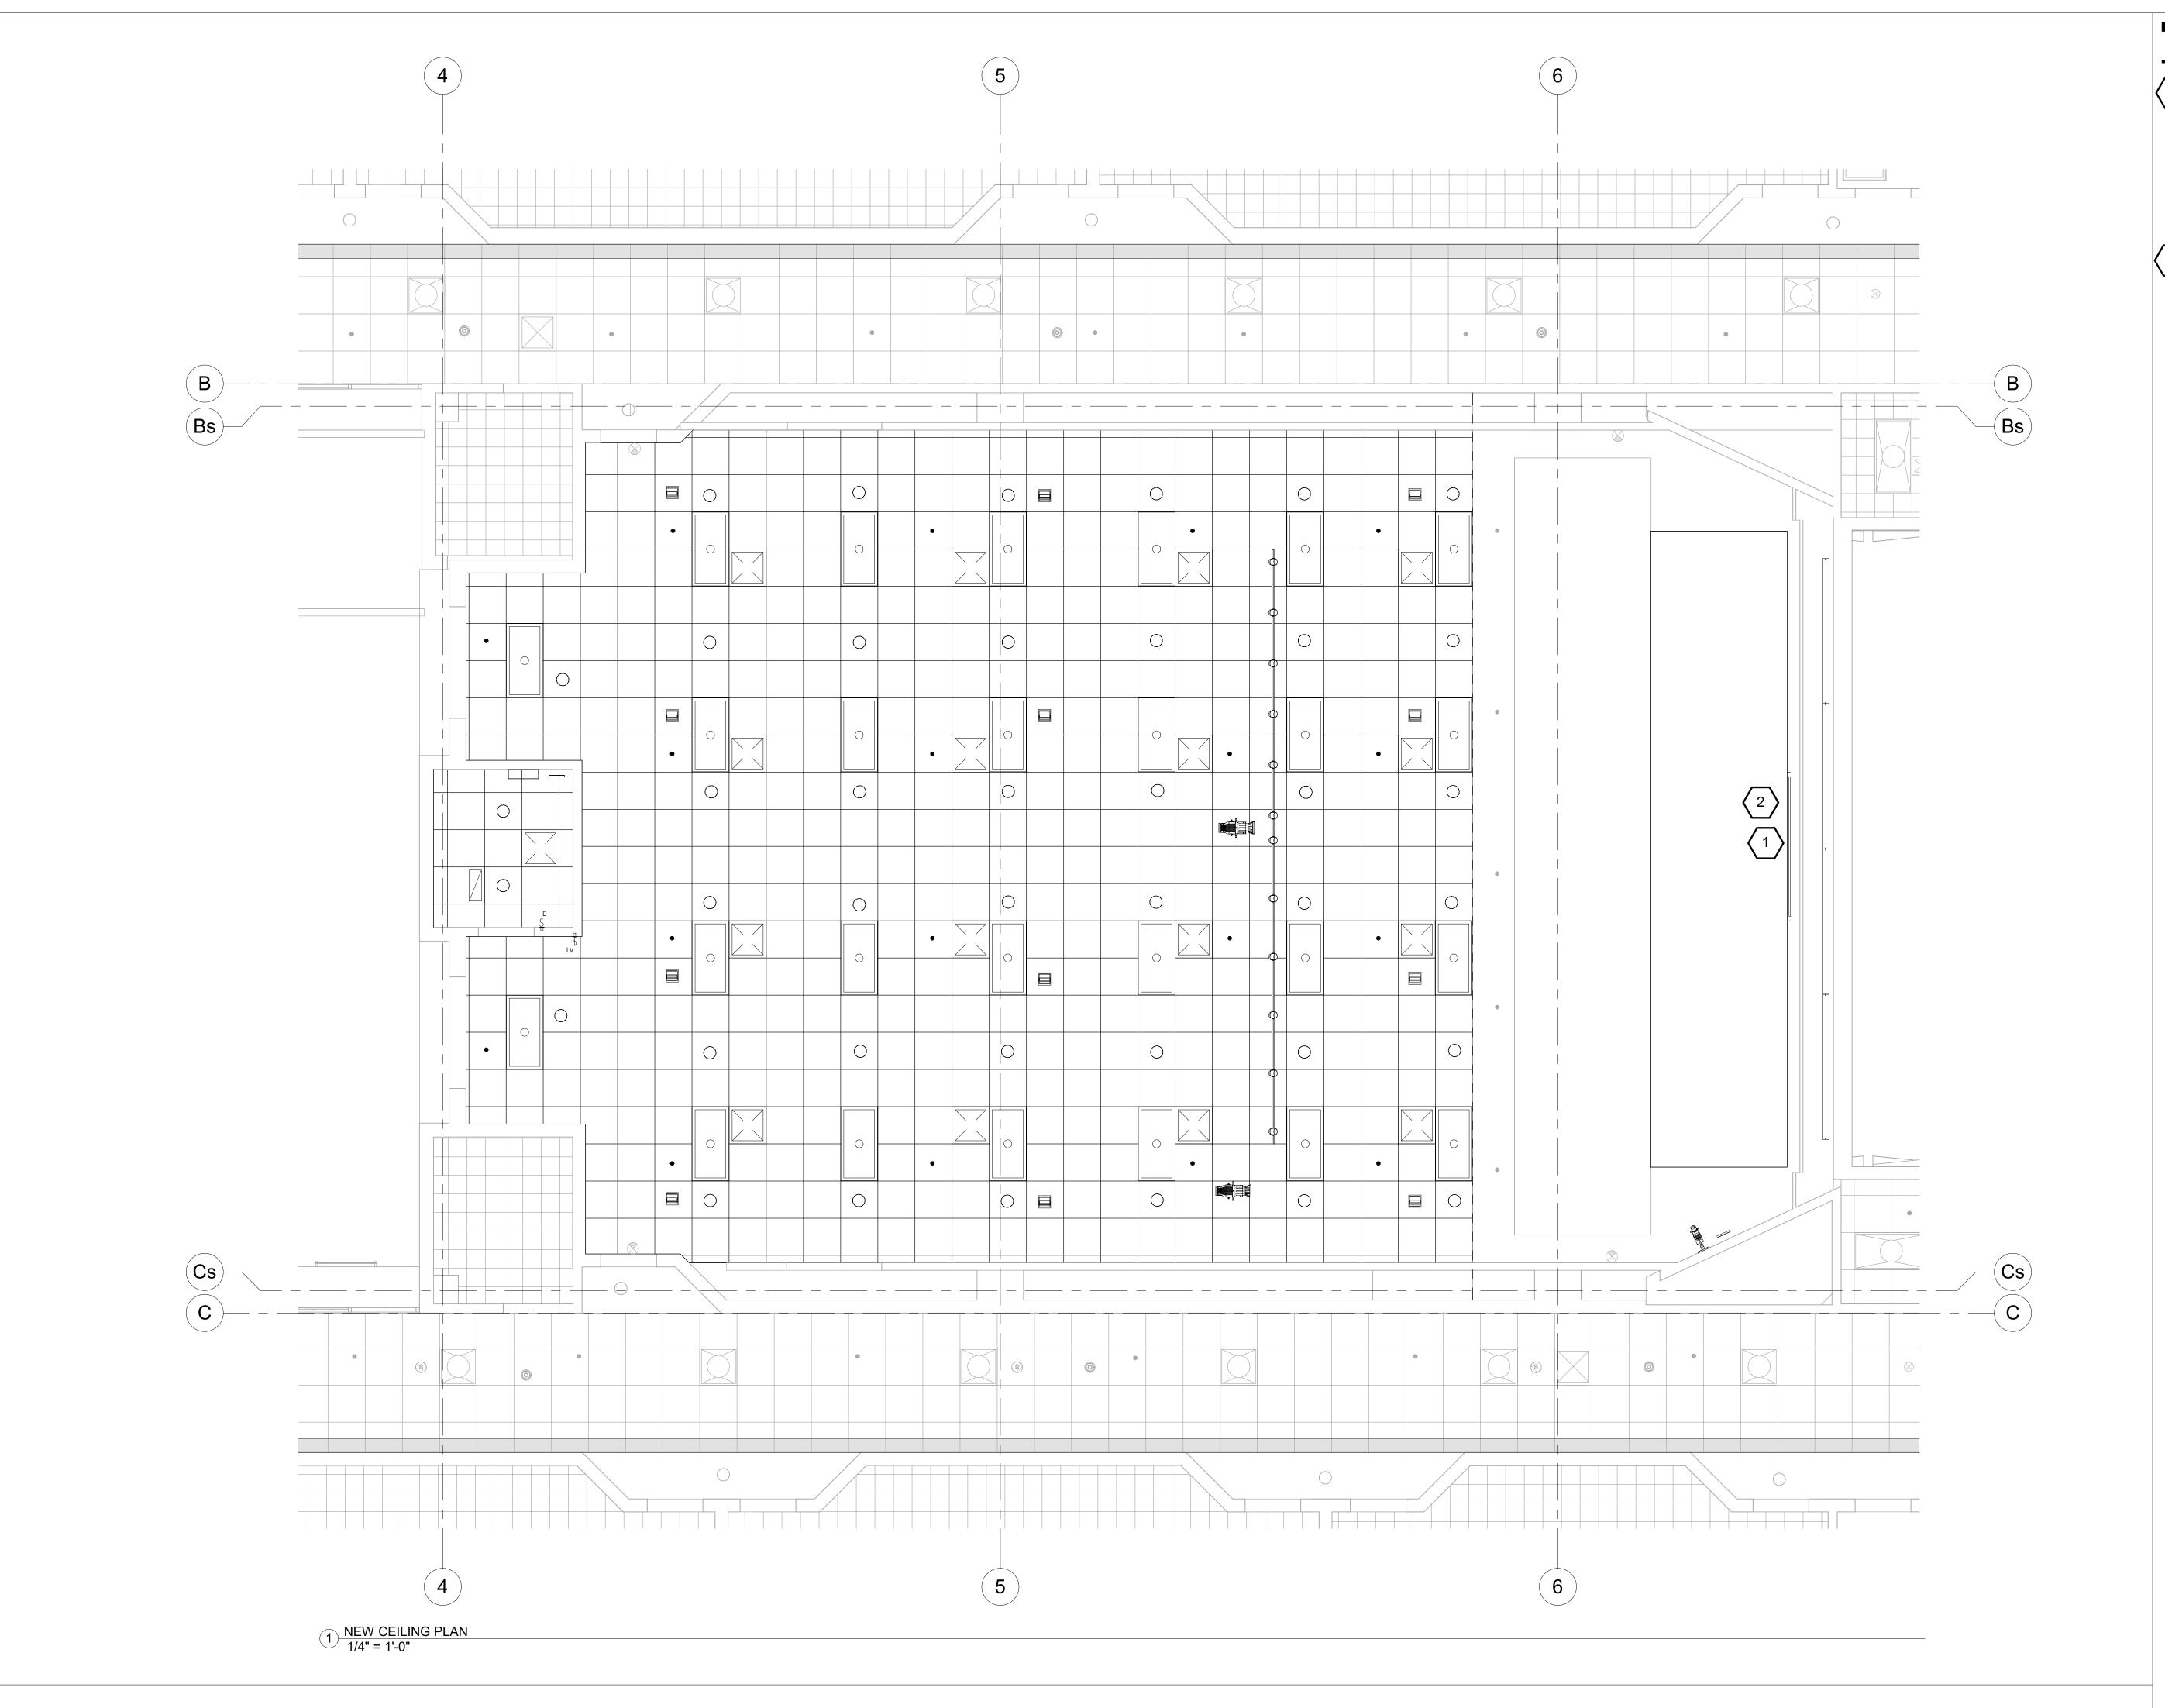Office of IT: Install new projector, mount and cabling to podium

Electrical Contractor: Install (1) TVSS power outlet above cloud for projector, (1) 1" conduit with bushing from projector location to podium



Office of IT: Purchase and provide new projection screen

Contractor: Install new projection screen; an 8" depth is required between lower cloud and wall for projection screen case

Electrical Contractor:
Connect existing power and existing screen control to new projection screen



FACILITIES PLANNING

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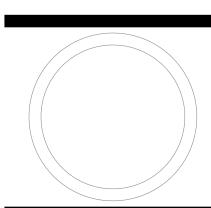
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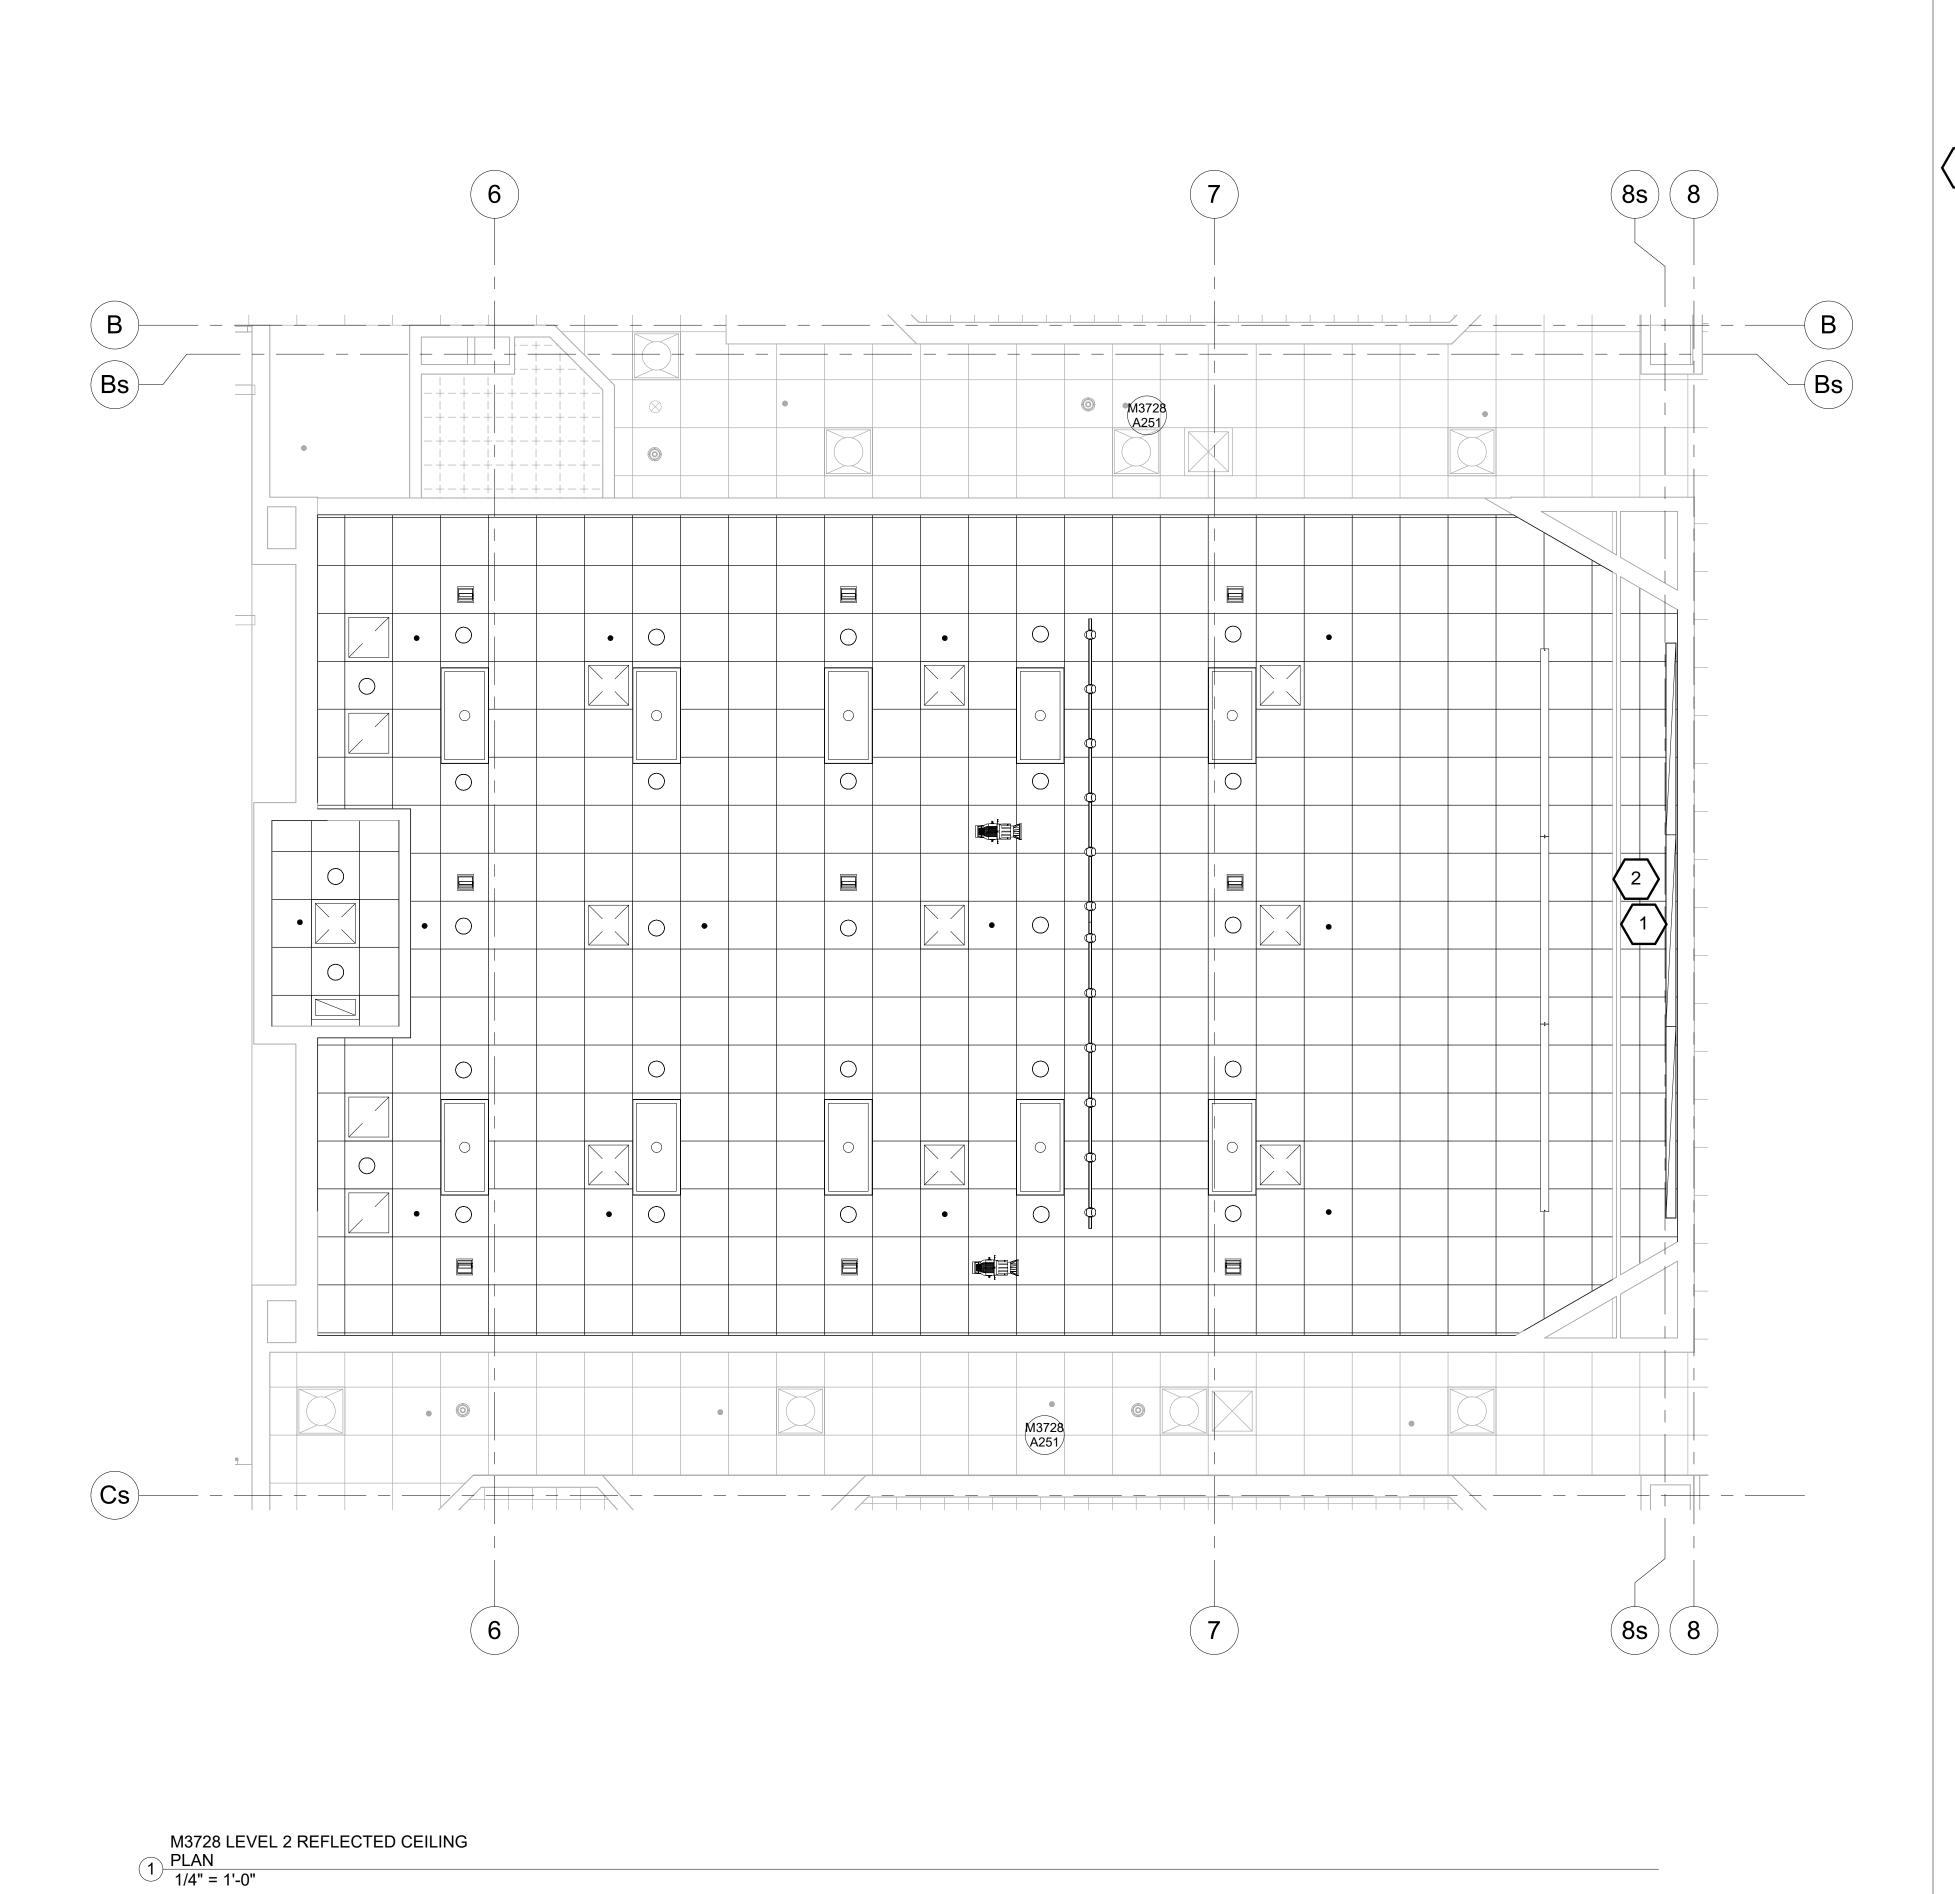
EMODEL AUDITORIUM 151
PHYSICAL FACILITIES



LEVEL 1 REFLECTED CEILING PLAN

WORK ORDER & SHEET NO.

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Office of IT: Install new projector, mount and cabling to podium

Electrical Contractor: Install (1) TVSS power outlet above cloud for projector, (1) 1" conduit with bushing from projector location to podium



Office of IT: Purchase and provide new projection screen

Contractor: Install new projection screen; an 8" depth is required between lower cloud and wall for projection screen case

Electrical Contractor: Connect existing power and existing screen control to new projection screen



FACILITIES PLANNING

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DRAWN BY:	TS/	

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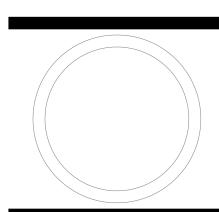
CLIENT APPROVAL DATE

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LEVEL 2 REFLECTED CEILING PLAN

WORK ORDER & SHEET NO.

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